

# SITE DATA:

APN: 037-084-190 ZONING: R-1/S-17/DR/CD OCCUPANCY GROUP: R-3/U TYPE OF CONSTRUCTION: V-B

PLN: PLN2023-00150

APPLICABLE CODES: SAN MATEO COUNTY ZONING & BUILDING ORDINANCES

2019 CALIFORNIA RESIDENTIAL CODE

2019 CALIFORNIA MECHANICAL CODE 2019 CALIFORNIA PLUMBING CODE 2019 CALIFORNIA ELECTRICAL CODE 2019 CALIFORNIA ENERGY CODE

2019 CALIFORNIA FIRE CODE 2019 CALIFORNIA GREEN BUILDING STANDARDS CODE

OWNER: DEBORAH HIRST & CHRIS MCAFEE 400 SIERRA ST

MOSS BEACH, CA 94038 deborahsuehirst@gmail.com mcafee@mocha.com 650.703.3132

ARCHITECT: EDWARD C LOVE, ARCHITECT 720 MILL ST HALF MOON BAY, CA 94019 edwardclovearch@gmail.com 650.728.7615

CIVIL & GEOTECH: SIGMA PRIME GEOSCIENCES 332 PRINCETON AVE HALF MOON BAY, CA 94402 sigmaprime@gmail.com

STRUCTURAL: SEZEN & MOON STRUCTURAL ENGINEERING INC. 274 E. HAMILTON AVENUE, SUITE C CAMPBELL, CA 95008 408.871.7274 smseinc@aol.com

650.728.3590

FREDRIC V. ALLEN, INC. 1650 BOREL PLACE, SUITE 209 SAN MATEO, CA 94402 650.345.7566

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		EXISTING			PROPOSED			TOTAL			Д	LLOWED	
		AREA (S	GQFT)	%	AREA	(SQFT)	%	AREA (S	SQFT)	%	AREA	(SQFT)	%
LOT AREA	4		8251										
LOT COVER	AGE		2665	32.3	Decks & Bald	ony 218	2.6		2883	34.9		2888	35.0
FLOOR ARI	EA	First Floor Second Floor Garage	1415 302 515		Second Floor Loft	Additions 919 200		First Floor Second Floor Garage	1415 1421 515				
		Total	2232	27.1	Total	1119	13.6	Total	3351	40.6	Total	4373	53.C

SCOPE OF WORK: CONSTRUCTION OF A NEW SECOND STORY ADDITION OVER GARAGE AND REMODEL OF EXISTING SECOND FLOOR

<u>NOTE</u>: 1.

Sheet Name
Cover Sheet
Survey
New Site Plan
Existing Site Plan
Existing Floor Plan
New Floor Plan
Floor Area Ratio
Roof Plan
Elevations - West
Elevations - North & South
Elevations - East
Section
Section

A5.02 Material Sheet

L-3 Planting Plan

L-5 Irrigation Plan

L-6

Concept Plan

MWELO Calculations

Landscape Site Plan

L-2 Existing Conditions

L-7 Construction Details

Sheet List - DD

MOSS BEACH HEIGHTS RSM 6/8 PARCEL MAP VOL. 85/50-52

ASSESSOR'S MAP COUNTY OF SAN MATEO, CALIF.

**REVISIONS** 


EDWARD C. LOVE, ARCHITECT


FOR REVIEW ONLY

12/5/23 SCALE:

| JOB: HIRST-MCAFEE



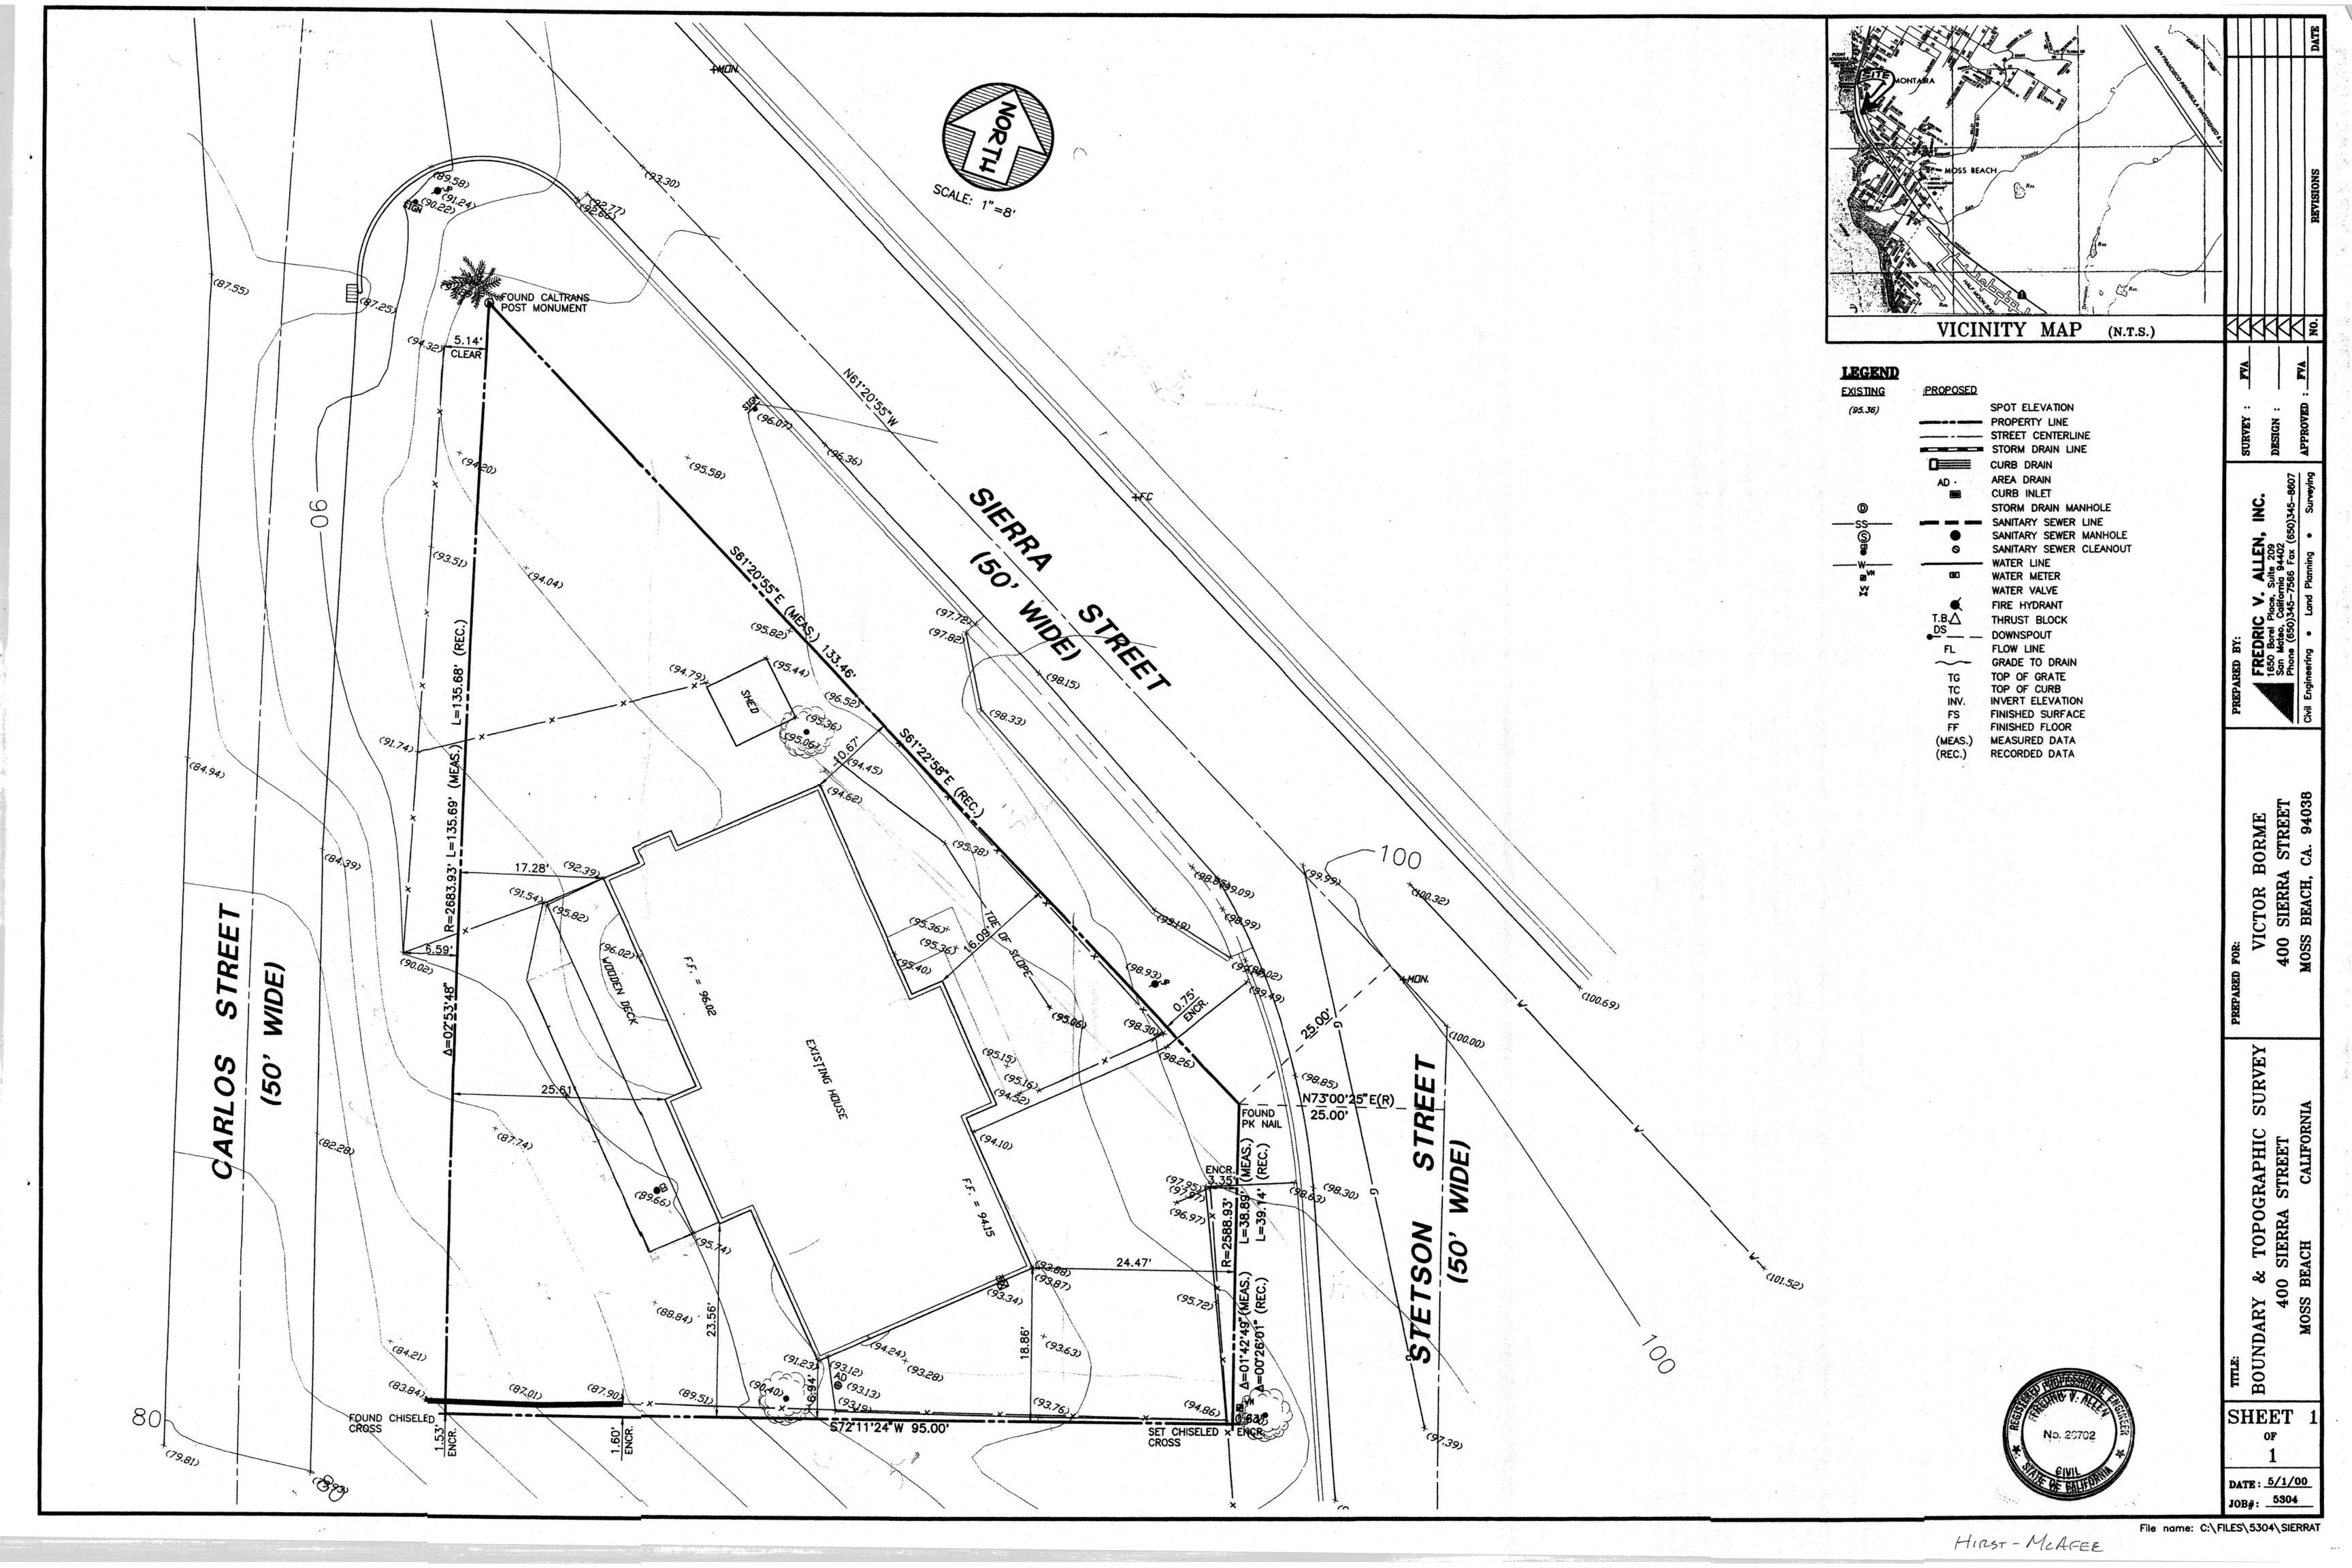

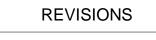

EDWARD C. LOVE, ARCHITECT

 $\frac{\Box}{\Box}$ Existing


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12/5/23 SCALE: |/8" = |'-0"

ECL

JOB: HIRST-MCAFEE

SHEETS

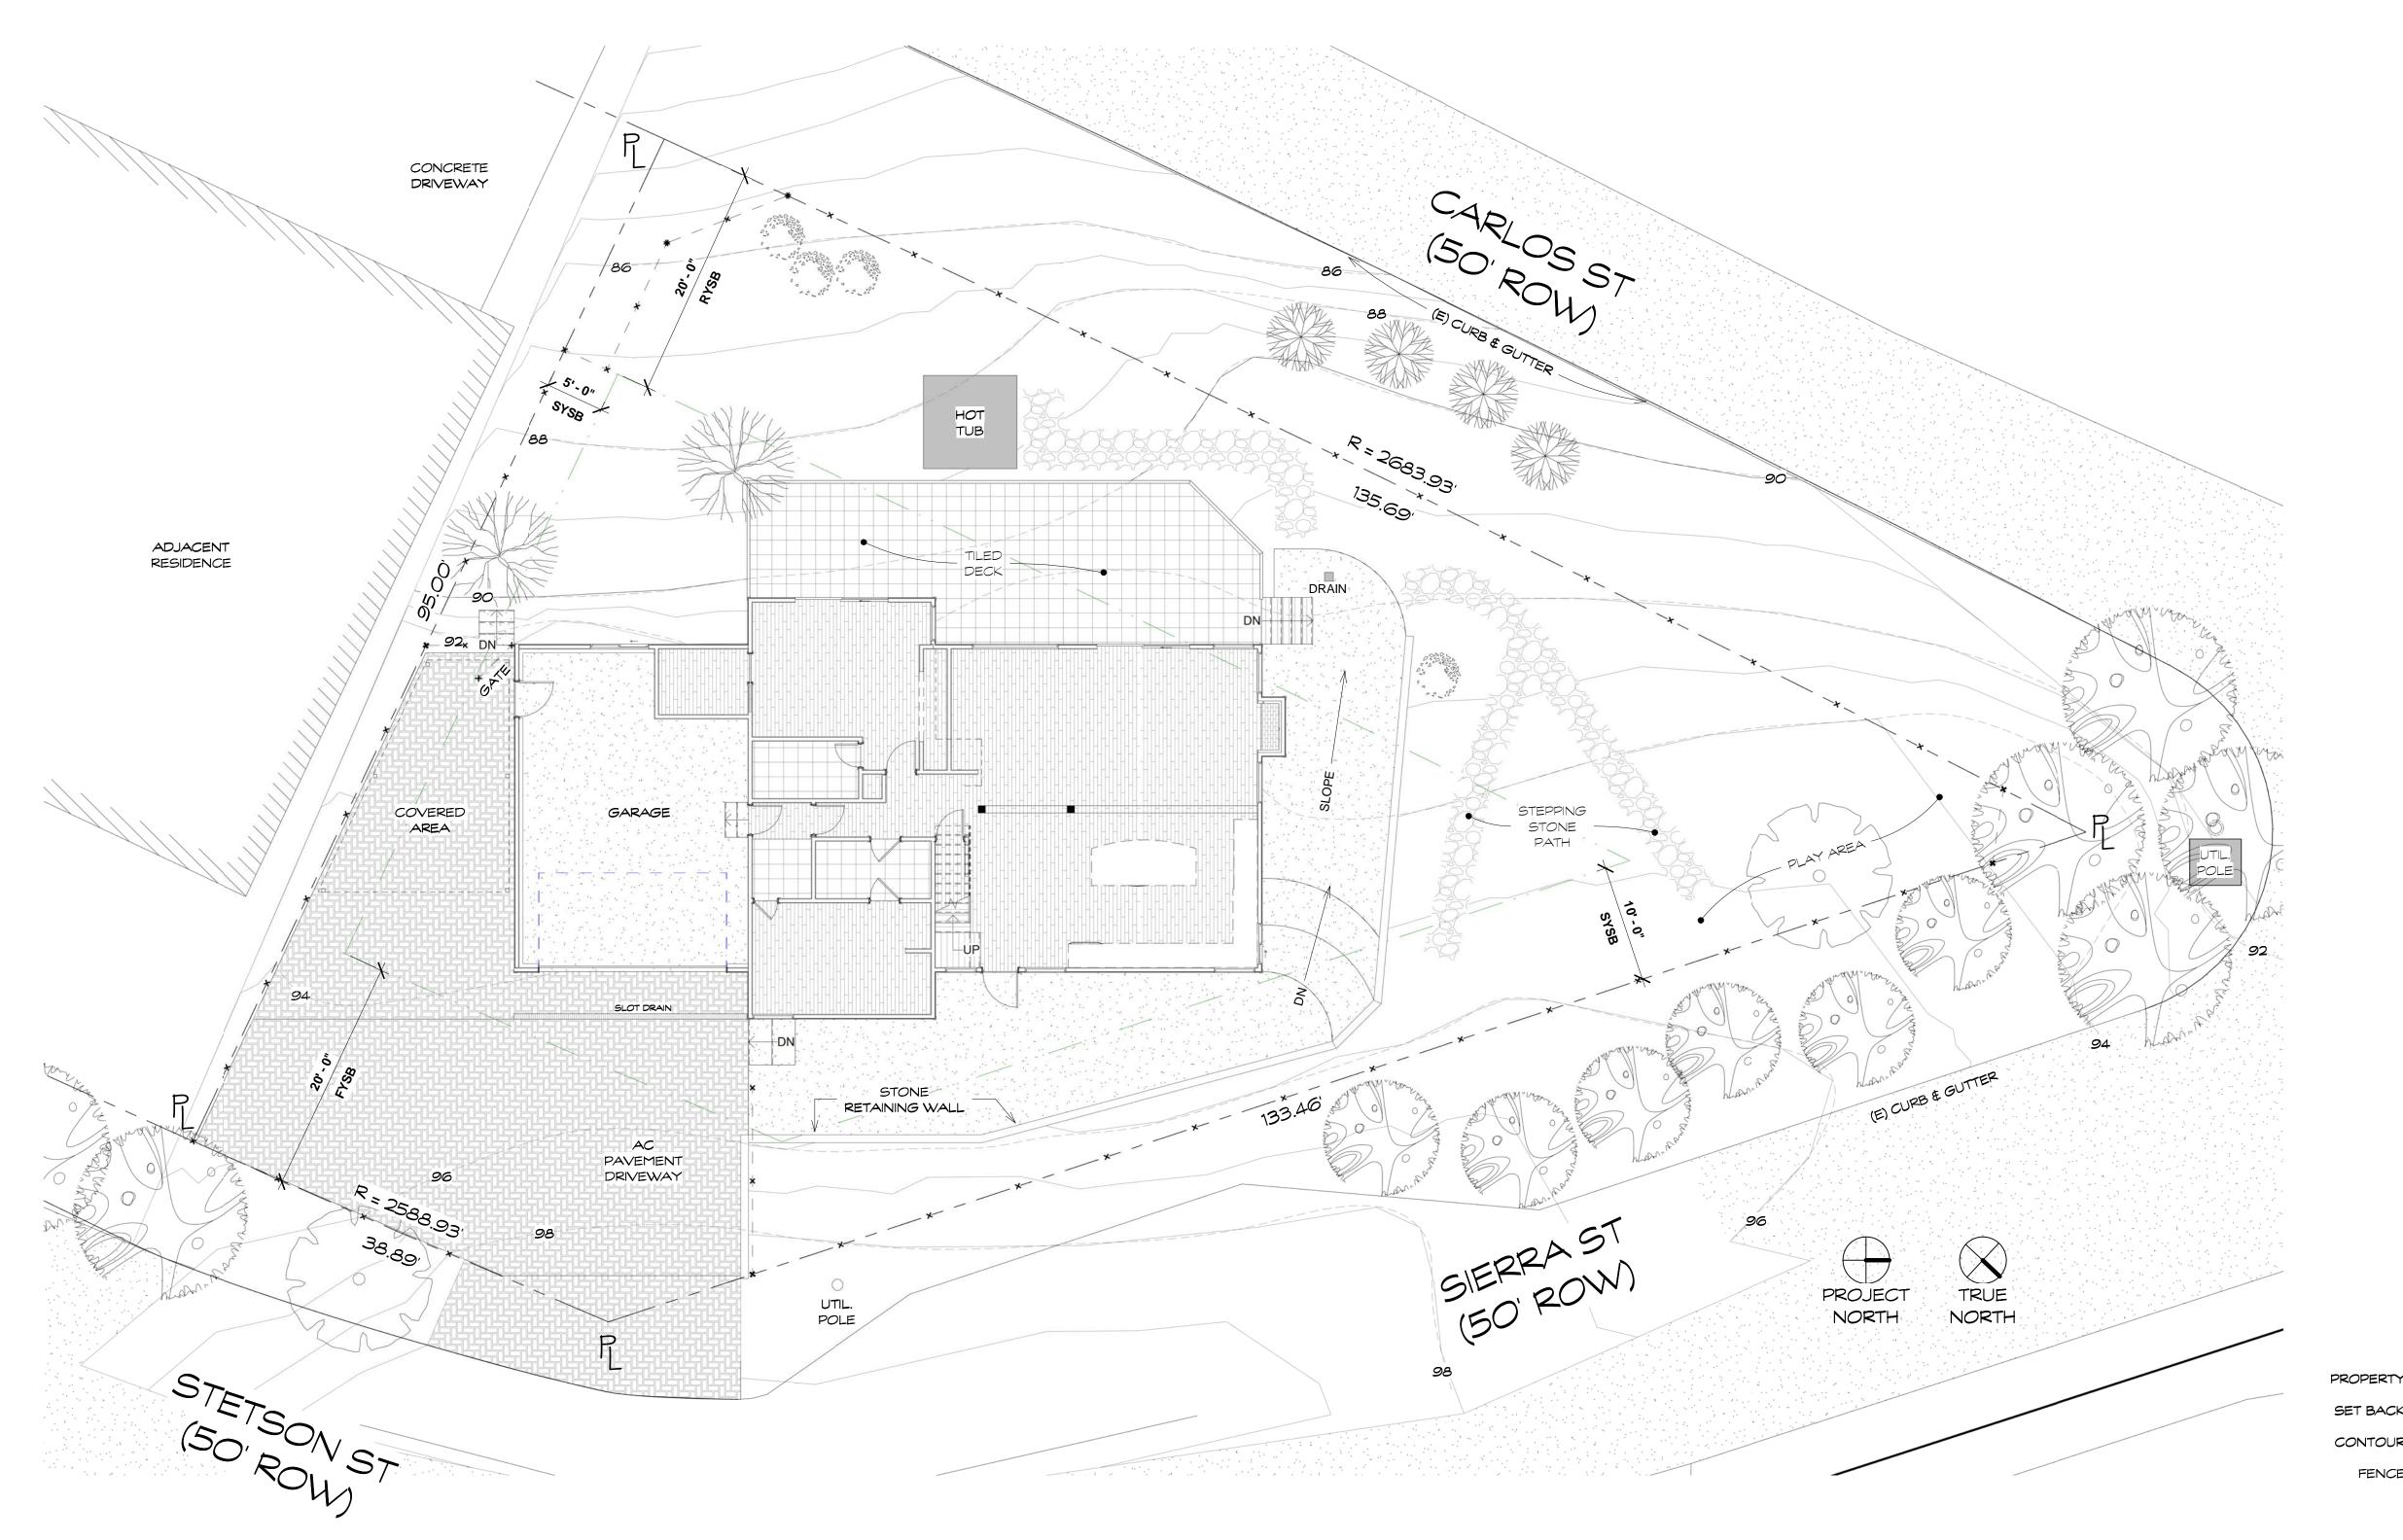

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1 Site - Existing 1/8" = 1'-0"

CONTOUR FENCE \* - - - \* - - - \*

THIS SITE PLAN IS BASED ON BOUNDARY & TOPOGRAPHICAL SURVEY BY FREDRIC V ALLEN, INC DATED MAY 2000


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DRAWN: ECL

JOB: HIRST-MCAFEE

AO.O4

OF SHEETS

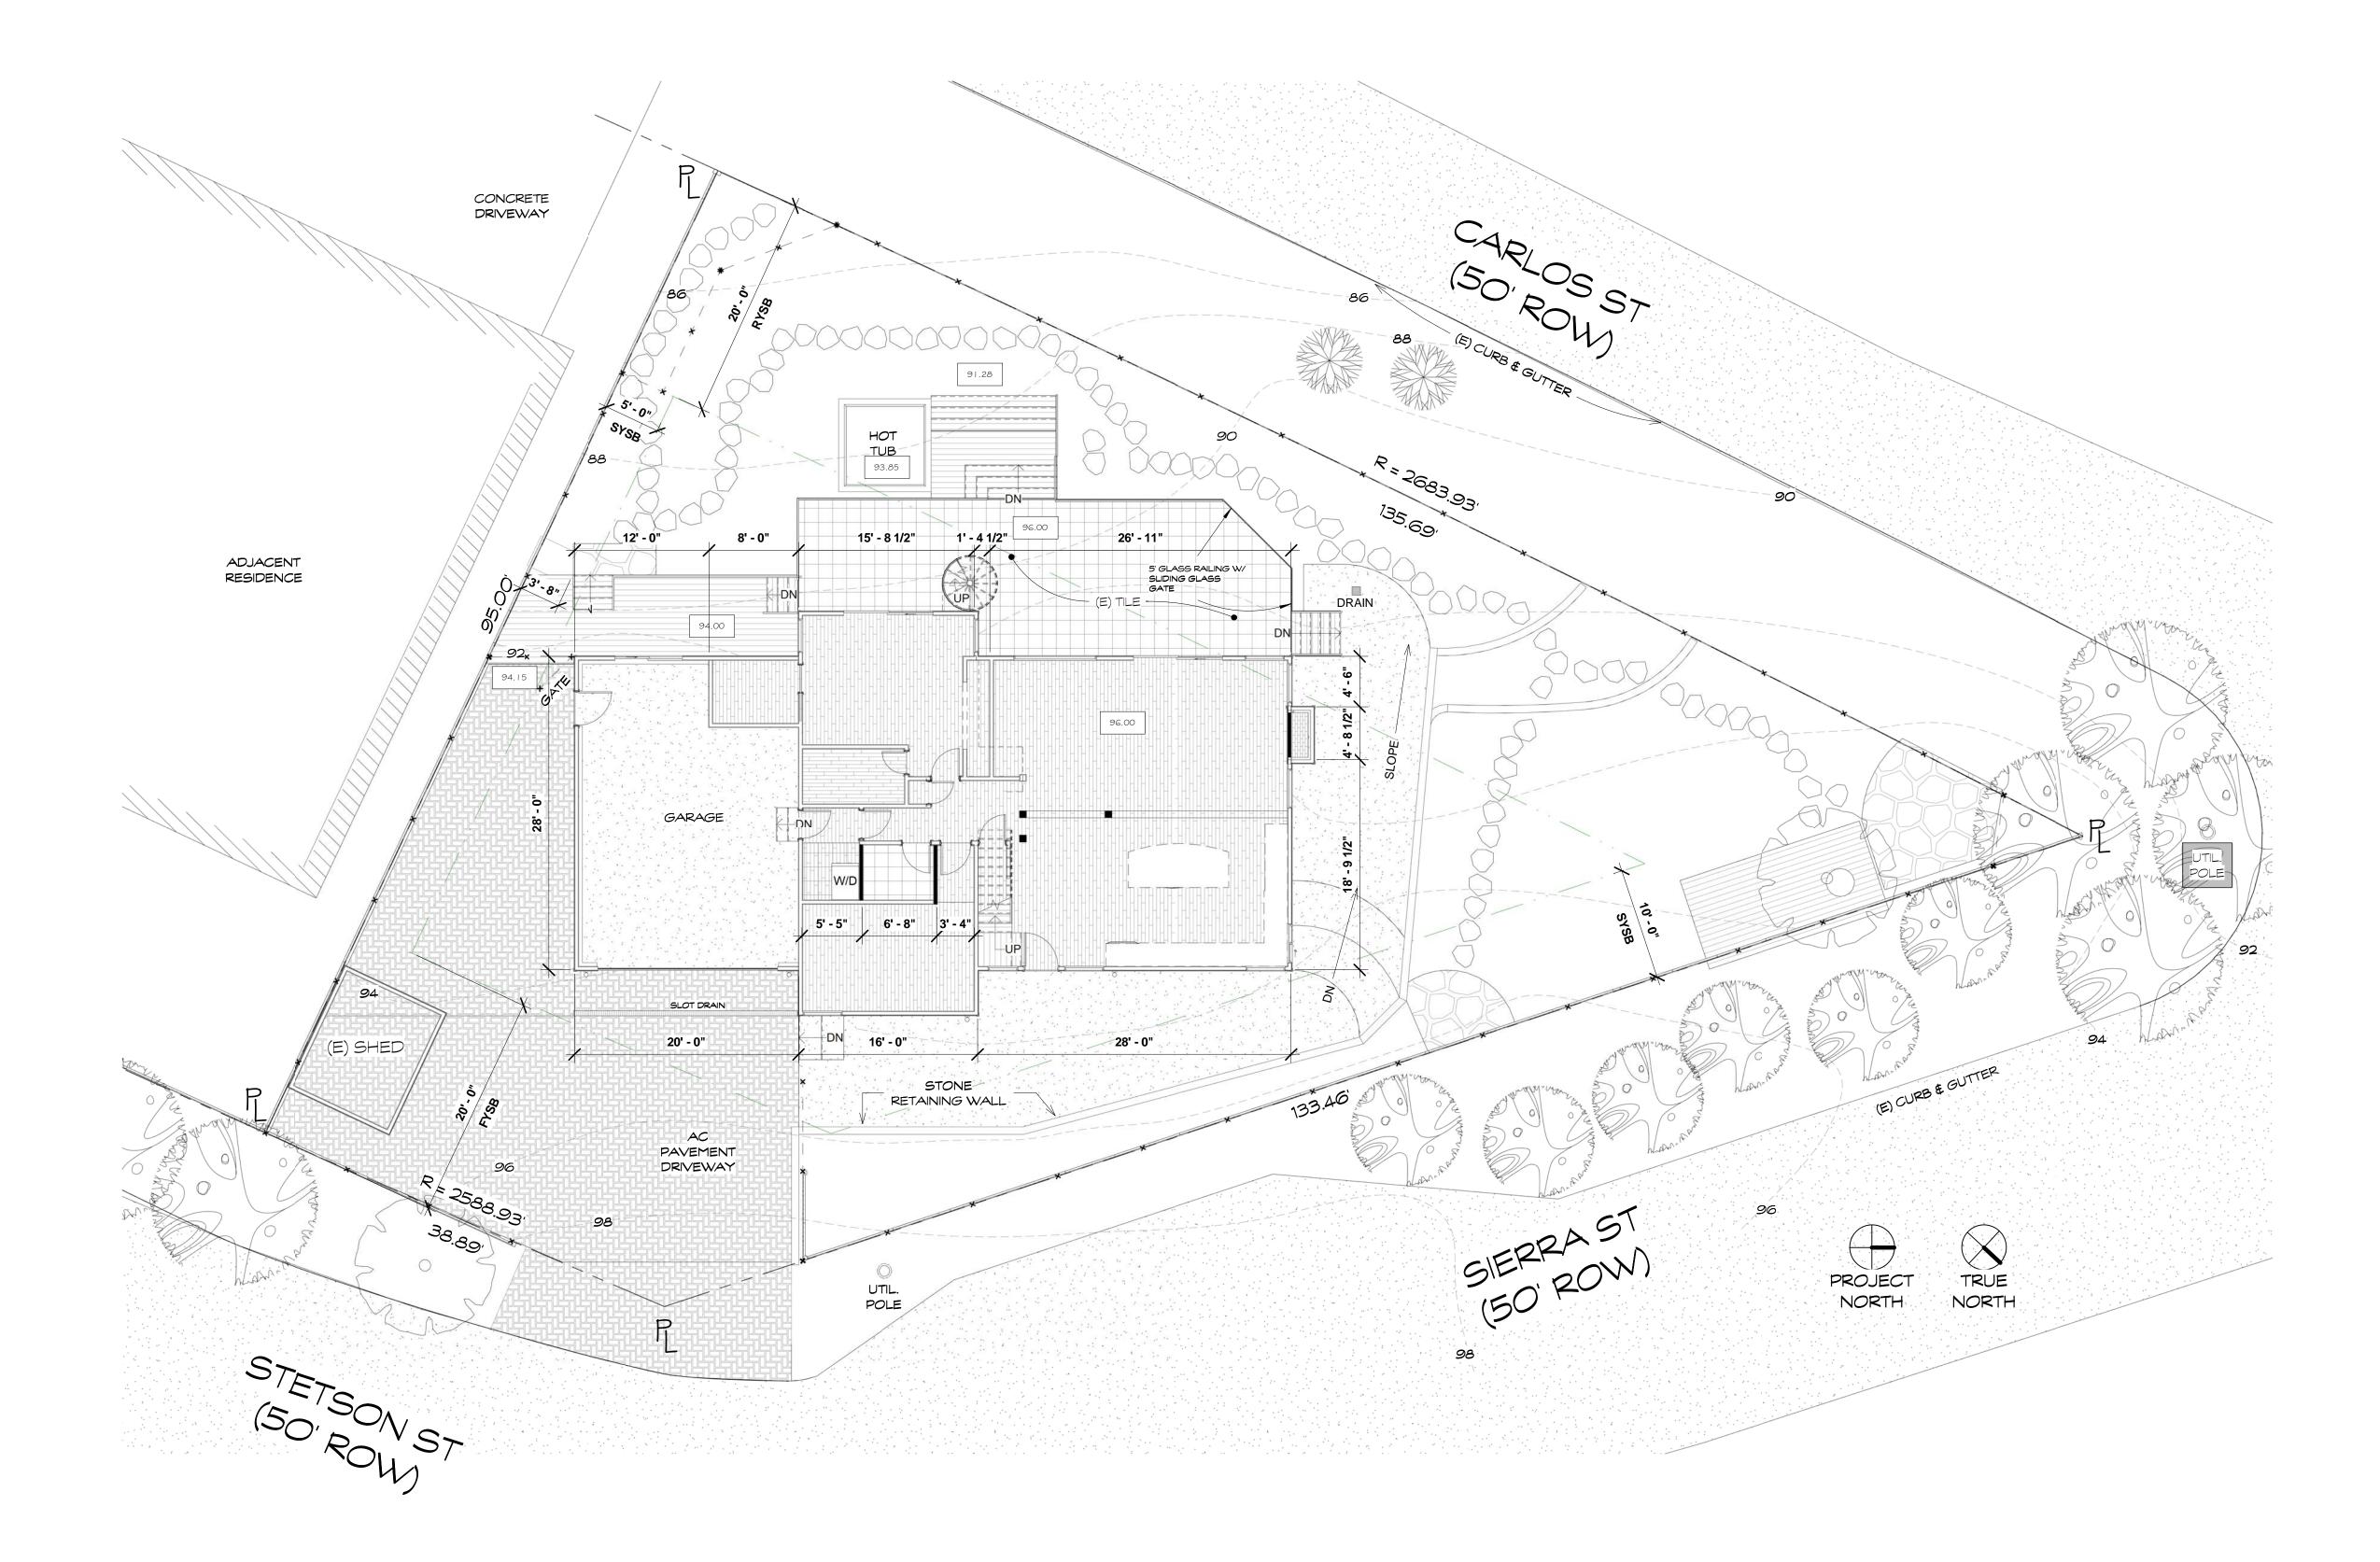



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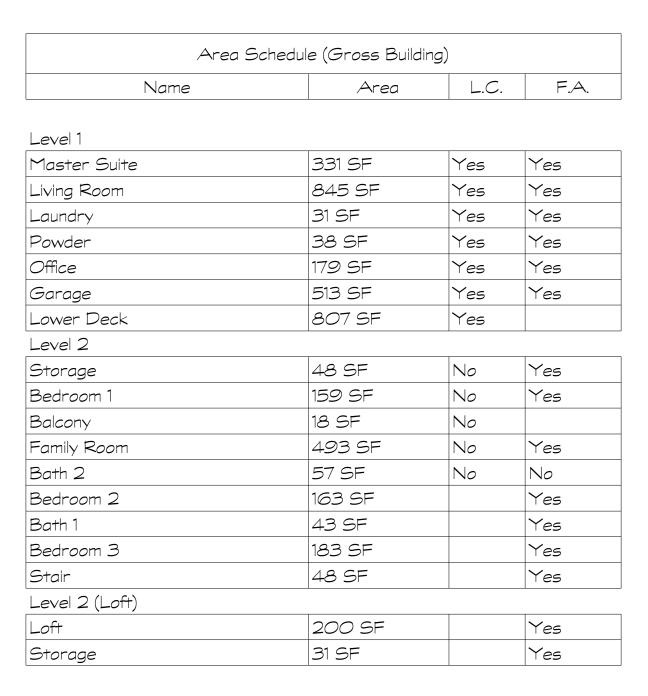
Site - Nev 1/8" = 1'-

THIS SITE PLAN IS BASED ON BOUNDARY & TOPOGRAPHICAL SURVEY BY FREDRIC V ALLEN, INC DATED MAY 2000


SEE LANDSCAPE PLAN FOR PLANTING INFO



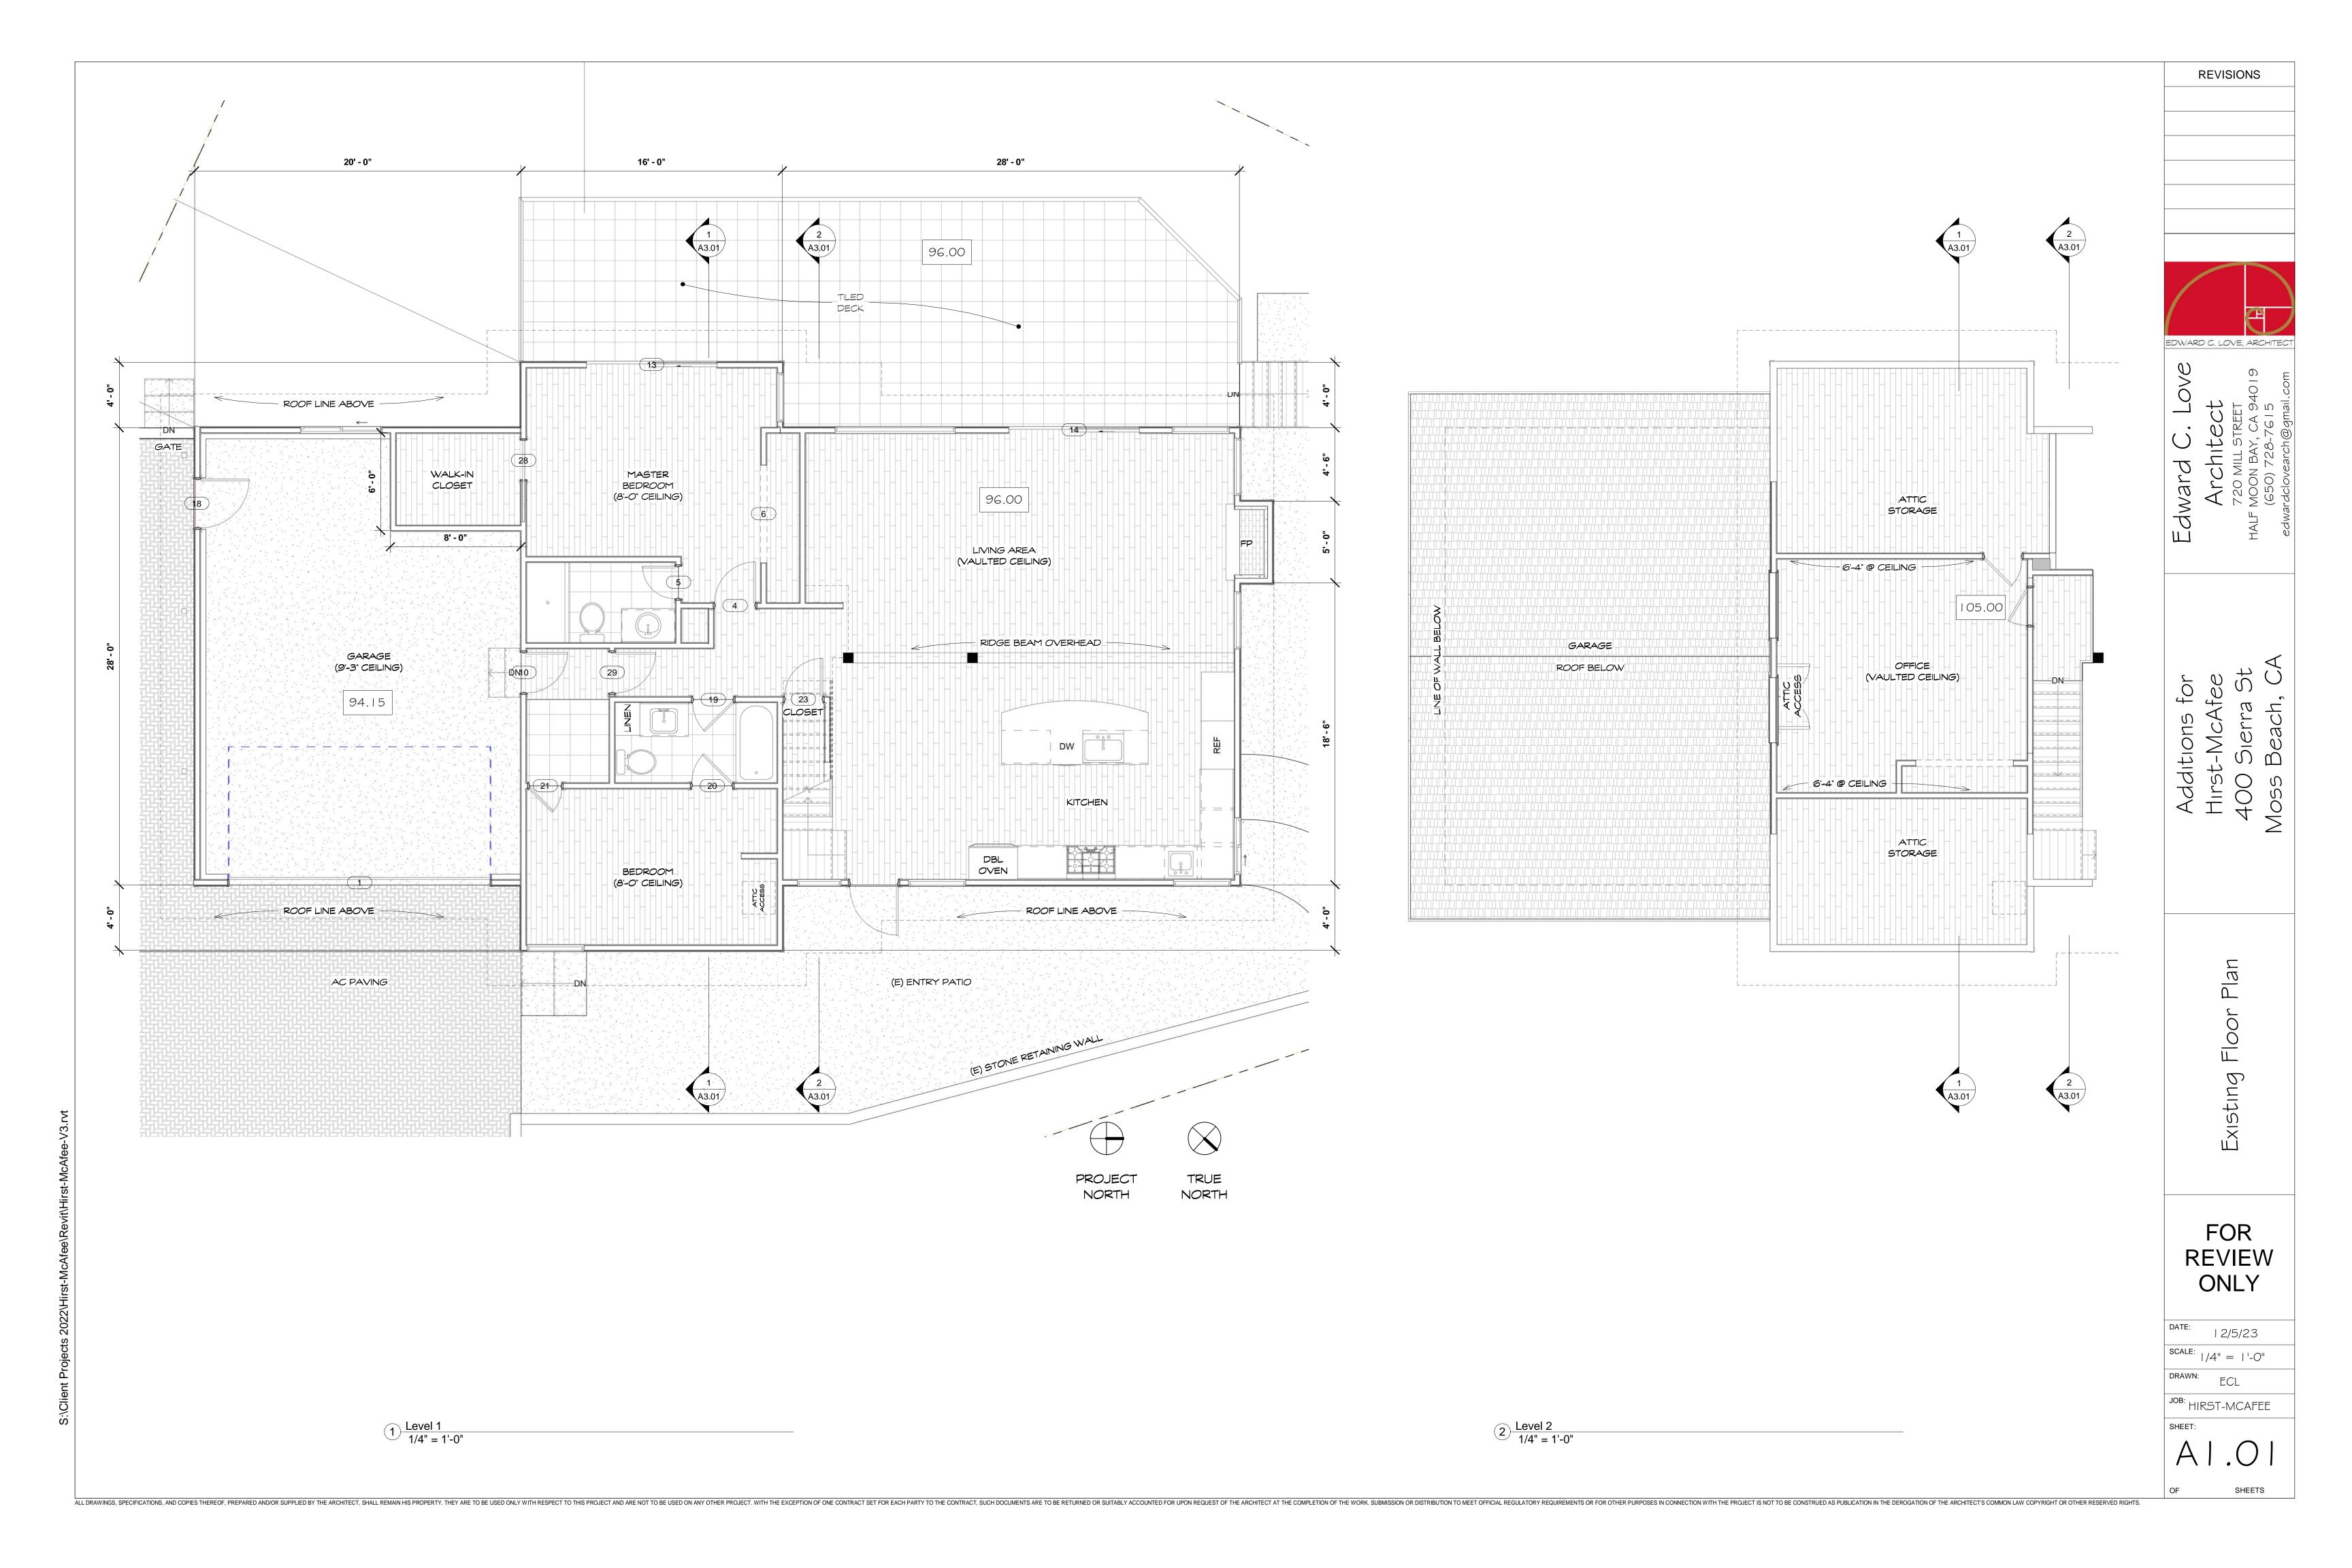

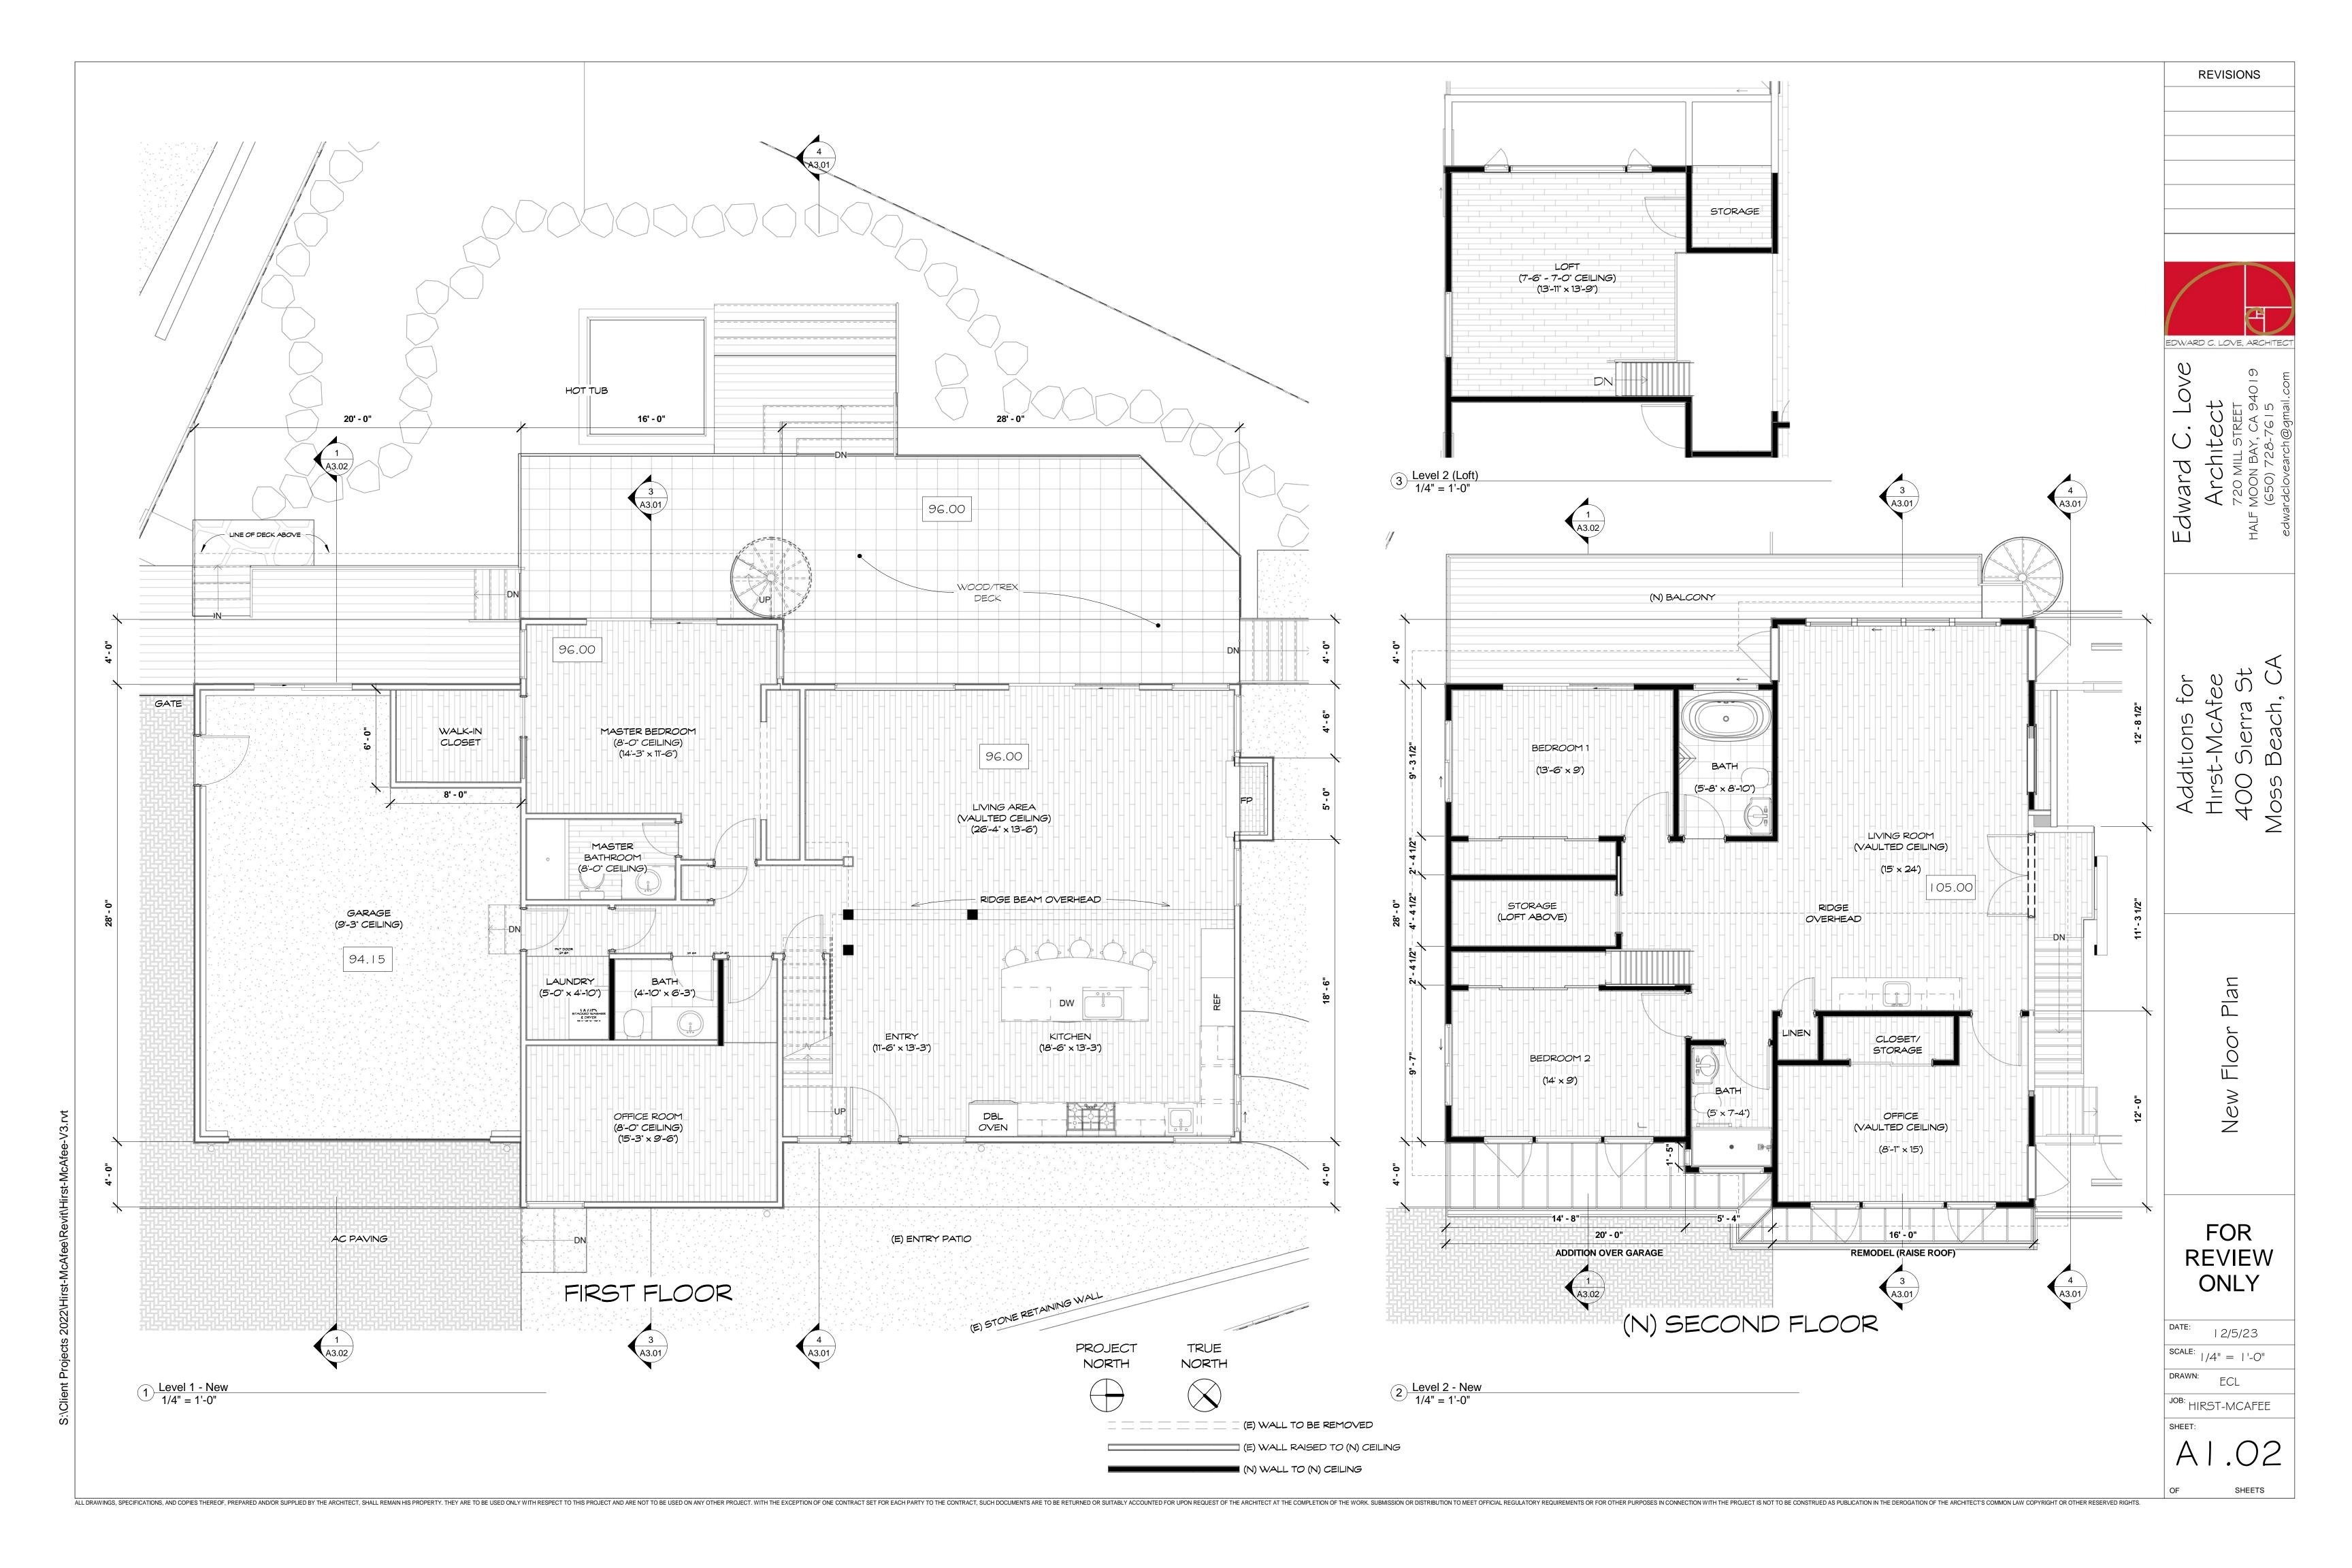



M1		<b>-</b>	****	Litetate	
Mark	Room	Туре	Width	Height	Comments
_evel 6					
121			16' - 0"	7-0"	
			•		•
_evel 0 - Ave	: Grade				
30	Garage	Garage Door	16' - 0"	8' - O'	Existing
31	Garage	Exterior Door	3' - O"	6'-8"	Existing
116	Garage	Sliding Glass Door	6'-0"	6'-8"	New
_evel 1					
4	Master Suite	Hollow Core	2-6	6'-8"	Existing
5	Master Suite	Hollow Core	2' - 0"	6'-8"	Existing
6	Master Suite	Door Opening	0'-0"	0'-0"	Existing
7	Living Room	Entry Door	3'-0"	7-0"	Existing
10	Garage	Garage Door	2-6	6'-8"	Existing
13	Master Suite	Sliding Glass Door	8'-0"	6'-8"	Existing
14	Living Room	Sliding Glass Door	8'-0"	6'-8"	
19			2'-6"	6'-8"	Demo
21			2'-0"	6'-8"	Demo
23	Living Room	Hollow Core	2' - 4"	6'-8"	Existing
28	Master Suite	Pocket Door	2'-6"	6'-8"	Existing
29	Living Room	Hollow Core	2-6	6'-8"	Existing
<i>9</i> 3	Living Room	Hollow Core	2'-0"	6' - 8"	Existing
106	Powder	Hollow Core	2'-6"	6'-8"	New
107	Office	Hollow Core	2' - 8"	6' - 8"	New
120			3' - O"	7-0"	
122			16' - 0"	7-0"	
123			8' - O"	7-0"	
_evel 2					
42	Family Room	4 Panel Glass Slider	12' - 0"	7-0"	New
74	Bedroom 3	Hollow Core	3' - O"	6'-8"	New
76	Bedroom 1	4 Panel Slider	8'-0"	6' - 8"	New
77	Bedroom 2	4 Panel Slider	8'-0"	6'-8"	New
79	Bedroom 1	Hollow Core	2' - 8"	6'-8"	New
80	Bath 2	Hollow Core	2'-6"	6' - 8"	New
81	Storage	Pocket Door	2' - 4"	6'-8"	New
83	Bedroom 1	Sliding Glass Door	8'-0"	7-0"	New
84	Bedroom 3	Int. Slider wood Panel	5' - 0'	6'-8"	New
111	Bedroom 2	Hollow Core	2' - 8"	6'-8"	New
113	Bath 2	Hollow Core	2' - 8"	6'-8"	New
114	Family Room	Hollow Core	2'-0"	6'-8"	New
119	Family Room	Int. Full Lite French	5'-0"	7-0"	New
-	, , , , , , , , , , , , , , , , , , , ,	Doors	1		

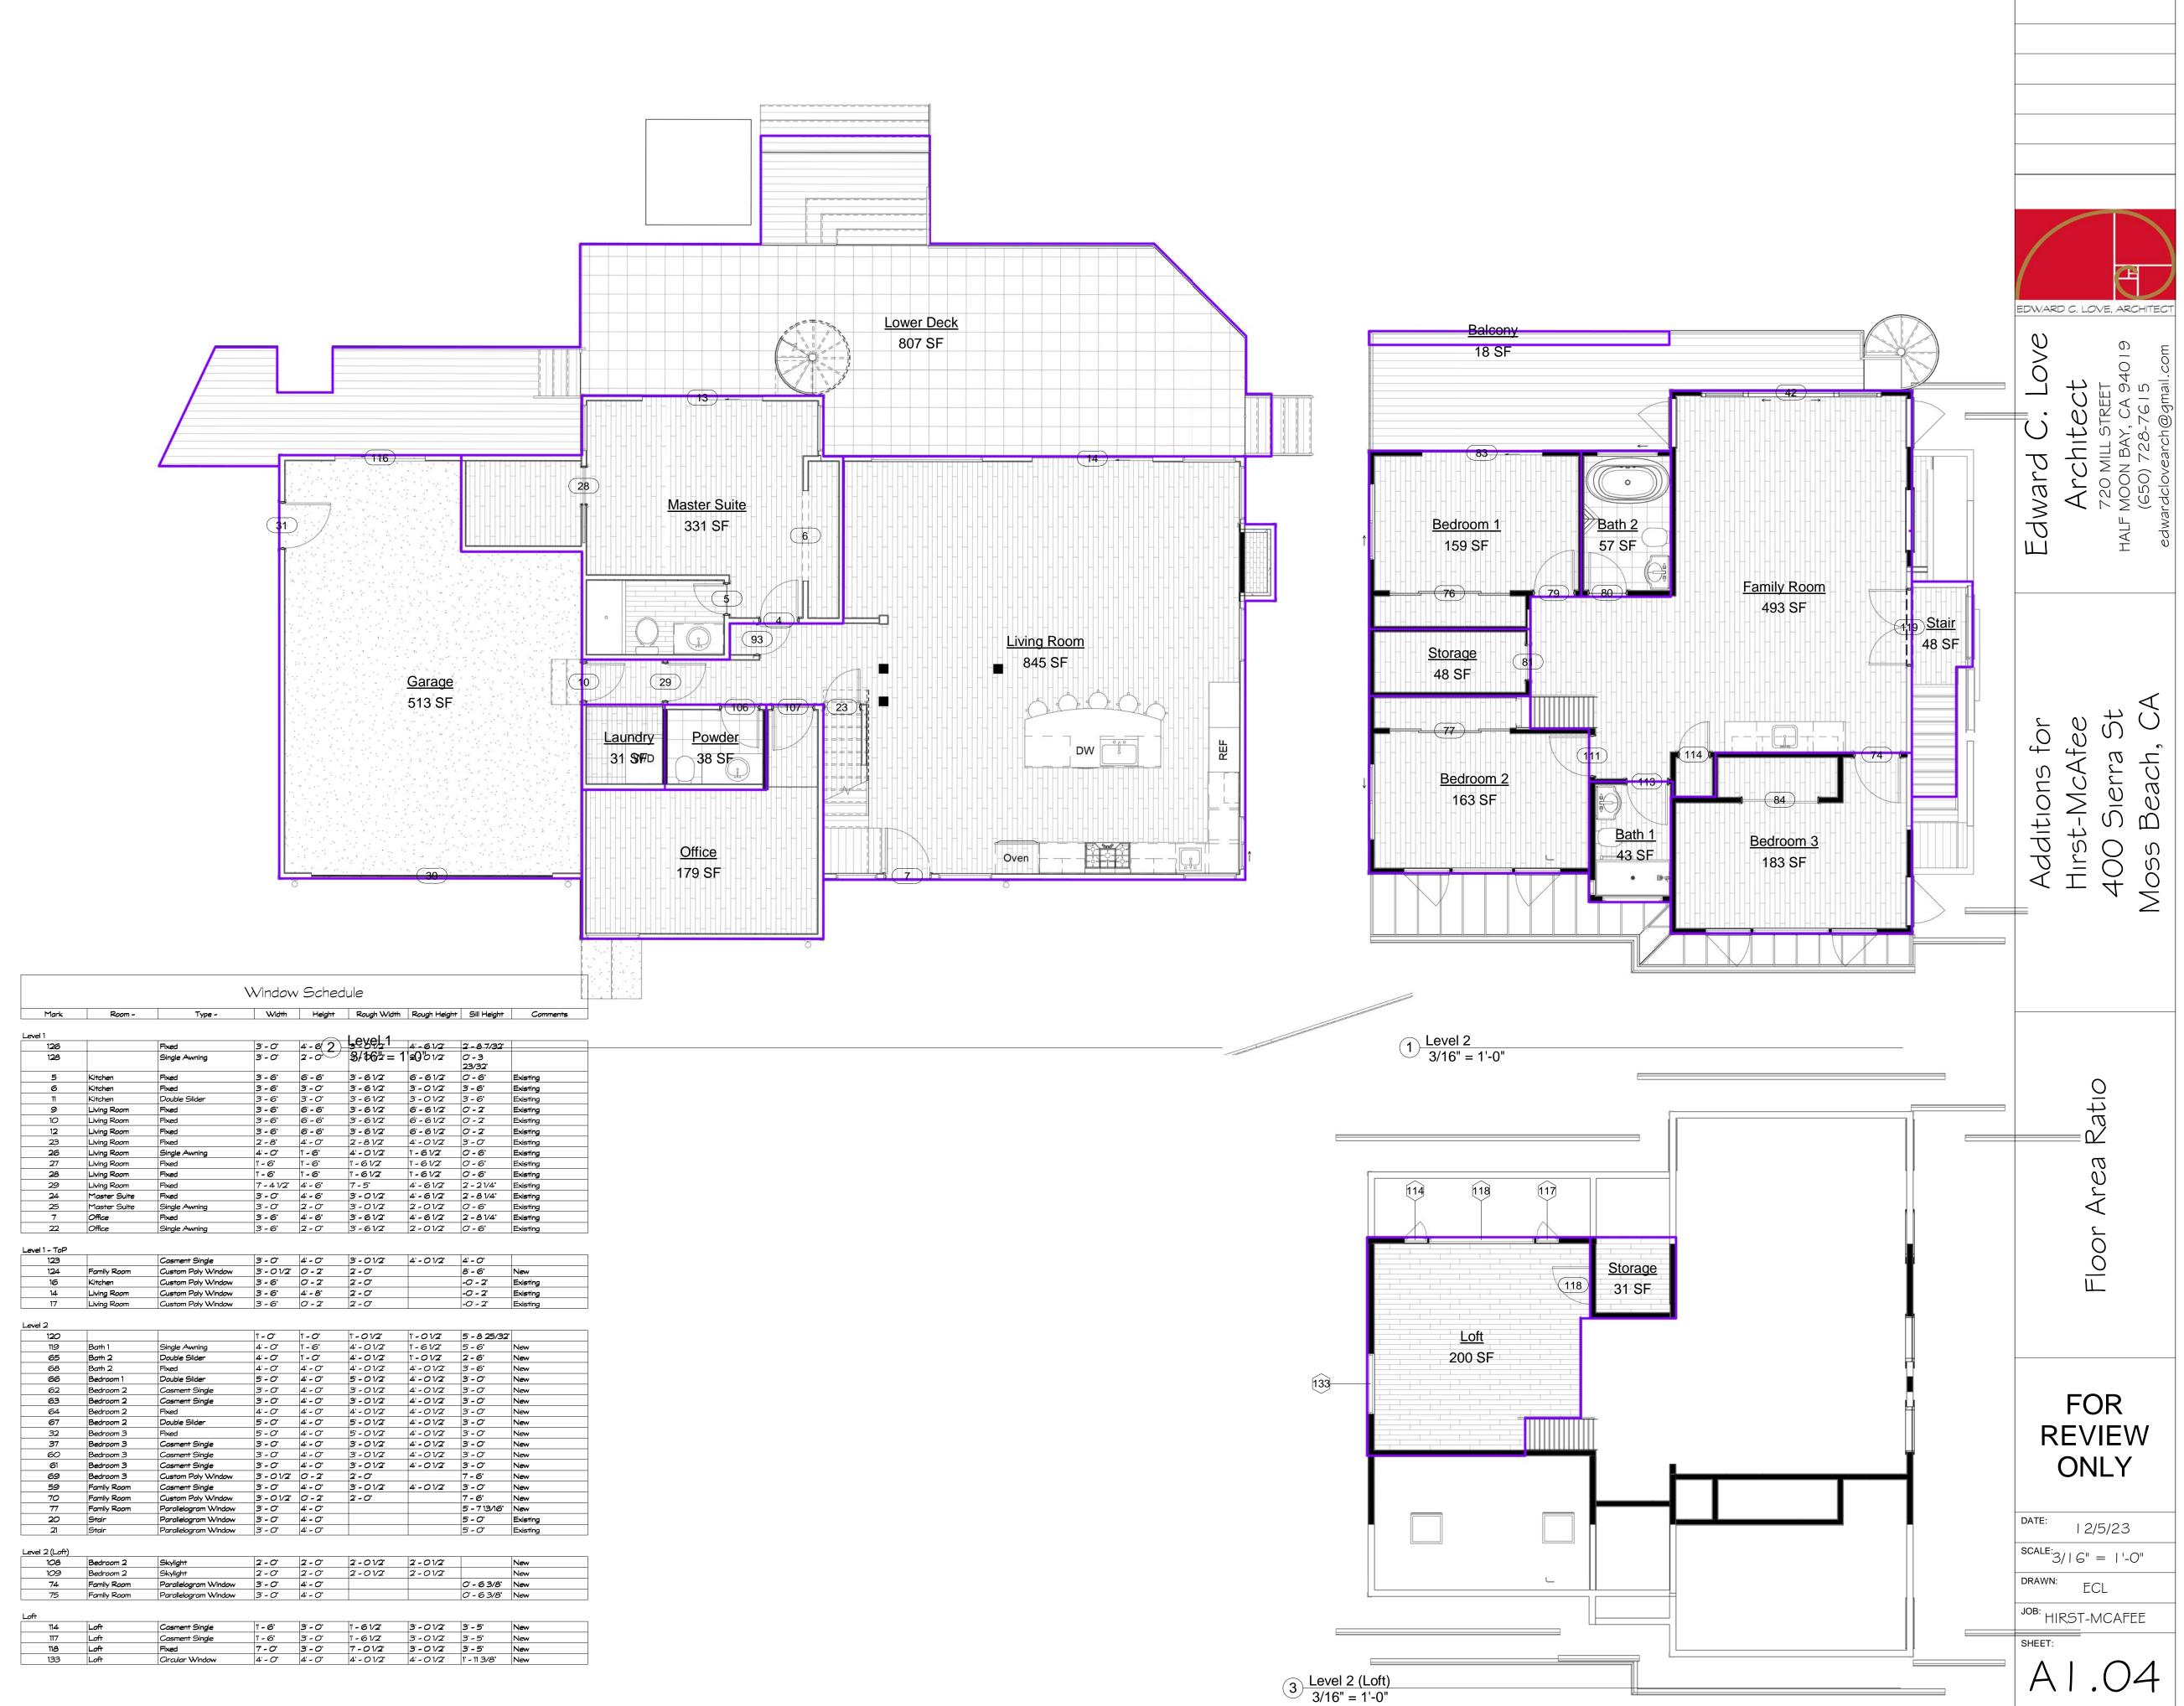

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**REVISIONS** 



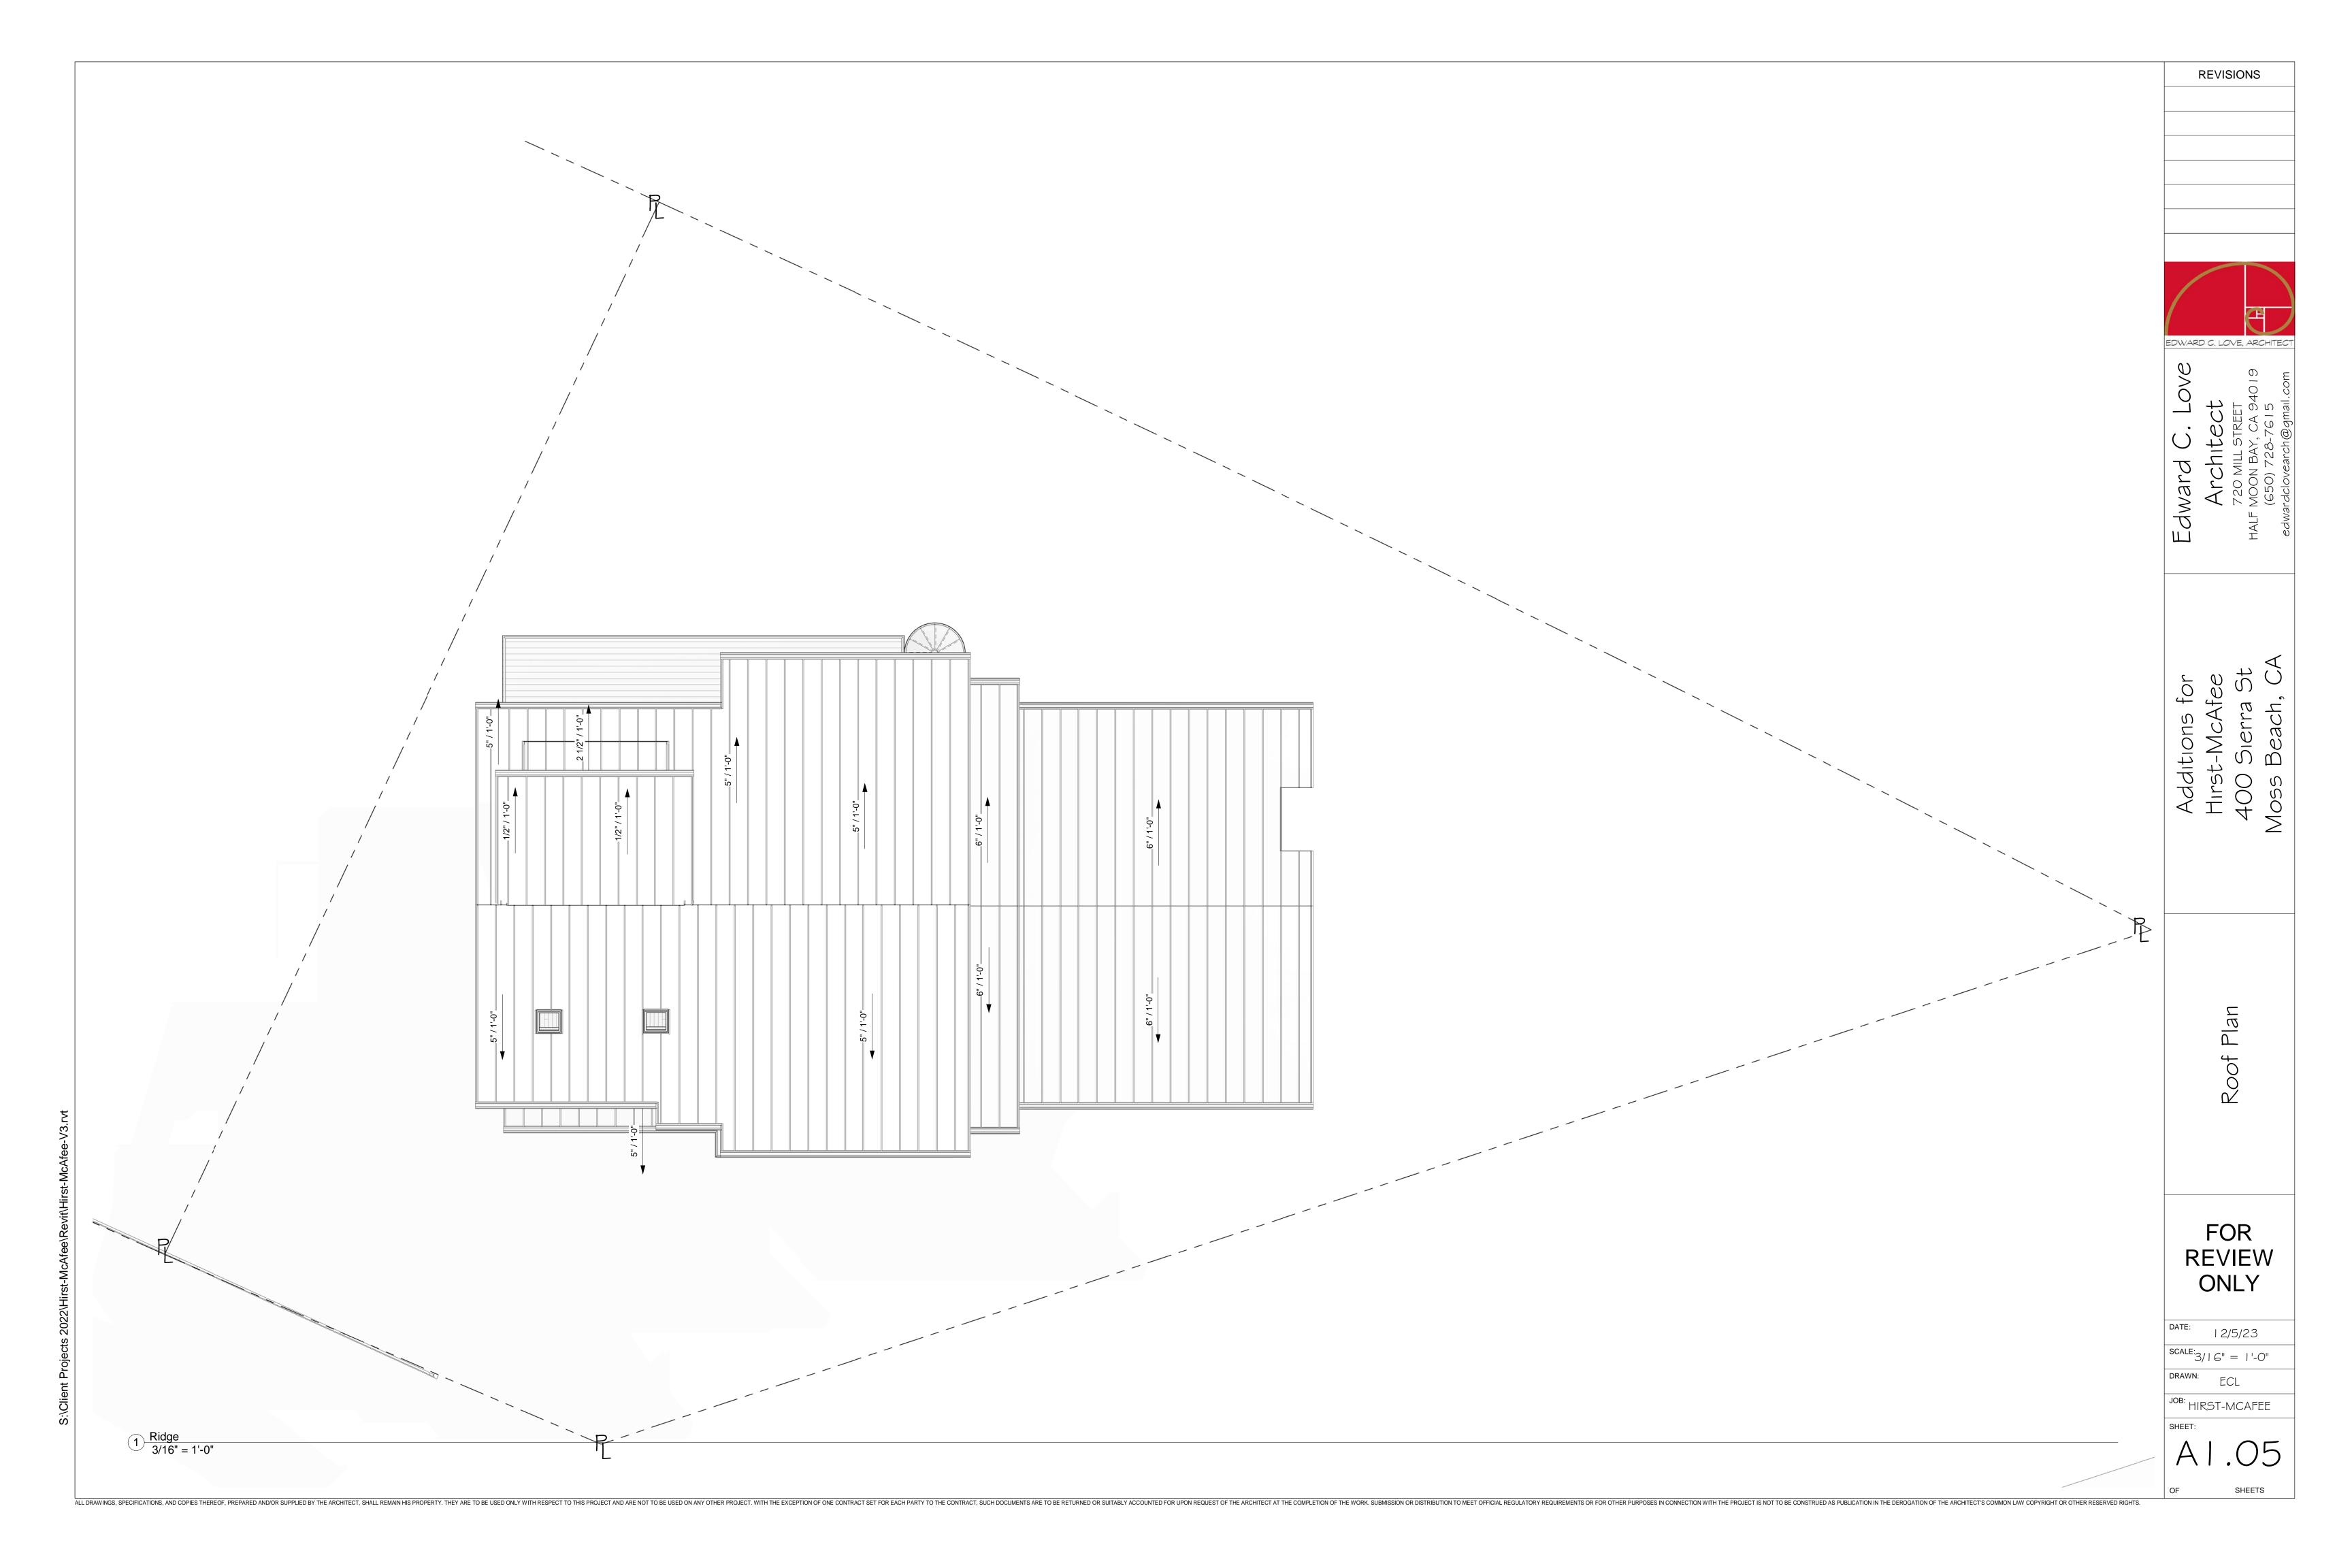

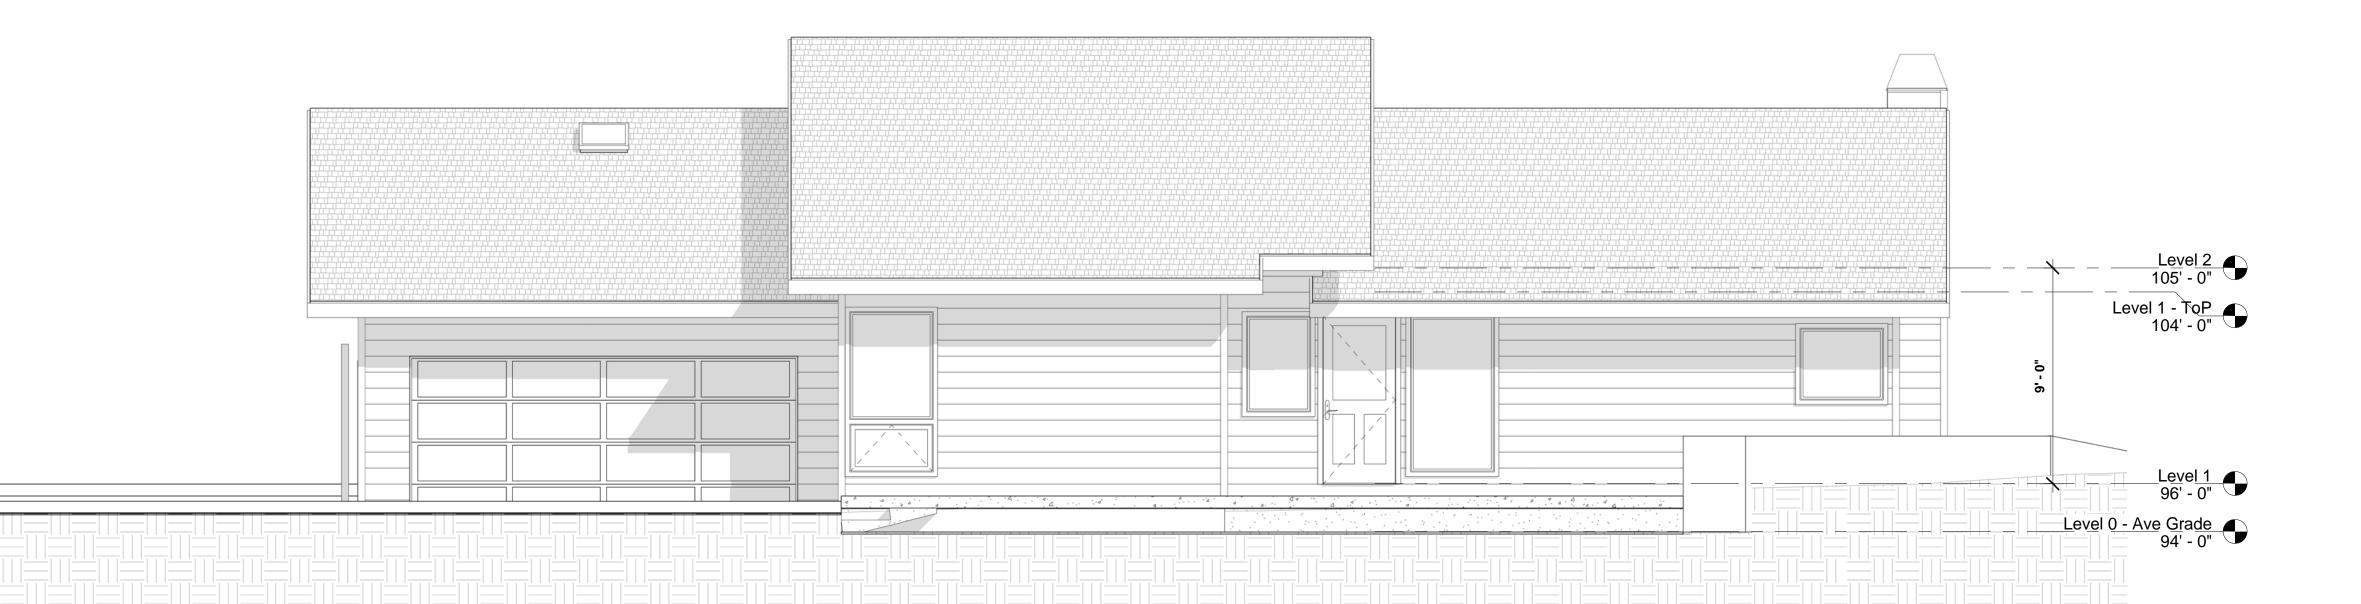2 East (Front) - Existing 1/4" = 1'-0"



1) East (Front) - Proposed 1/4" = 1'-0"

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LOVE ASPACIS AND STATE TO CT SEET SA 94019 SI 5 Amail.com

Edward C. Love
Architect
720 MILL STREET

Additions for Hirst-McAfee 400 Sierra St Moss Beach, CA


Elevations - East

FOR REVIEW ONLY

DATE: | 2/5/23 SCALE: | /4" = | '-0"

JOB: HIRST-MCAFEE

1 West (Rear) - Existing
1/4" = 1'-0"

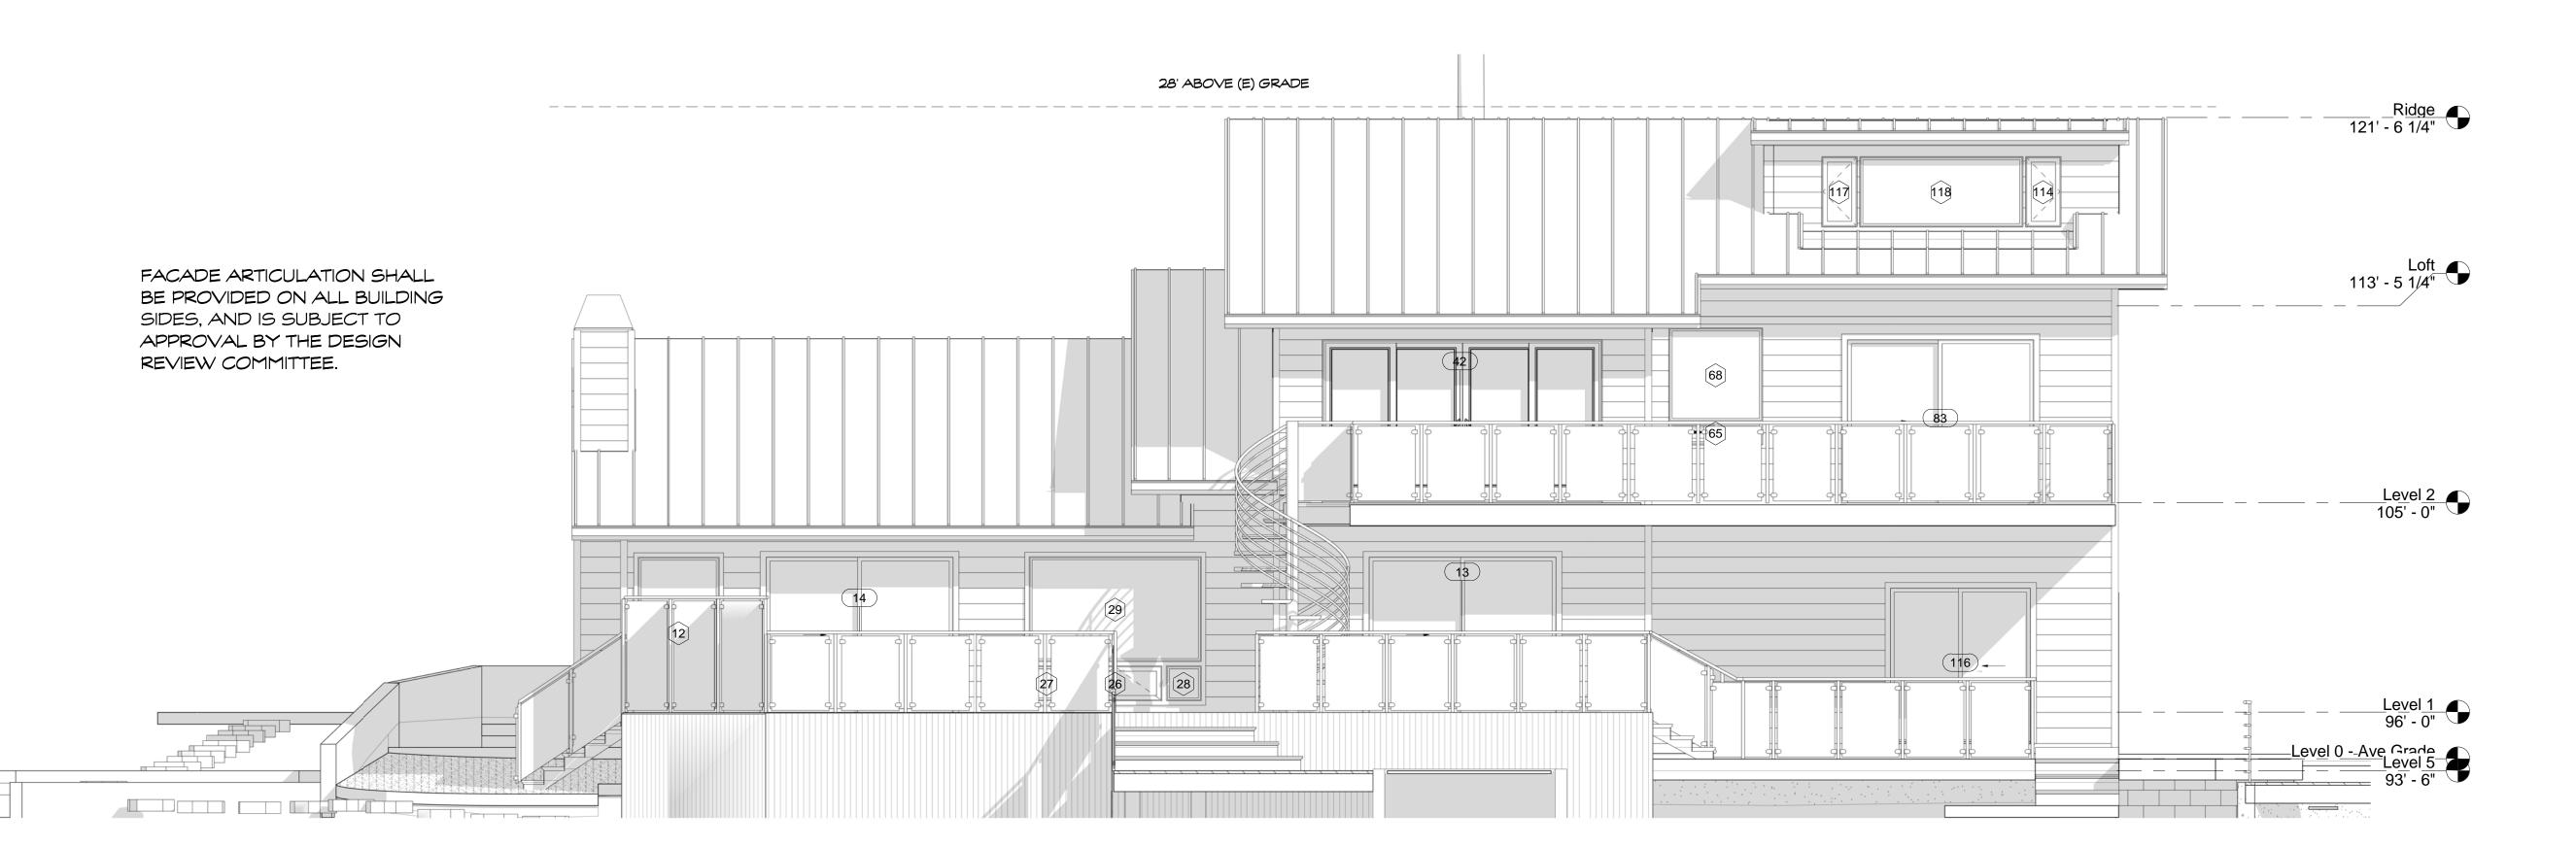

2 West (Rear) - Proposed 1/4" = 1'-0"

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**REVISIONS** 

EDWARD C. LOVE, ARCHITECT

Edward C. Love Architect

Level 0 - Ave Grade Level 5 93' - 6"

> Additions for Tirst-McAfee FOO Sierra St


> > Elevations - West

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DATE: | 2/5/23 SCALE: |/4" = |'-0"

JOB: HIRST-MCAFEE

SHEET:



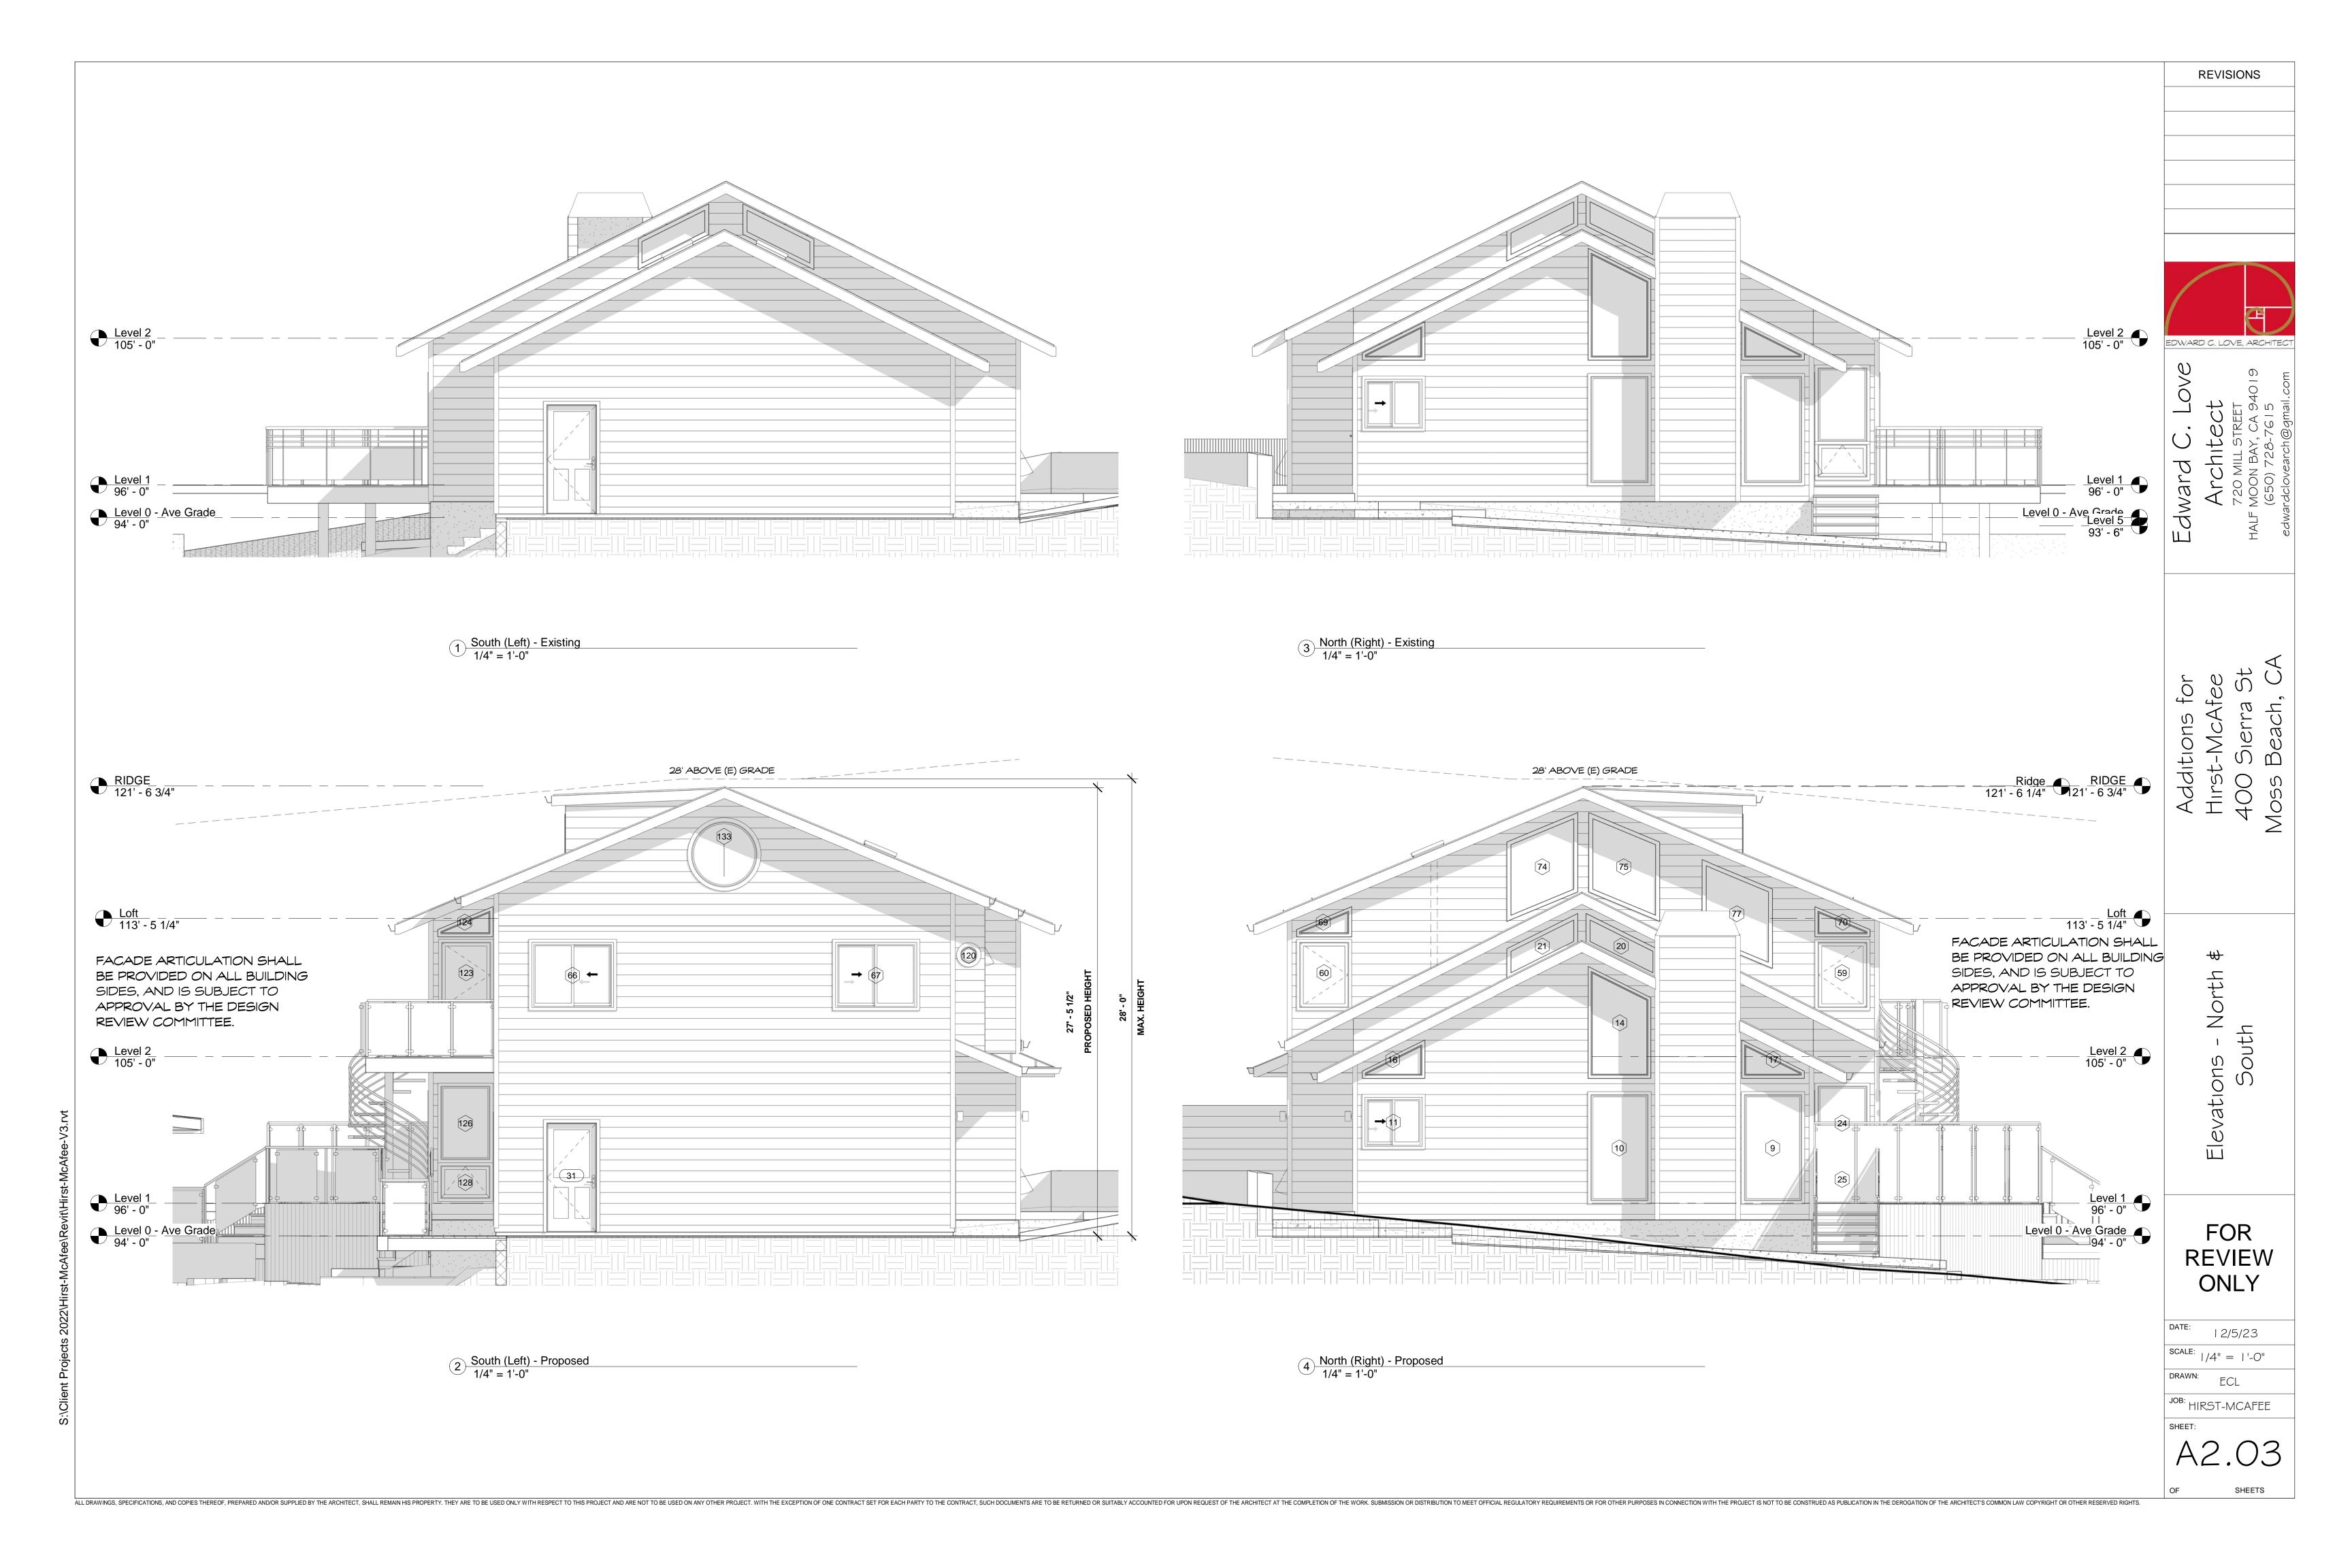

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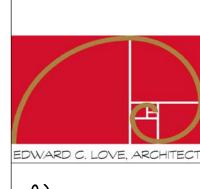
EDWARD C. LOVE, ARCHITECT

Additions for Hirst-McAfee 400 Sierra St Moss Beach, CA

Section

FOR REVIEW ONLY

12/5/23 SCALE: |/4" = |'-0" ECL



Edward C. Love
Architect
720 MILL STREET

Additions for Hirst-McAfee 400 Sierra St Moss Beach, CA

Section

FOR REVIEW ONLY

DATE: | 2/5/23 | SCALE: | /4" = | '-0"

DRAWN: ECL

JOB: HIRST-MCAFEE
SHEET:

SHEETS

Ridge 121'- 6 1/4'

CELING HEIGHT: 7-6 - 7-2'

Level 2 169-2 104'-0'


Level 1 - Top 94'-0'

Level 0 - Ave Grade 94'-0'

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1 New Section 1/4" = 1'-0"

S:\Client Projects 2022\Hirst-McAfee\Revit\Hirst-McAfe

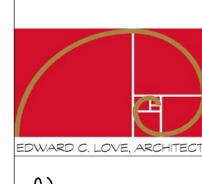

Architect
720 MILL STREET
ALF MOON BAY, CA 94019
(650) 728-7615

Additions for Hirst-McAfee 400 Sierra St

)etails

FOR REVIEW ONLY

DATE: | 2/5/23 | SCALE:

DRAWN: ECL

JOB: HIRST-MCAFEE
SHEET:

OF SHEETS

# ENTRE/MATIC

# Amarr<sup>®</sup> Vista VI1000


Contemporary Aluminum Full View Garage Doors



# industrial look goes residential with the introduction of the Amarr Vista collection. From the outside, these sleek doors perfectly mirror the clean lines and glass expanses of your home's contemporary design. Inside, they transform your garage into a bright and inviting room.



		_

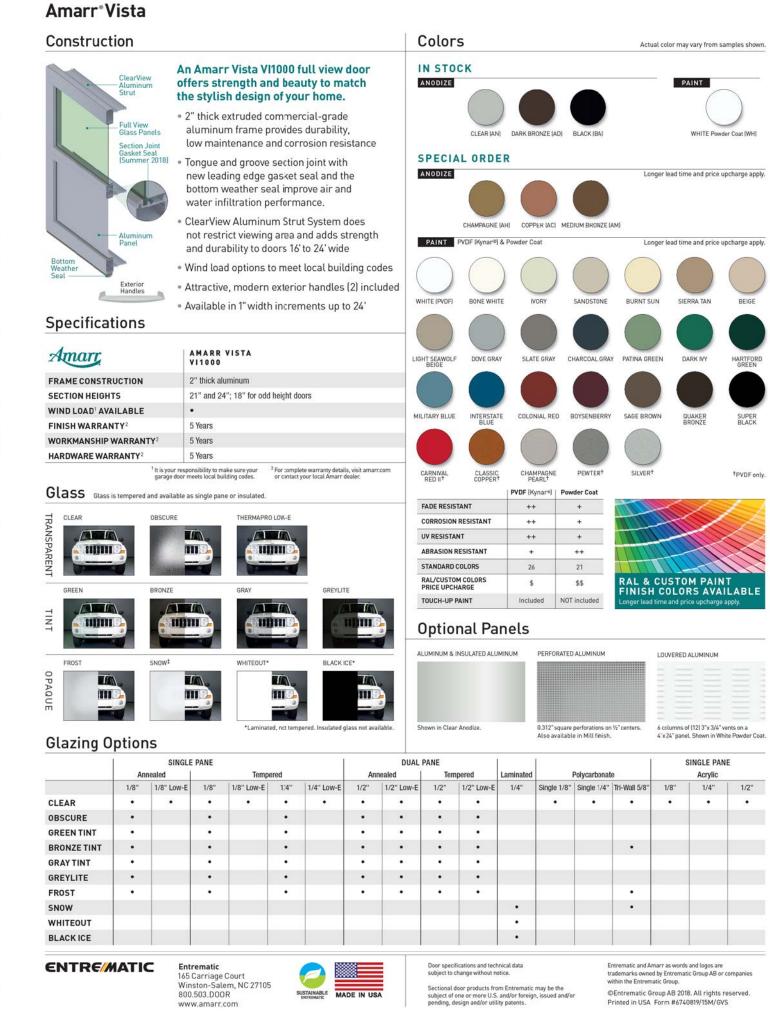

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## Product Overview

The outdoor LED wall lantern is uniquely designed with a contemporary feel. Its durable aluminum construction with hand painted black finish and frosted glass gives a sophisticated look.

This uniquely designed fixture is the choice of discriminating yet value conscious homeowners who want to enrich their home.

Darksky certified
Light color is 3000K (bright white)
360 Lumens
80 CRI and uses only 5.5-Watt


# <u>Specifications</u>

Product Depth (in.) Product Length (in.)	5.91 8.01	Product Hei Product Wid	0		8.01 4.49		
Details Actual Color Temperatur Color Temperature	re (K)	3000 Bright White	0	Color	Rendering Index		80
Exterior Lighting Produc Fixture Material	t TypeCylind	der Lights Aluminum	Fixtur		or/Finish /Lens Type	Black	Frosted
Light Bulb Type Included Maximum Wattage (watts Watt Equivalence	9	rated LED O 60	Light		t (lumens) er of Bulbs Requir	360 ed	0
Outdoor Lighting Featur	res	Dark Sky,Wo	eather	· Resis	tant,Weather Resi	stant	
Power Type Product Weight (lb.)		Hardwired 2.29lb					

Modern

SEE STRUCTURAL PLANS FOR MATERIALS, DIMENSIONS & DETAILS



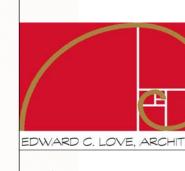

FOR REVIEW ONLY

12/5/23

A5.02



Material Sheet 3/8" = 1'-0"



SWISS COFFEE OC-45 - BJM




OCTOBER MIST 14*9*5 - BJM

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HALE NAVY HC-154 - BJM



REVISIONS							
DATE	BY						

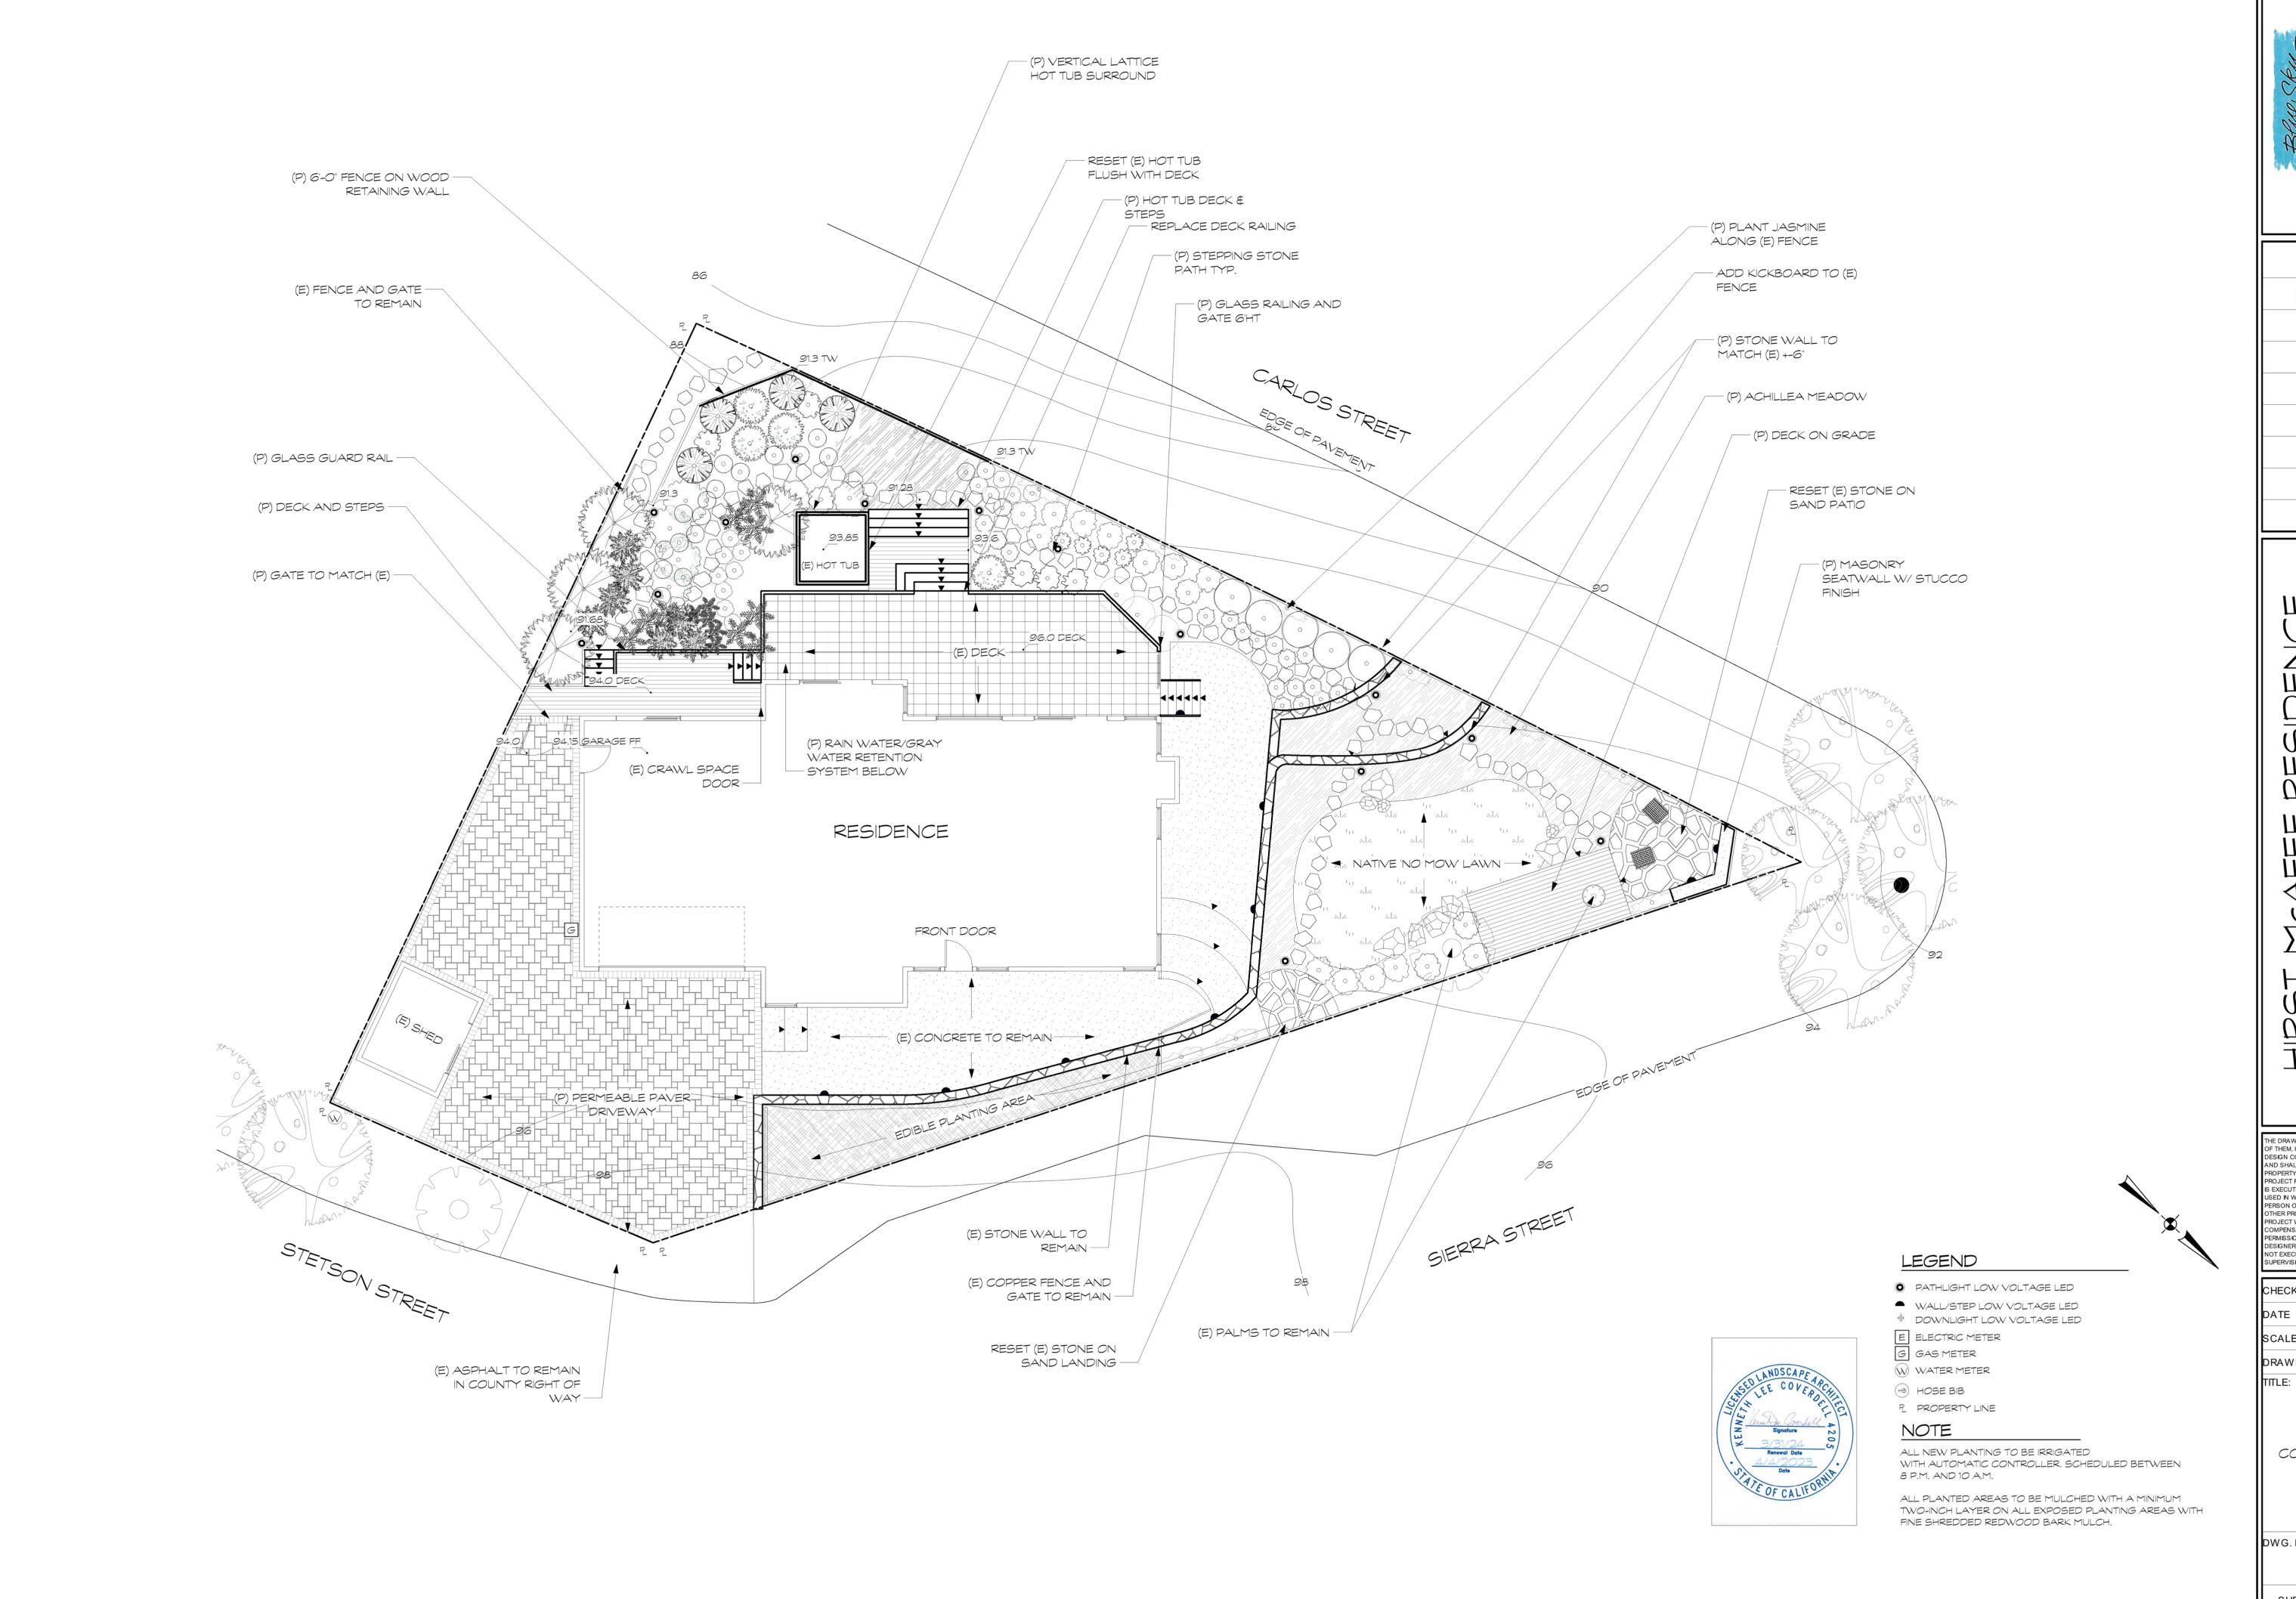
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CHECKED K.C.	
DATE 4/4/202	3
SCALE 1/8" = 1'	
DRAWN K.C.	
TITLE:	
11	

CONCEPT PLAN

DWG. NO.

SHEET 1 OF 7 JOBHIRST-MCAFEE

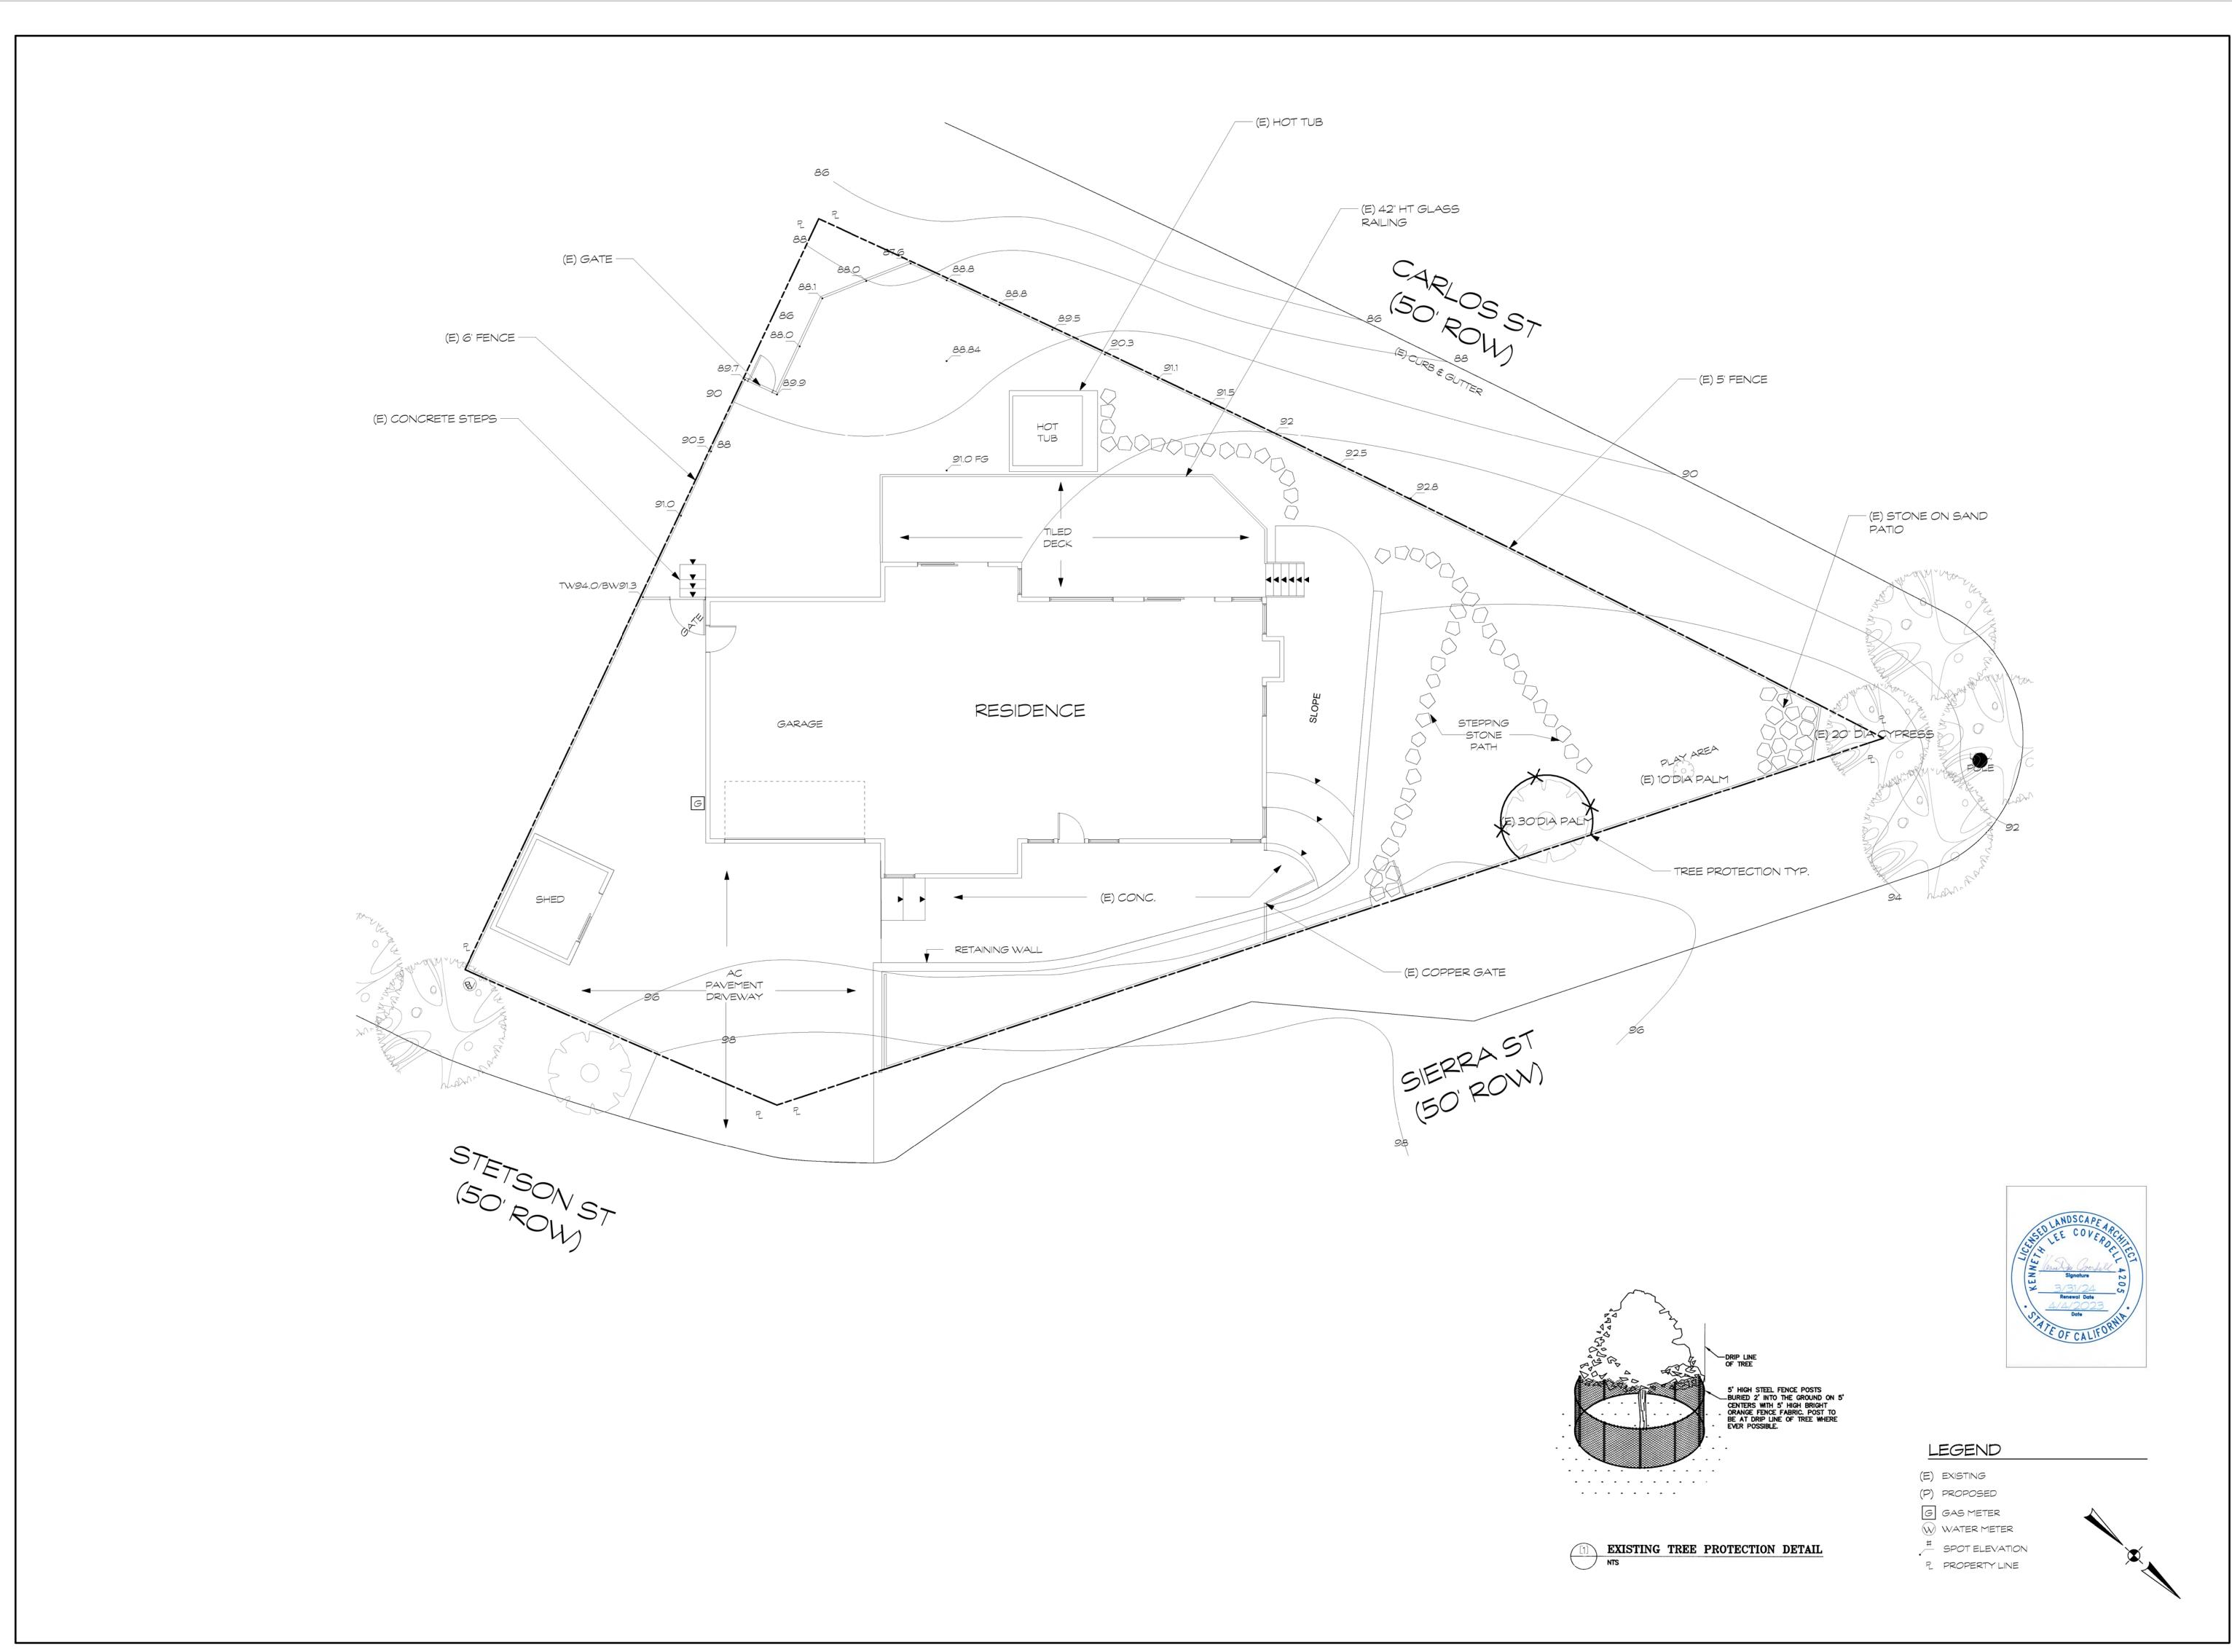

HRST-MOAFEE RESIDENCE

REVISIONS

DATE

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CHECKED K.C.

DATE 4/4/2023

SCALE 1/8" = 1'


DRAWN K.C.

EXISTING CONDITIONS

DWG. NO.

SHEET 2 OF 7

JOBHIRST-McAFEE

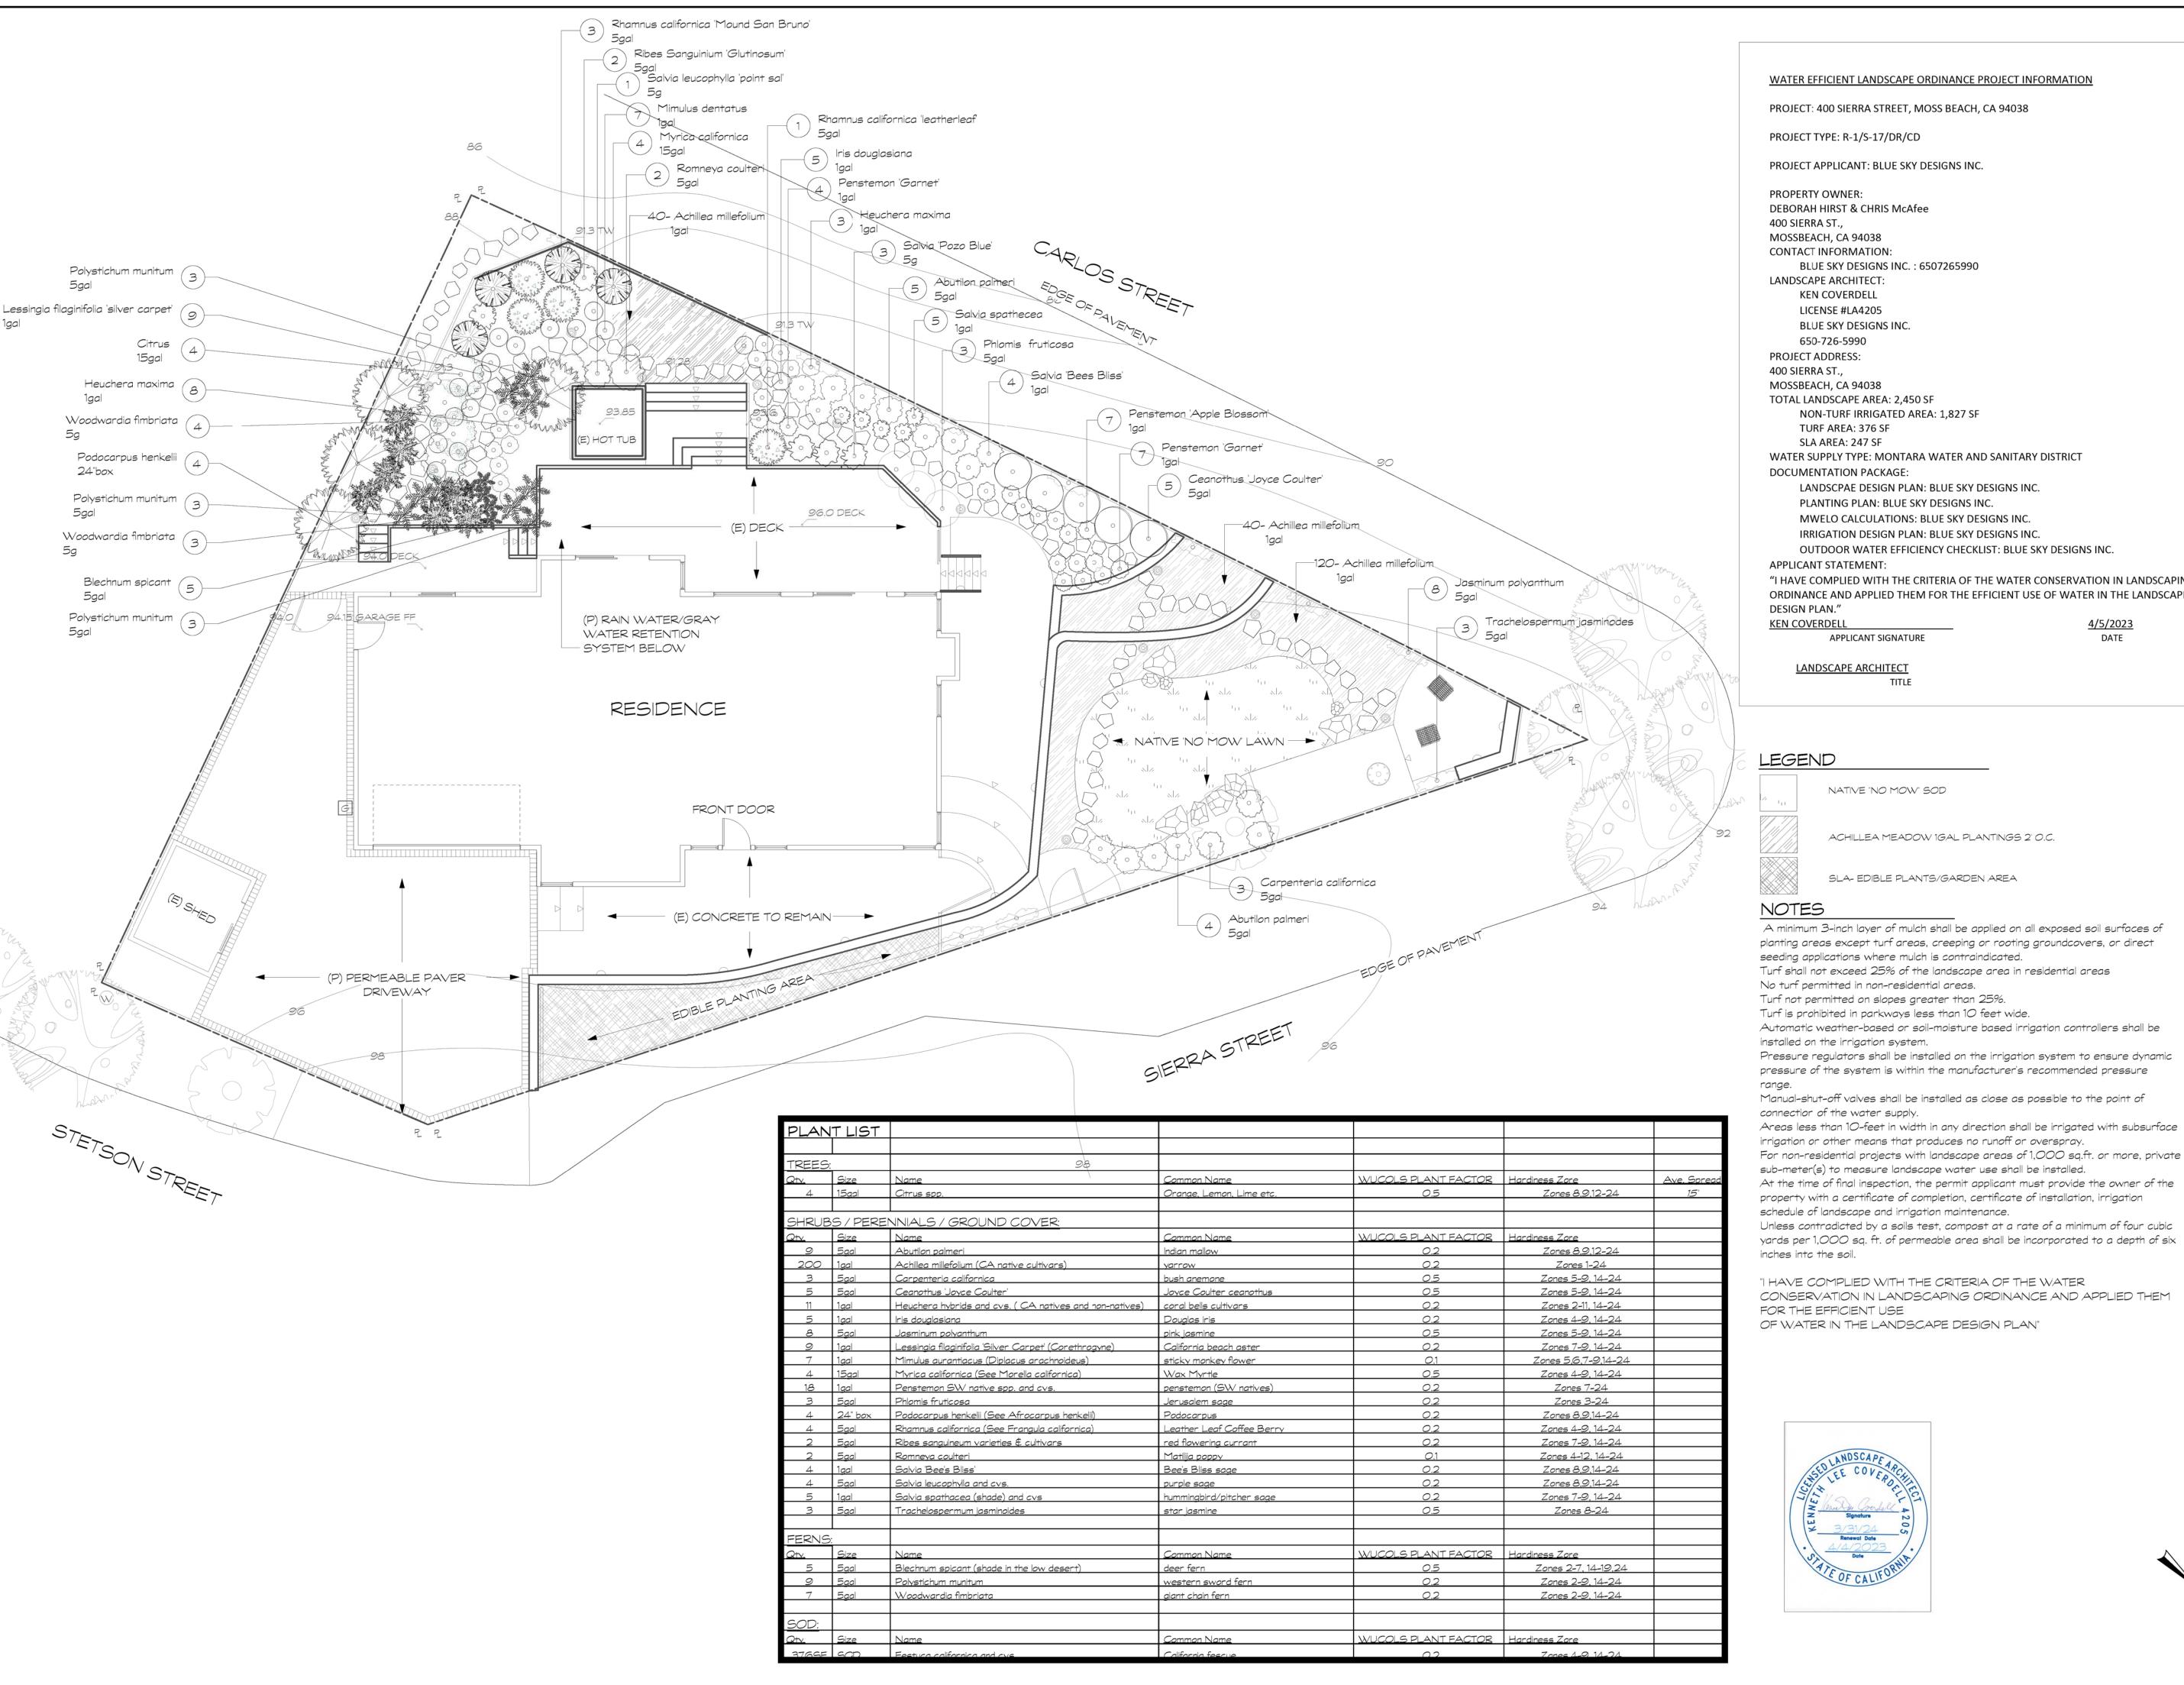

### WATER EFFICIENT LANDSCAPE ORDINANCE PROJECT INFORMATION

PROJECT: 400 SIERRA STREET, MOSS BEACH, CA 94038

WATER SUPPLY TYPE: MONTARA WATER AND SANITARY DISTRICT

MWELO CALCULATIONS: BLUE SKY DESIGNS INC.

OUTDOOR WATER EFFICIENCY CHECKLIST: BLUE SKY DESIGNS INC.

"I HAVE COMPLIED WITH THE CRITERIA OF THE WATER CONSERVATION IN LANDSCAPING ORDINANCE AND APPLIED THEM FOR THE EFFICIENT USE OF WATER IN THE LANDSCAPE

4/5/2023

DATE

ACHILLEA MEADOW 1GAL PLANTINGS 2' O.C.

A minimum 3-inch layer of mulch shall be applied on all exposed soil surfaces of planting areas except turf areas, creeping or rooting groundcovers, or direct

Turf shall not exceed 25% of the landscape area in residential areas

Automatic weather-based or soil-moisture based irrigation controllers shall be

Pressure regulators shall be installed on the irrigation system to ensure dynamic pressure of the system is within the manufacturer's recommended pressure

Manual-shut-off valves shall be installed as close as possible to the point of

Areas less than 10-feet in width in any direction shall be irrigated with subsurface

For non-residential projects with landscape areas of 1,000 sq.ft. or more, private sub-meter(s) to measure landscape water use shall be installed.

property with a certificate of completion, certificate of installation, irrigation schedule of landscape and irrigation maintenance.

Unless contradicted by a soils test, compost at a rate of a minimum of four cubic yards per 1,000 sq. ft. of permeable area shall be incorporated to a depth of six

"I HAVE COMPLIED WITH THE CRITERIA OF THE WATER CONSERVATION IN LANDSCAPING ORDINANCE AND APPLIED THEM

OF WATER IN THE LANDSCAPE DESIGN PLAN"





REVISIONS									
DATE	BY								

HE DRAWINGS ON THIS SHEET (OR COPIES F THEM, HOWEVER EXECUTED) AND THE ESIGN CONCEPTS CONVEYED BY THEM ARE ND SHALL REMAIN THE EXCLUSIVE PROPERTY OF THE DESIGNER WHETHER TH PROJECT FOR WHICH THEY WERE CREATED EXECUTED OR NOT. THEY MAY NOT BE ISED IN WIHOLE OR IN PART BY ANY PERSON OR BUSINESS ENTITY OR ANY THER PROJECT NOR EXTENSIONS OF THIS PROJECT WITHOUT APPROPRIATE OMPENSATION TO, AND WRITTEN ERMISSION FROM THE DESIGNER. THE DESIGNER ASSUMES NO LIABILITY FOR IDEAS NOT EXECUTED BY, OR UNDER THE DIRECT

SUPERVISION OF, BLUE SKY DESIGNS, INC.
CHECKED K.C.
DATE 4/4/2023
SCALE 1/8" = 1'
SCALE 1/6 = 1
DRAWN K.C.
DRAWN R.C.
TITLE:
PLANTING PLAN

SHEET 3 OF 7


OBHIRST-McAFEE

DWG. NO.

									WU	COLS
nt C	ass	sifica	tion				Botanical Name	Common Name	Category	Pint Factor
EES	S:						<u> </u>	•		1
П	П		Т	П	T	П	Citrus spp.	orange, lemon etc.	M	0.5
RU	BS	/ PE	RNI	IIAL:	S / GI	ROUN	ID COVER:			
			S		Т	_	Abutilon palmeri	Indian mallow	L	0.2
$\dashv$	Gd	ь	+	+	+	N	Achillea millefolium (CA native cultivars)	varrow		0.2
$\dashv$	4	+	5	+	+	N	Carpenteria californica	bush anemone	M	0.5
$\dashv$	Gc	$\vdash$	╁	+	+	N	Ceanothus 'Joyce Coulter'	Jovce Coulter ceanothus	M	0.5
$\dashv$	_	Р	+	↤	+	N	Heuchera hybrids and cvs. ( CA natives and non-natives)	coral bells cultivars	L	0.3
-	_		+	₩	+	200	,			- ,-
-	-	Р	+	₩	- 1	N	Iris douglasiana	Douglas iris	L	0.2
$\dashv$	Gc	Н	+	+	V	N	Jasminum polyanthum Lessingia filaginifolia 'Silver Carpet' (Corethrogyne)	pink jasmine California beach aster	L	0.5
-1	GC	+	5	+	+		Mimulus aurantiacus (Diplacus arachnoideus)		VL	0.2
$\dashv$	$\dashv$	+	8		+	N	Myrica californica (See Morella californica)	sticky monkey flower Wax Myrtle	M	0.1
↤	⊣	Р	+	+	+	N	Penstemon SW native spp. and cvs.	penstemon (SW natives)	L	0.3
$\dashv$	⊣	-	15	+	+	11	Phlomis fruticosa	Jerusalem sage		0.2
$\dashv$	╛	$\vdash$	5		+	+	Podocarpus henkelii (See Afrocarpus henkelii)	Podocarpus		0.2
┪	┪	+	18		+	N	Rhamnus californica (See Frangula californica)	Leather Leaf Coffee Berry	1	0.2
┪	┪	$\vdash$	18		+	Ň	Ribes sanguineum varieties & cultivars	red flowering currant		0.2
┪	┪	Р	18		+	Ň	Romneya coulteri	Matilija poppy	VL	0.1
_	Gc	_	S		+	N	Salvia 'Bee's Bliss'	Bee's Bliss sage	L	0.2
┪	Ť	$\vdash$	18		+	N	Salvia leucophylla and cvs.	purple sage	ī	0.2
7	Gd	Р	Ť	Н	$\top$	N	Salvia spathacea (shade) and cvs	hummingbird/pitcher sage	- L	0.2
_	Gc	_	15	1	Τv	_	Trachelospermum jasminoides	star jasmine	M	0.5
RNS		•						,,	that a second	
	_	Р	Т	П	$\top$	N	Blechnum spicant (shade in the low desert)	deer fern	M	0.5
┪		P	╈	+	+	Ň	Polystichum munitum	western sword fern	L	0.2
$\dashv$		P	+	+	+	Ň	Woodwardia fimbriata	giant chain fern	T T	0.2
_	_						Troumarate Illimitate	giant chain form		0.2
									TOTAL PLANT FACTOR	7
										<u> </u>
								R (3) PRESCRIPTIVE COMPLIANCE	TOTAL PLANT SPP	. 24

W/II/COI G D	lon: North Carte	Coact				
WUCOLS Reg	ion: North-Centro	U Coast		_		
A) /EDACE D	I ANT EACTOR	2 FOR 100%	DE THE DLAN	TED AREA		
AVERAGEP	LANT FACTOR	A CONTRACTOR OF THE CONTRACTOR		TED AREA		
		WUCOLS	No. of			
		Class	Plants x	Average		
WUCOLS	No. of	Plant	Plant	Plant		
Class	Plants	Factor	Factor	Factor		
High	0	0.8	0			
Medium	81	0.5	40.5			
Low	671	0.2	134.2			
Very Low	4	0.1	0.4			
Total Plants	756		175.1	0.23		
AVERAGE P	LANT FACTOR	R FOR EACH H	- TYDROZONE			
, , , , , , , , , , , , , , , , , , , ,	_ ,,,,,,,,,,,,,,,,,,,,,,,,,,,,,,,,,,,,,		WUCOLS	No. of	Hydrozone	
			Class	Plants X	Average	
	WUCOLS	No. of	Plant	Plant	Plant	Specified
Lab. (alara ara core a	Class	Plants	Factor	Factor	Factor	on Plan
Hydrozone					гастог	on Plan
Hydrozone 1:	High	0	0.8	0		
Valve 1	Medium	10	0.5			
	Low	204	0.2			
	Very Low	0	0.1	0		
	Total Plants	214		45.8	0.21	
Hydrozone 2:	High	0	0.8	0		
Valve 2	Medium	0	0.5	0		
SOD/	Low	376	0.2	75.2		
LAWN SF		0	0.1	75.2		
LAWN SF	Very Low		0.1		0.00	
	Total Plants	376		75.2	0.20	
Hydrozone 3:	High	0	0.8	0		
Valve 3	Medium	5	0.5	2.5		
	Low	47	0.2			
	Very Low	0				
	Total Plants	52		11.9	0.23	
	TOTAL PIATTS	52		11.9	0.25	
Hydrozone 4:	High	0	0.8	0		
Valve 4	Medium	13				
	Low	44	0.2			
	Very Low	4	0.1			
	<del>'</del>	61			0.26	
	Total Plants	0		15.7	0.26	
Hydrozone 5:	High	0	0.8	0		
Valve 5	Medium	53				
v GIVE -	Low	99				
	1 L CNA/		0.2	0	I	I
(COVERED				^		
	Very Low Total Plants	<i>O</i> 53	0.1	0 26.5	0.50	

	BY HYDROZO	1								D 1-11-11-11	
	-									Precipitation	
	Design						Flow Rate	Flow Rate	Landscape	Rate	
	Operating	Plant	No. of	Emitters	Emitters	GPH Per	(Application Rate)	(Application Rate)	Area (Ft²)	Per Zone	
<u>Zone</u>	Pressure	Size	<u>Plants</u>	<u>Per Plant</u>	Per Zone	<u>Emitter</u>	<u>Gal/Hr</u>	<u>Gal/Min</u>	<u>Per Zone</u>	(ln/Hr) *	
Hydrozone 1	30 PPI	4 ln.	0	1	0	1					
(Valve 1)		1 Gal.	200	2		1	400				
		5 Gal.	14	2		2					
		15 <i>G</i> al.	0	4		2					
		24" Box	0	8	0	2					
						Zone Total	456	7.6	730	)	1.0
Hydrozone 3	30 PPI	4 ln.	0	1	0	1	0				
(Valve 3)		1 Gal.	36	2		1	72				
		5 Gal.	16	2	32	2					
		15 <i>G</i> al.	0	4	0	2	0				
		24" Box	0	8	0	2	0				
						Zone Total	136	2.3	438		0
Hydrozone 4	30 PPI	4 ln.	0	1	0	1	0				
(Valve 4)		1 Gal.	24	2	48	1	48				
-		5 Gal.	30	2	60	2	120				
		15 Gal.	8	4	32	2	64				
		24" Box	4	8	32	2	64				
						Zone Total	296	4.9	603	5	C
<u> AWN</u>										Precipitation	
							Flow Rate	Flow Rate	Landscape	Rate	
				SPRAY	NOZZLES		(Application Rate)	(Application Rate)	Area (Ft²)	Per Zone	
Hydrozone 2	40 PSI			NOZZLE	PER VALVE	NOZZLE	<u>Gal/Hr</u>	<u>Gal/Min</u>	<u>Per Zone</u>	<u>(In/Hr) *</u>	
(Valve 2)	MP800 ROT	AOR NOZZLES		90	0	0.49	0	0			
				180	9			8.37			
				270	0	1.4	0	0			
				360	0	1.87	0	0			
								0			
						Zone Total	502.2	8.37	376		- 2
							1024.0	10.0	01.17	,	
		 GPM)/Landscape				andscape Total	1094.2	18.2	2147		4

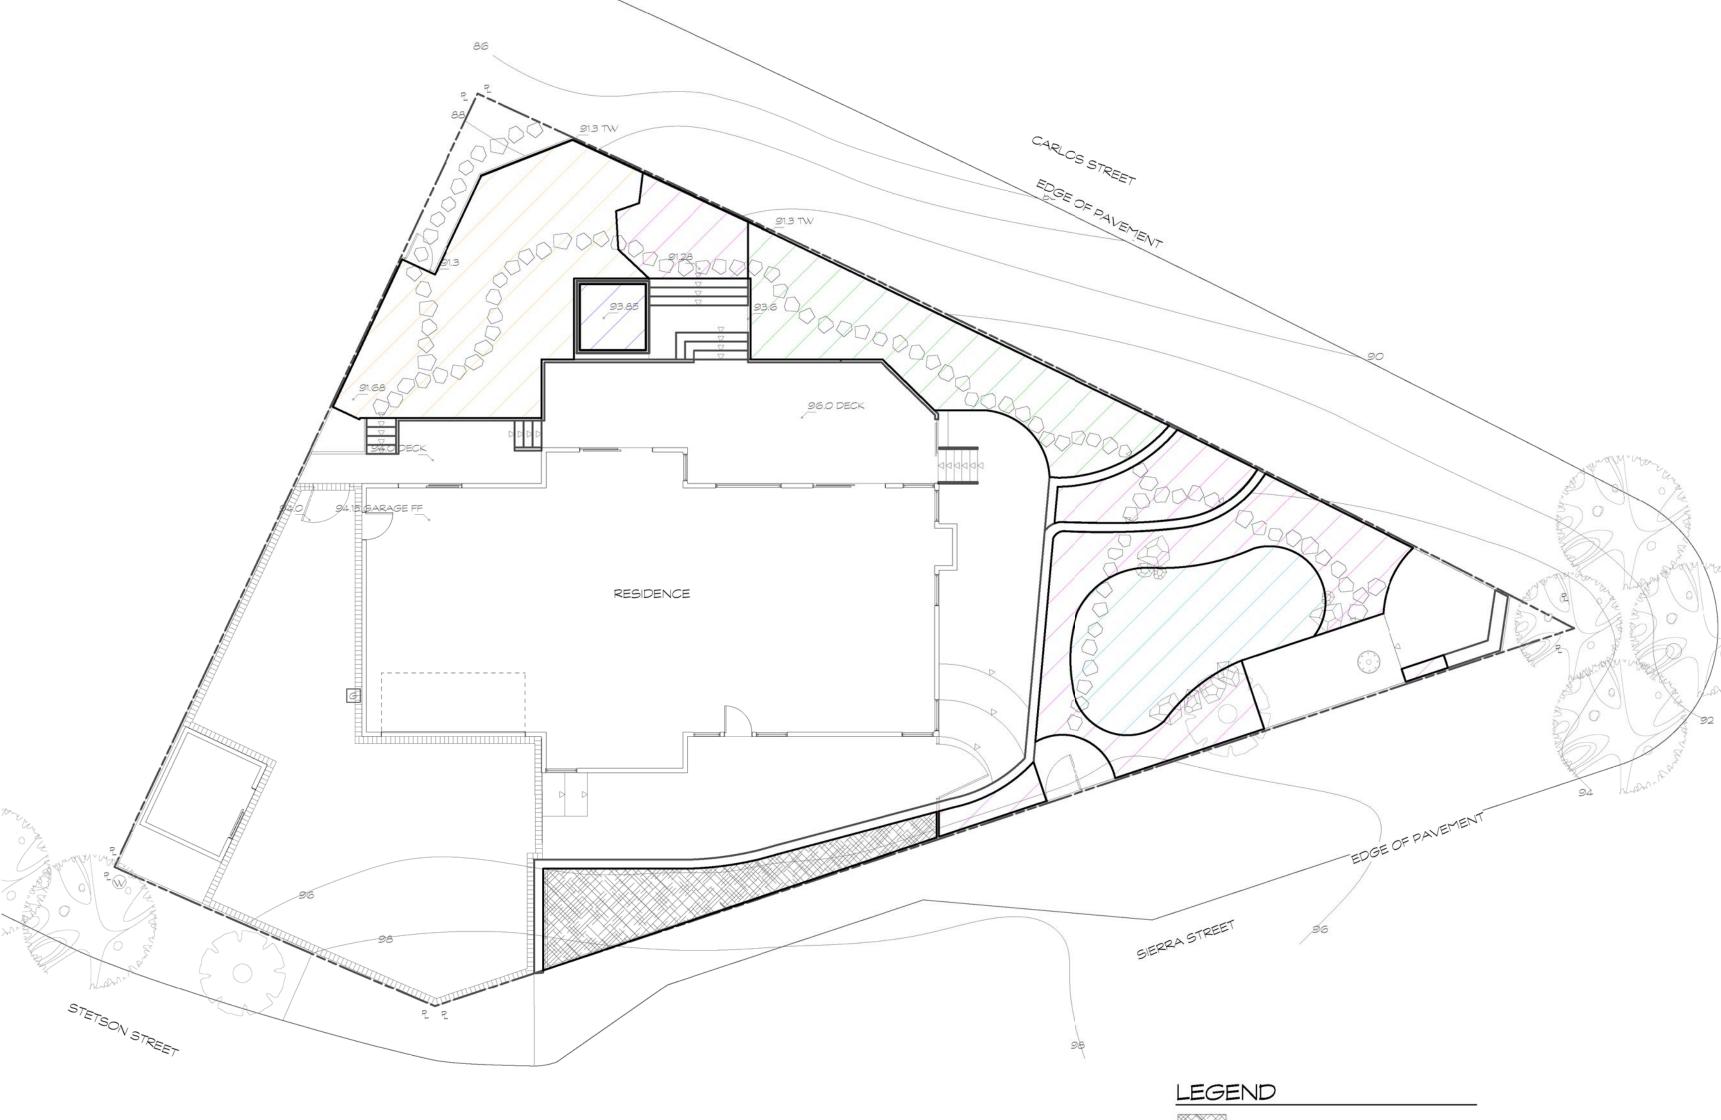

	FICIENT LANDSCAPE		- <u> </u>	200						
	al Evapotranspiration Rate (Eto)	:		32.9						
Source for Eto:										
WATER USE	CALCULATIONS									
		Plant		Irrigation						
	Planting	Factor	Irrigation	Efficiency	ETAF		Landscape			Annual
Hydrozone	<u>Description</u>	(PE)	<u>Method</u>	(E)	(PF/IE)		<u>Area (sq ft)</u>		<u>Area</u>	ETWU
Regular Landsco										
	MIXED PLANTING		DRIP	0.81			730		189.26	3860
	LOW WATER USE		SPRAY	0.75			376		100.27	2045
	MIXED PLANTING		DRIP	0.81			438		124.37	0.
4	MIXED PLANTING	0.26	DRIP	0.81	0.32		603		193.56	0.
5	COVERED SPA	0.5	SPRAY	0.75	0.67		53		35.33	720
					Total	(A)	2200	(B)	642.8	6626
	pe Areas (SLA)									
N/A	EDIBLE GARDEN AREA				N/A		250			
					Total	(C)	250	(D)	0.00	6626
									ETWU TOTAL	6626
						Maxin	num Allowed Wat			2468
THE IRRIGATIO	ON EFFICIENCY IS GREATER	THAN 70%					THE	MAWA 19	GREATER TH	HAN THE ET
	od = Overhead Spray or Drip									
	ncy = 0.75 for Spray Heads and									
ETAF (Evapotro	anspiration Efficiency Adjustment	Factor) = Plan	t Factor/Irrigation	Efficiency						
Annual ETWU (	Estimated Total Water Use, in g	-IIN								
	moninarea rorar vvarer ese, in g	jalions) =	1							
			l n factor that conve	erts acre-inches	per acre to ac	llons per	sauare foot			
	62 x ETAF x Area where 0.62		 n factor that conve 	erts acre-inches	per acre to go	illons per	square foot			
Annual Eto $\times$ 0.	62 x ETAF x Area where 0.62		 n factor that conve	erts acre-inches	s per acre to go	illons per	square foot			
	62 x ETAF x Area where 0.62		I n factor that conve	erts acre-inches	per acre to go	illons per	square foot			
Annual Eto x O.	62 x ETAF x Area where 0.62      LATIONS 		n factor that conve	erts acre-inches	s per acre to ga	illons per	square foot			
Annual Eto x O.  ETAF CALCL  Regular Landsco	62 x ETAF x Area where 0.62      LATIONS      ape Areas		n factor that conve			illons per	square foot			
Annual Eto x O.  ETAF CALCL  Regular Landsco  Total ETAF x A	62 x ETAF x Area where 0.62      LATIONS      ape Areas		n factor that conve	В	642.8	illons per	square foot			
Annual Eto x O.  ETAF CALCL  Regular Landsco	62 x ETAF x Area where 0.62      LATIONS      ape Areas		n factor that conve	B A	642.8 2200					
Annual Eto x O.  ETAF CALCL  Regular Landsco  Total ETAF x A	62 x ETAF x Area where 0.62      LATIONS      ape Areas			B A B/A	642.8 2200 0.29	Average	ETAF			
Annual Eto x O.  ETAF CALCL  Regular Landsco  Total ETAF x A	62 x ETAF x Area where 0.62      LATIONS      ape Areas		Ave	B A B/A erage ETAF mus	642.8 2200 0.29 st be 0.55 or be	Average	e ETAF residential areas			
Annual Eto x O.  ETAF CALCL  Regular Landsco  Total ETAF x A	62 x ETAF x Area where 0.62      LATIONS      ape Areas		Ave	B A B/A erage ETAF must be	642.8 2200 0.29 st be 0.55 or below	Average	ETAF residential areas residential areas			
Annual Eto x O.  ETAF CALCL  Regular Landsco  Total ETAF x A	62 x ETAF x Area where 0.62      LATIONS      ape Areas		Ave	B A B/A erage ETAF must be	642.8 2200 0.29 st be 0.55 or below	Average	e ETAF residential areas			
Annual Eto x O.  ETAF CALCL  Regular Landsco  Total ETAF x A  Total Area	62 x ETAF x Area where 0.62		Ave	B A B/A erage ETAF must be	642.8 2200 0.29 st be 0.55 or below	Average	ETAF residential areas residential areas			
Annual Eto x O.  ETAF CALCL  Regular Landsco  Total ETAF x A  Total Area  All Landscape A	62 x ETAF x Area where 0.62		Ave	B A B/A erage ETAF must be THE ETAF IS	642.8 2200 0.29 5t be 0.55 or be 0.45 or below 3 BELOW THE	Average elow for r for non-r 0.45/C	ETAF residential areas residential areas			
Annual Eto x O.  ETAF CALCL  Regular Landsco  Total ETAF x A  Total Area  All Landscape A  Total ETAF x A	62 x ETAF x Area where 0.62		Ave	B A B/A erage ETAF must be THE ETAF IS	642.8 2200 0.29 st be 0.55 or be 0.45 or below 6 BELOW THE	Average elow for r for non-r 0.45/C	ETAF residential areas residential areas			
Annual Eto x O.  ETAF CALCL  Regular Landsco  Total ETAF x A  Total Area  All Landscape A	62 x ETAF x Area where 0.62		Ave	B A B/A erage ETAF must be THE ETAF IS  (B+D) (A+C)	642.8 2200 0.29 st be 0.55 or be 0.45 or below 6 BELOW THE 642.79 2450	Average elow for r for non-r 0.45/C	ETAF residential areas residential areas 0.55 MAXIMUM			
Annual Eto x O.  ETAF CALCL  Regular Landsco  Total ETAF x A  Total Area  All Landscape A  Total ETAF x A	62 x ETAF x Area where 0.62		Average	B A B/A erage ETAF must be THE ETAF IS  (B+D) (A+C) (B+D)/(A+C)	642.8 2200 0.29 at be 0.55 or be 0.45 or below 3 BELOW THE 642.79 2450 0.26	Average elow for non-1: 0.45/C	ETAF residential areas residential areas 2.55 MAXIMUM			
Annual Eto x O.  ETAF CALCL  Regular Landsco  Total ETAF x A  Total Area  All Landscape A  Total ETAF x A	62 x ETAF x Area where 0.62		Average Average	B A B/A erage ETAF must EETAF IS  (B+D) (A+C) (B+D)/(A+C) erage ETAF must	642.8 2200 0.29 st be 0.55 or be 0.45 or below 6 BELOW THE 642.79 2450 0.26 st be 0.55 or be	Average elow for 10.45/C	ETAF residential areas residential areas 2.55 MAXIMUM			
Annual Eto x O.  ETAF CALCL  Regular Landsco  Total ETAF x A  Total Area  All Landscape A  Total ETAF x A	62 x ETAF x Area where 0.62		Average Average	B A B/A erage ETAF must e ETAF must be THE ETAF IS  (B+D) (A+C) (B+D)/(A+C) erage ETAF must be ETAF must be	642.8 2200 0.29 st be 0.55 or be 0.45 or below 3 BELOW THE 642.79 2450 0.26 st be 0.55 or be	Average elow for 1	ETAF residential areas 2.55 MAXIMUM EETAF residential areas			
Annual Eto x O.  ETAF CALCL  Regular Landsco  Total ETAF x A  Total Area  All Landscape A  Total ETAF x A	62 x ETAF x Area where 0.62		Average Average	B A B/A erage ETAF must e ETAF must be THE ETAF IS  (B+D) (A+C) (B+D)/(A+C) erage ETAF must be ETAF must be	642.8 2200 0.29 st be 0.55 or be 0.45 or below 3 BELOW THE 642.79 2450 0.26 st be 0.55 or be	Average elow for 1	ETAF residential areas residential areas 2.55 MAXIMUM			
Annual Eto x O.  ETAF CALCL  Regular Landsco  Total ETAF x A  Total Area  All Landscape A  Total ETAF x A  Total ETAF x A	62 x ETAF x Area where 0.62    LATIONS		Average Average	B A B/A erage ETAF must e ETAF must be THE ETAF IS  (B+D) (A+C) (B+D)/(A+C) erage ETAF must be ETAF must be	642.8 2200 0.29 st be 0.55 or be 0.45 or below 3 BELOW THE 642.79 2450 0.26 st be 0.55 or be	Average elow for 1	ETAF residential areas 2.55 MAXIMUM EETAF residential areas			
Annual Eto x O.  ETAF CALCL  Regular Landsco  Total ETAF x A  Total Area  All Landscape A  Total ETAF x A	62 x ETAF x Area where 0.62    LATIONS		Average Average	B A B/A erage ETAF must e ETAF must be THE ETAF IS  (B+D) (A+C) (B+D)/(A+C) erage ETAF must be ETAF must be	642.8 2200 0.29 st be 0.55 or be 0.45 or below 3 BELOW THE 642.79 2450 0.26 st be 0.55 or be	Average elow for 1	ETAF residential areas 2.55 MAXIMUM EETAF residential areas			
Annual Eto x O.  ETAF CALCL  Regular Landsco  Total ETAF x A  Total Area  All Landscape A  Total ETAF x A  Total ETAF x A	62 x ETAF x Area where 0.62    LATIONS		Average Average	B A B/A erage ETAF must e ETAF must be THE ETAF IS  (B+D) (A+C) (B+D)/(A+C) erage ETAF must be ETAF must be	642.8 2200 0.29 st be 0.55 or be 0.45 or below 3 BELOW THE 642.79 2450 0.26 st be 0.55 or be	Average elow for 1	ETAF residential areas 2.55 MAXIMUM EETAF residential areas			
Annual Eto x O.  ETAF CALCL  Regular Landsco  Total ETAF x A  Total Area  All Landscape A  Total ETAF x A  Total ETAF x A  Total ETAF x A	62 x ETAF x Area where 0.62    LATIONS	2 is a conversio	Average  Average	B A B/A erage ETAF must be THE ETAF IS  (B+D) (A+C) (B+D)/(A+C) erage ETAF must be THE ETAF IS	642.8 2200 0.29 st be 0.55 or be 0.45 or below 6 BELOW THE 642.79 2450 0.26 st be 0.55 or be 0.45 or below 6 BELOW THE	Average elow for 1	ETAF residential areas 2.55 MAXIMUM EETAF residential areas			
Annual Eto x O.  ETAF CALCL  Regular Landsco  Total ETAF x A  Total Area  All Landscape A  Total ETAF x A  Total ETAF x A  Total Area	CULATIONS  ULATIONS  CULATIONS  CULATIONS  CULATIONS  CULATIONS  CULATIONS  CULATIONS	2 is a conversio	Average Average Average	B A B/A Prage ETAF must be THE ETAF IS  (B+D) (A+C) (B+D)/(A+C) Prage ETAF must be THE ETAF IS	642.8 2200 0.29 st be 0.55 or be 0.45 or below 6 BELOW THE 642.79 2450 0.26 st be 0.55 or be 0.45 or below 6 BELOW THE	Average elow for 1	ETAF residential areas 2.55 MAXIMUM EETAF residential areas			
Annual Eto x O.  ETAF CALCL  Regular Landsco  Total ETAF x A  Total Area  All Landscape A  Total ETAF x A  Total Area  MAWA CALC  MAWA (Maxim  O.62 is the con	CULATIONS  LUMATIONS  CULATIONS  LUMATIONS	2 is a conversio	Average Average Average	B A B/A Prage ETAF must be THE ETAF IS  (B+D) (A+C) (B+D)/(A+C) Prage ETAF must be THE ETAF IS	642.8 2200 0.29 st be 0.55 or be 0.45 or below 6 BELOW THE 642.79 2450 0.26 st be 0.55 or be 0.45 or below 6 BELOW THE	Average elow for 1	ETAF residential areas 2.55 MAXIMUM EETAF residential areas			
Annual Eto x O.  ETAF CALCL  Regular Landsco Total ETAF x A Total Area  All Landscape A Total ETAF x A Total Area  MAWA CALC  MAWA (Maxim O.62 is the con LA is the total I	CULATIONS  Lations  L	gallons) = (Annu	Average Average Average	B A B/A Prage ETAF must be THE ETAF IS  (B+D) (A+C) (B+D)/(A+C) Prage ETAF must be THE ETAF IS	642.8 2200 0.29 st be 0.55 or be 0.45 or below 6 BELOW THE 642.79 2450 0.26 st be 0.55 or be 0.45 or below 6 BELOW THE	Average elow for 1	ETAF residential areas 2.55 MAXIMUM EETAF residential areas			
Annual Eto x O.  ETAF CALCL  Regular Landsco  Total ETAF x A  Total Area  All Landscape A  Total ETAF x A  Total Area  MAWA (Maxim  O.62 is the con  LA is the total I  SLA is the total	CULATIONS  Lagren Areas  Areas	gallons) = (Annu e-inches per ac	Average  Average  Average  Average  al Eto × 0.62 × E  are to gallons per s	B A B/A Prage ETAF must be THE ETAF IS  (B+D) (A+C) (B+D)/(A+C) Prage ETAF must be THE ETAF IS	642.8 2200 0.29 st be 0.55 or be 0.45 or below 6 BELOW THE 642.79 2450 0.26 st be 0.55 or be 0.45 or below 6 BELOW THE	Average elow for 1	ETAF residential areas 2.55 MAXIMUM EETAF residential areas			
Annual Eto x O.  ETAF CALCL  Regular Landsco  Total ETAF x A  Total Area  All Landscape A  Total ETAF x A  Total Area  MAWA (Maxim  O.62 is the con  LA is the total I  SLA is the total	CULATIONS  Lations  L	gallons) = (Annu e-inches per ac	Average  Average  Average  Average  al Eto × 0.62 × E  are to gallons per s	B A B/A Prage ETAF must be THE ETAF IS  (B+D) (A+C) (B+D)/(A+C) Prage ETAF must be THE ETAF IS	642.8 2200 0.29 st be 0.55 or be 0.45 or below 6 BELOW THE 642.79 2450 0.26 st be 0.55 or be 0.45 or below 6 BELOW THE	Average elow for 1	ETAF residential areas 2.55 MAXIMUM EETAF residential areas			
Annual Eto x O.  ETAF CALCL  Regular Landsca  Total ETAF x A  Total Area  All Landscape A  Total ETAF x A  Total Area  MAWA CALC  MAWA (Maxim  O.62 is the con  LA is the total II  SLA is the total  ETAF is O.55 f	CULATIONS  UNATIONS  DIPERING  DIPER	gallons) = (Annu e-inches per ac	Average  Average  Average  al Eto × 0.62 × E  are to gallons per s  al areas	B A B/A Prage ETAF must EETAF must be THE ETAF IS  (B+D) (A+C) (B+D)/(A+C) Prage ETAF must be THE ETAF IS  TAF × LA) + ((1-1) Equare foot	642.8 2200 0.29 st be 0.55 or be 0.45 or below 6 BELOW THE 642.79 2450 0.26 st be 0.55 or be 0.45 or below 6 BELOW THE	Average elow for 1	ETAF residential areas 2.55 MAXIMUM EETAF residential areas			
Annual Eto x O.  ETAF CALCL  Regular Landscape A  Total Area  All Landscape A  Total ETAF x A  Total Area  MAWA CALC  MAWA (Maxim  O.62 is the con  LA is the total II  SLA is the total  ETAF is O.55 f  Eto x O.62 x E	CULATIONS  UNATIONS  Dipe Areas  Area	gallons) = (Annu e-inches per ac	Average  Average  Average  Average  al Eto × 0.62 × E  are to gallons per s	B A B/A Prage ETAF must EETAF must be THE ETAF IS  (B+D) (A+C) (B+D)/(A+C) Prage ETAF must be THE ETAF IS  TAF × LA) + ((1-1) Equare foot	642.8 2200 0.29 st be 0.55 or be 0.45 or below 6 BELOW THE 642.79 2450 0.26 st be 0.55 or be 0.45 or below 6 BELOW THE	Average elow for 1	ETAF residential areas 2.55 MAXIMUM EETAF residential areas			
ETAF CALCLE Egular Landsco Total ETAF x A Total Area  TAWA (Maximum).62 is the total BLA is the total BL	CULATIONS  UNATIONS  Dipe Areas  Area	gallons) = (Annu e-inches per ac	Average  Average  Average  al Eto × 0.62 × E  are to gallons per s  al areas	B A B/A Prage ETAF must be THE ETAF IS  (B+D) (A+C) (B+D)/(A+C) Prage ETAF must be THE ETAF IS  THE ETAF IS	642.8 2200 0.29 st be 0.55 or be 0.45 or below 6 BELOW THE 642.79 2450 0.26 st be 0.55 or be 0.45 or below 6 BELOW THE	Average elow for 1	ETAF residential areas 2.55 MAXIMUM EETAF residential areas			

# HYDROZONE LEGEND

SLA- EDIBLE PLANTS/GARDEN AREA 250SF

HYDROZONE 1: MIXED WATER USE (730SF) PLANT FACTOR: .21 HYDROZONE 2: LOW WATER USE (376SF) PLANT FACTOR: .20

HYDROZONE 3: MIXED WATER USE (438SF) PLANT FACTOR: .23

HYDROZONE 4: MIXED WATER USE (603SF) PLANT FACTOR: .26

HYDROZONE 5 : MEDIUM WATER USE (COVERED SPA 53SF) PLANT FACTOR: .5 NOTES

A minimum 3-inch layer of mulch shall be applied on all exposed soil surfaces of planting areas except turf areas, creeping or rooting groundcovers, or direct seeding applications where mulch is contraindicated.

Turf shall not exceed 25% of the landscape area in residential areas

No turf permitted in non-residential areas.

Turf not permitted on slopes greater than 25%.

Turf is prohibited in parkways less than 10 feet wide. Automatic weather-based or soil-moisture based irrigation controllers shall be installed on the irrigation system.

Pressure regulators shall be installed on the irrigation system to ensure dynamic pressure of the system is within the manufacturer's recommended pressure

Manual-shut-off valves shall be installed as close as possible to the point of connection of the water supply.

Areas less than 10-feet in width in any direction shall be irrigated with subsurface irrigation or other means that produces no runoff or overspray. For non-residential projects with landscape areas of 1,000 sq.ft. or more, private


sub-meter(s) to measure landscape water use shall be installed. At the time of final inspection, the permit applicant must provide the owner of the property with a certificate of completion, certificate of installation, irrigation schedule of landscape and irrigation maintenance.

"I HAVE COMPLIED WITH THE CRITERIA OF THE WATER CONSERVATION IN LANDSCAPING ORDINANCE AND APPLIED THEM FOR THE EFFICIENT USE

Unless contradicted by a soils test, compost at a rate of a minimum of four cubic yards per 1,000 sq. ft. of permeable area shall be incorporated to a depth of six

OF WATER IN THE LANDSCAPE DESIGN PLAN"

inches into the soil.

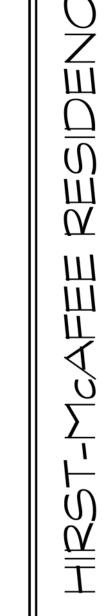

REVISIONS

THE DRAWINGS ON THIS SHEET (OR COPIES OF THEM, HOWEVER EXECUTED) AND THE DESIGN CONCEPTS CONVEYED BY THEM ARE AND SHALL REMAIN THE EXCLUSIVE PROPERTY OF THE DESIGNER WHETHER THE PROJECT FOR WHICH THEY WERE CREATED IS EXECUTED OR NOT. THEY MAY NOT BE USED IN WIHOLE OR IN PART BY ANY PERSON OR BUSINESS ENTITY OR ANY OTHER PROJECT NOR EXTENSIONS OF THIS PROJECT WITHOUT APPROPRIATE COMPENSATION TO, AND WRITTEN PERMISSION FROM THE DESIGNER. THE
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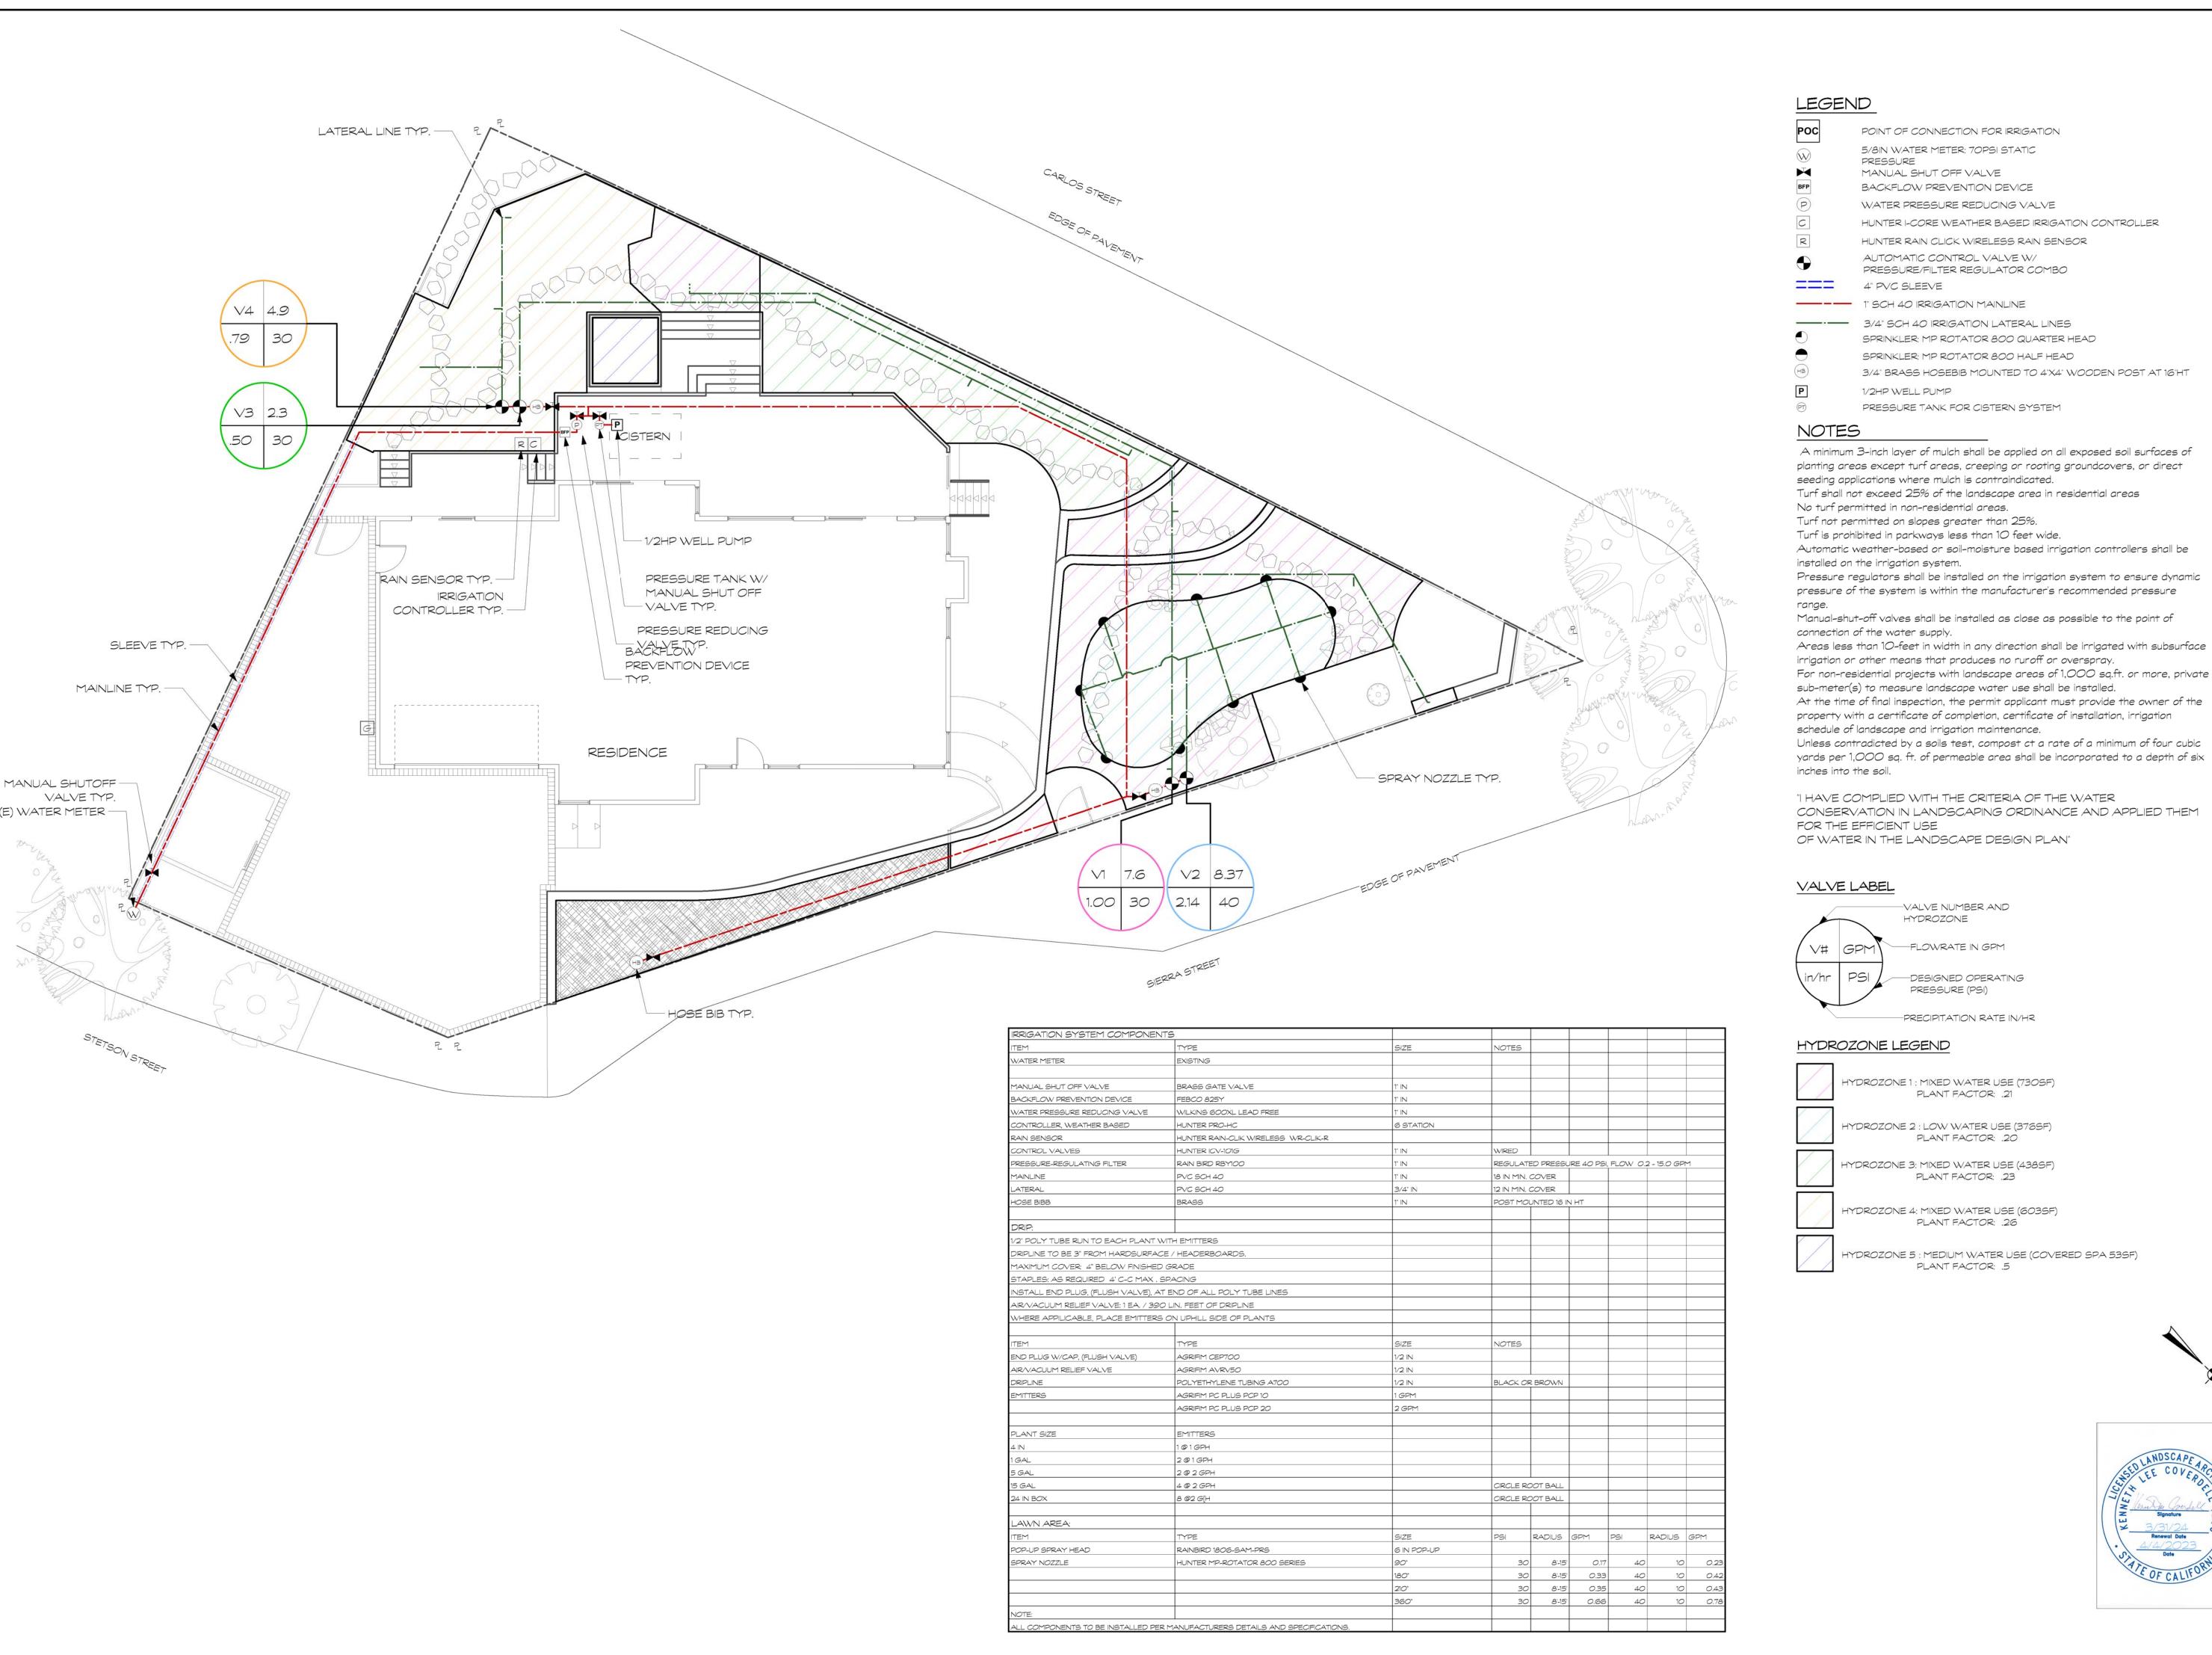
MWELO

CALCULATIONS

DWG. NO.

SHEET 4 OF 7 JOBHIRST-McAFEE





# LEGEND

POINT OF CONNECTION FOR IRRIGATION 5/8IN WATER METER: 70PSI STATIC MANUAL SHUT OFF VALVE BACKFLOW PREVENTION DEVICE WATER PRESSURE REDUCING VALVE

HUNTER I-CORE WEATHER BASED IRRIGATION CONTROLLER

HUNTER RAIN CLICK WIRELESS RAIN SENSOR AUTOMATIC CONTROL VALVE W/

PRESSURE/FILTER REGULATOR COMBO 4" PVC SLEEVE

---- 1" SCH 40 IRRIGATION MAINLINE

- 3/4" SCH 40 IRRIGATION LATERAL LINES SPRINKLER: MP ROTATOR 800 QUARTER HEAD SPRINKLER: MP ROTATOR 800 HALF HEAD

3/4" BRASS HOSEBIB MOUNTED TO 4"X4" WOODEN POST AT 16"HT

1/2HP WELL PUMP

PRESSURE TANK FOR CISTERN SYSTEM

# NOTES

A minimum 3-inch layer of mulch shall be applied on all exposed soil surfaces of planting areas except turf areas, creeping or rooting groundcovers, or direct seeding applications where mulch is contraindicated.

Turf shall not exceed 25% of the landscape area in residential areas

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Areas less than 10-feet in width in any direction shall be irrigated with subsurface irrigation or other means that produces no ruroff or overspray.

For non-residential projects with landscape areas of 1,000 sq.ft. or more, private sub-meter(s) to measure landscape water use shall be installed.


property with a certificate of completion, certificate of installation, irrigation schedule of landscape and irrigation maintenance. Unless contradicted by a soils test, compost ct a rate of a minimum of four cubic

yards per 1,000 sq. ft. of permeable area shall be incorporated to a depth of six inches into the soil.


"I HAVE COMPLIED WITH THE CRITERIA OF THE WATER CONSERVATION IN LANDSCAPING ORDINANCE AND APPLIED THEM FOR THE EFFICIENT USE

OF WATER IN THE LANDSCAPE DESIGN PLAN"

# VALVE LABEL

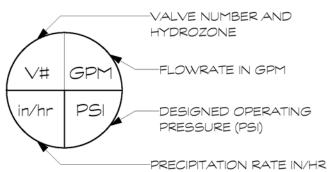


# HYDROZONE LEGEND

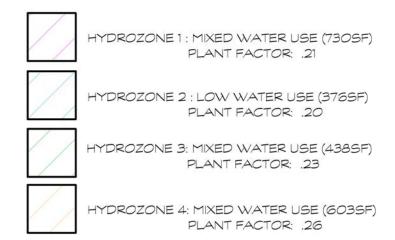

HYDROZONE 5 : MEDIUM WATER USE (COVERED SPA 53SF)

PLANT FACTOR: .5

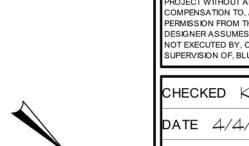



SUPERVISION OF, BLUE SKY DESIGNS, INC. CHECKED K.C.DATE 4/4/2023 SCALE 1/8" = 1 PRAWN K.C.


IRRIGATION PLAN

DWG. NO.

SHEET 5 OF 7 OBHIRST-McAFEE

REVISIONS DATE

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CUSTOM LANDSCAPE ENVIRONMENTS

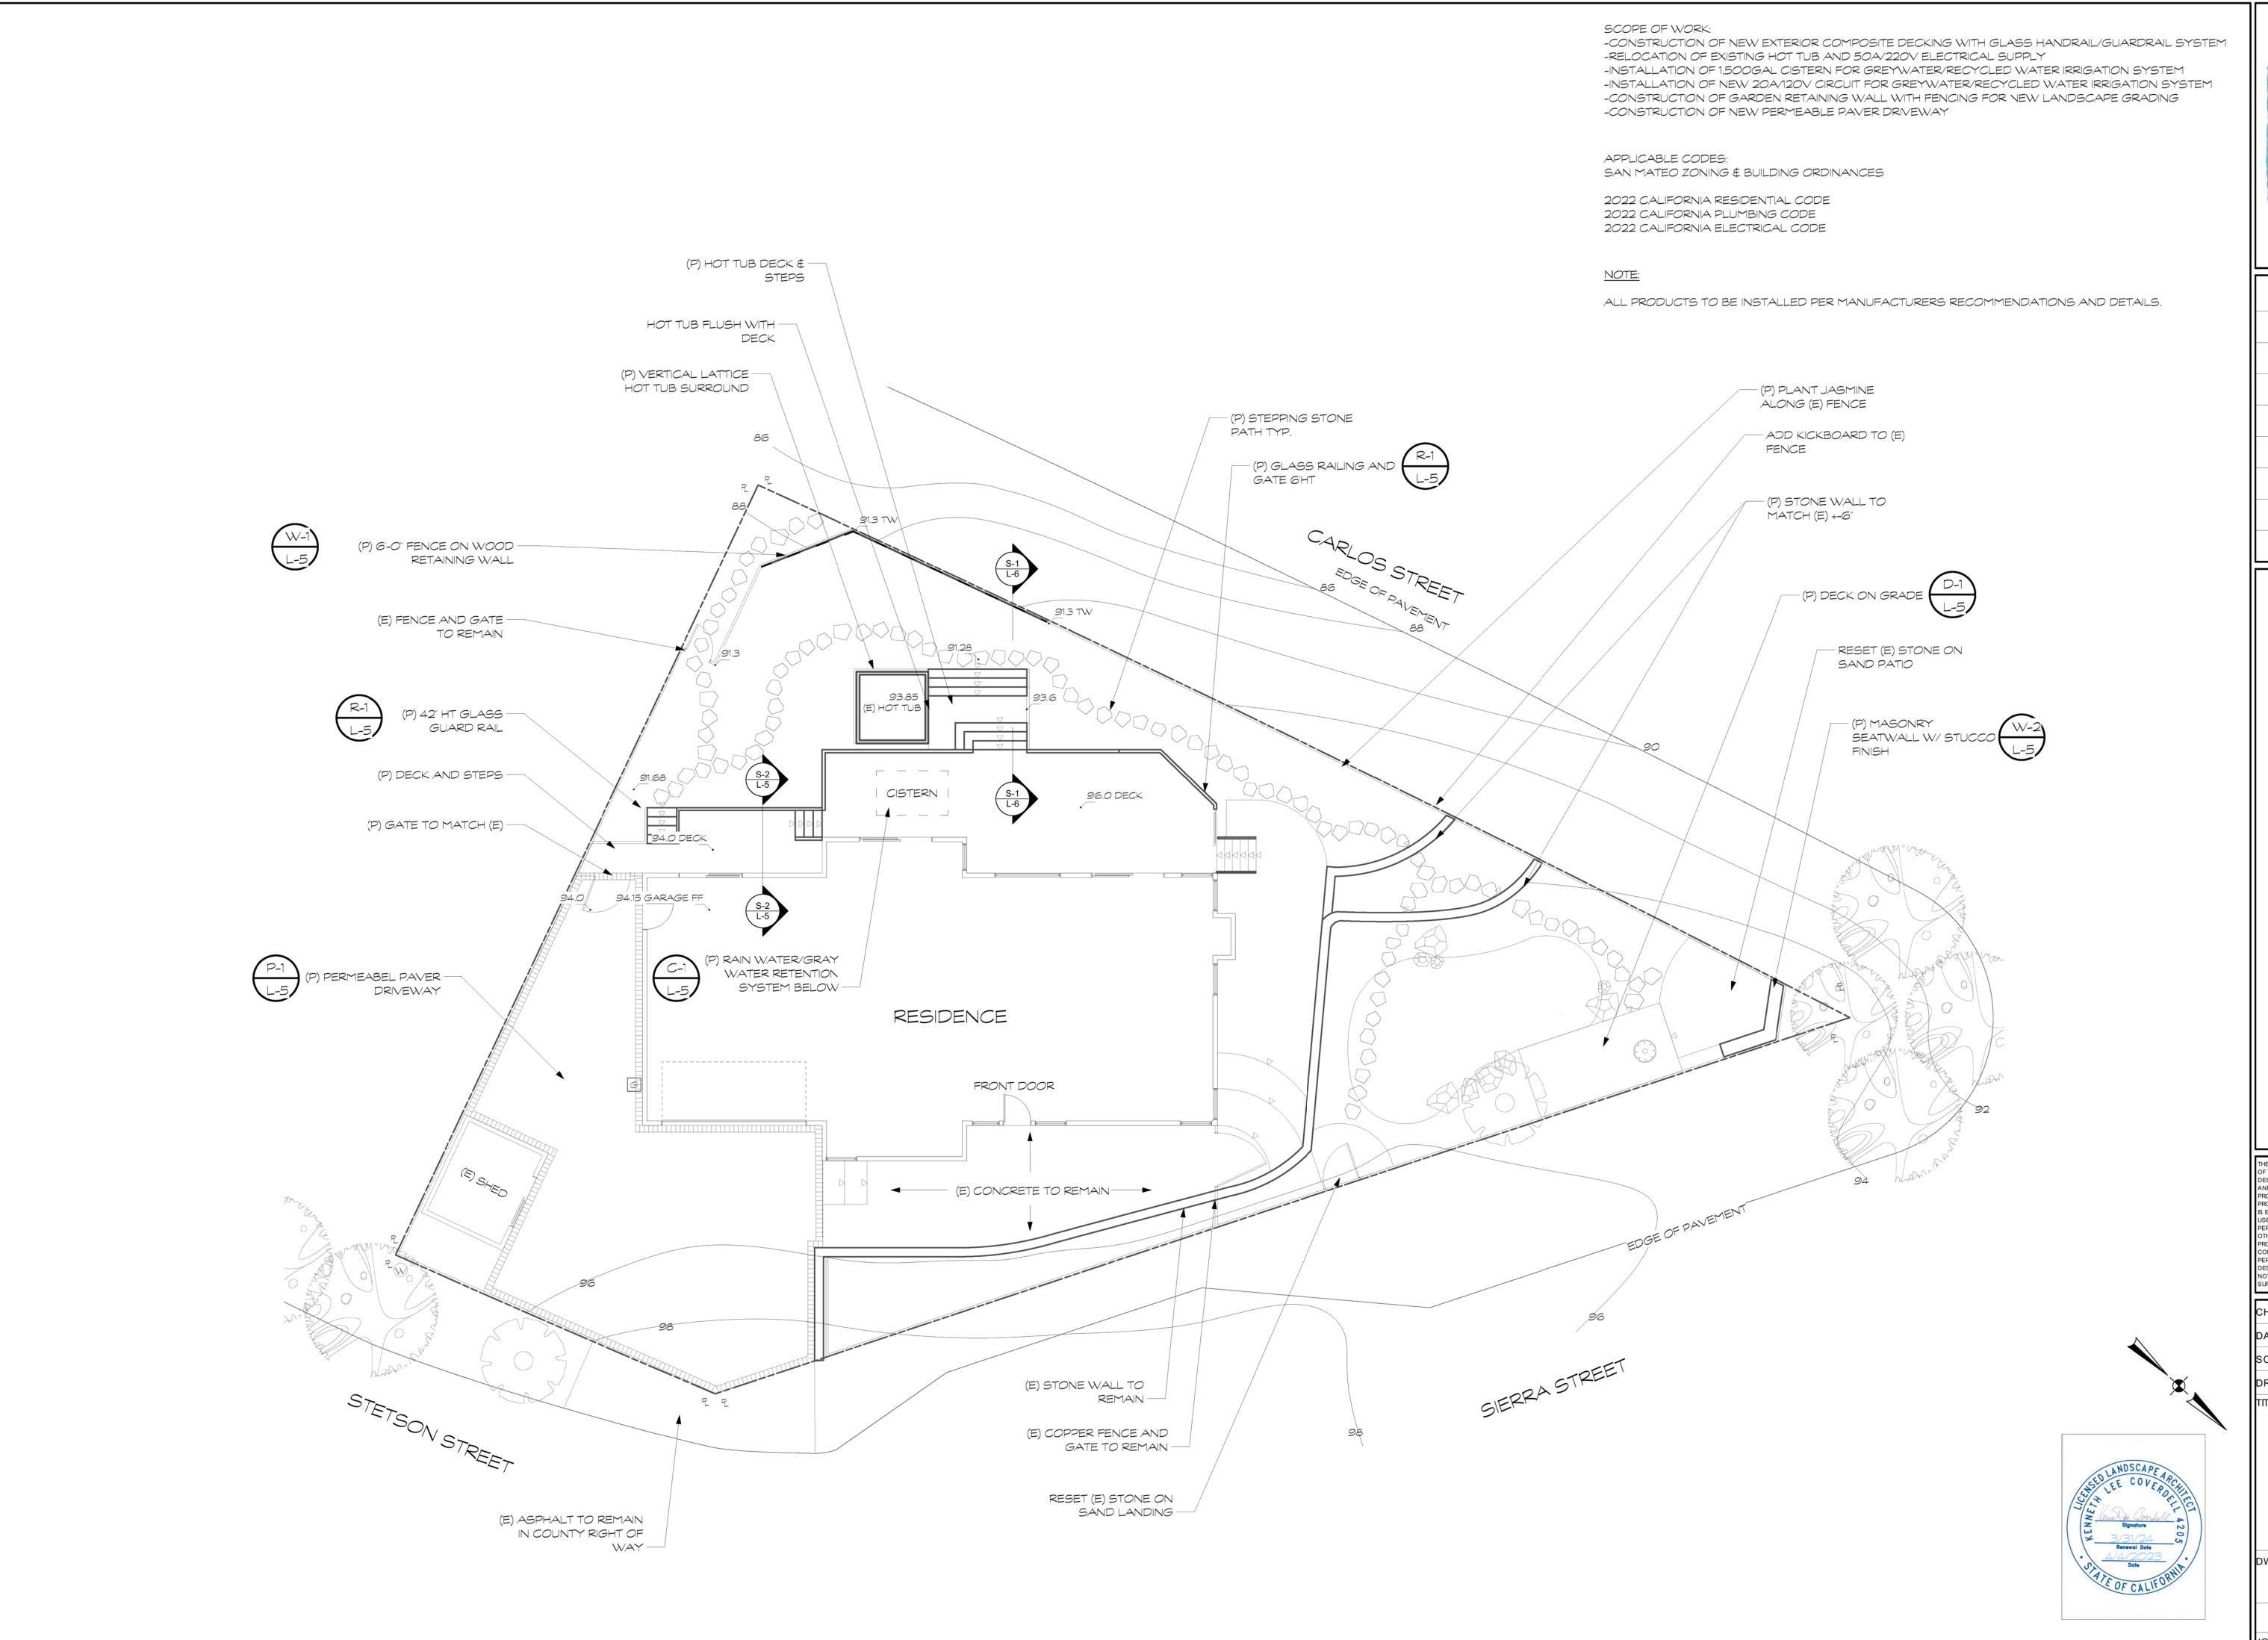LANDSCAPE CONTRACTOR'S LICENSE #C27-436094

GENERAL CONTRACTOR'S LICENSE #B-436094

LANDSCAPE ARCHITECT'S LICENSE #LA-4205

495 PURISIMA WAY, HALF MOON BAY, CA 9401

REVISIONS						
DATE	BY					

# TIRST-MCAFEE RESIDENCE

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CHECKED K.C.

DATE 4/4/2023


SCALE 1/8" = 1'


DRAWN K.C.

LANDSCAPE SITEPLAN


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SHEET 60F 7




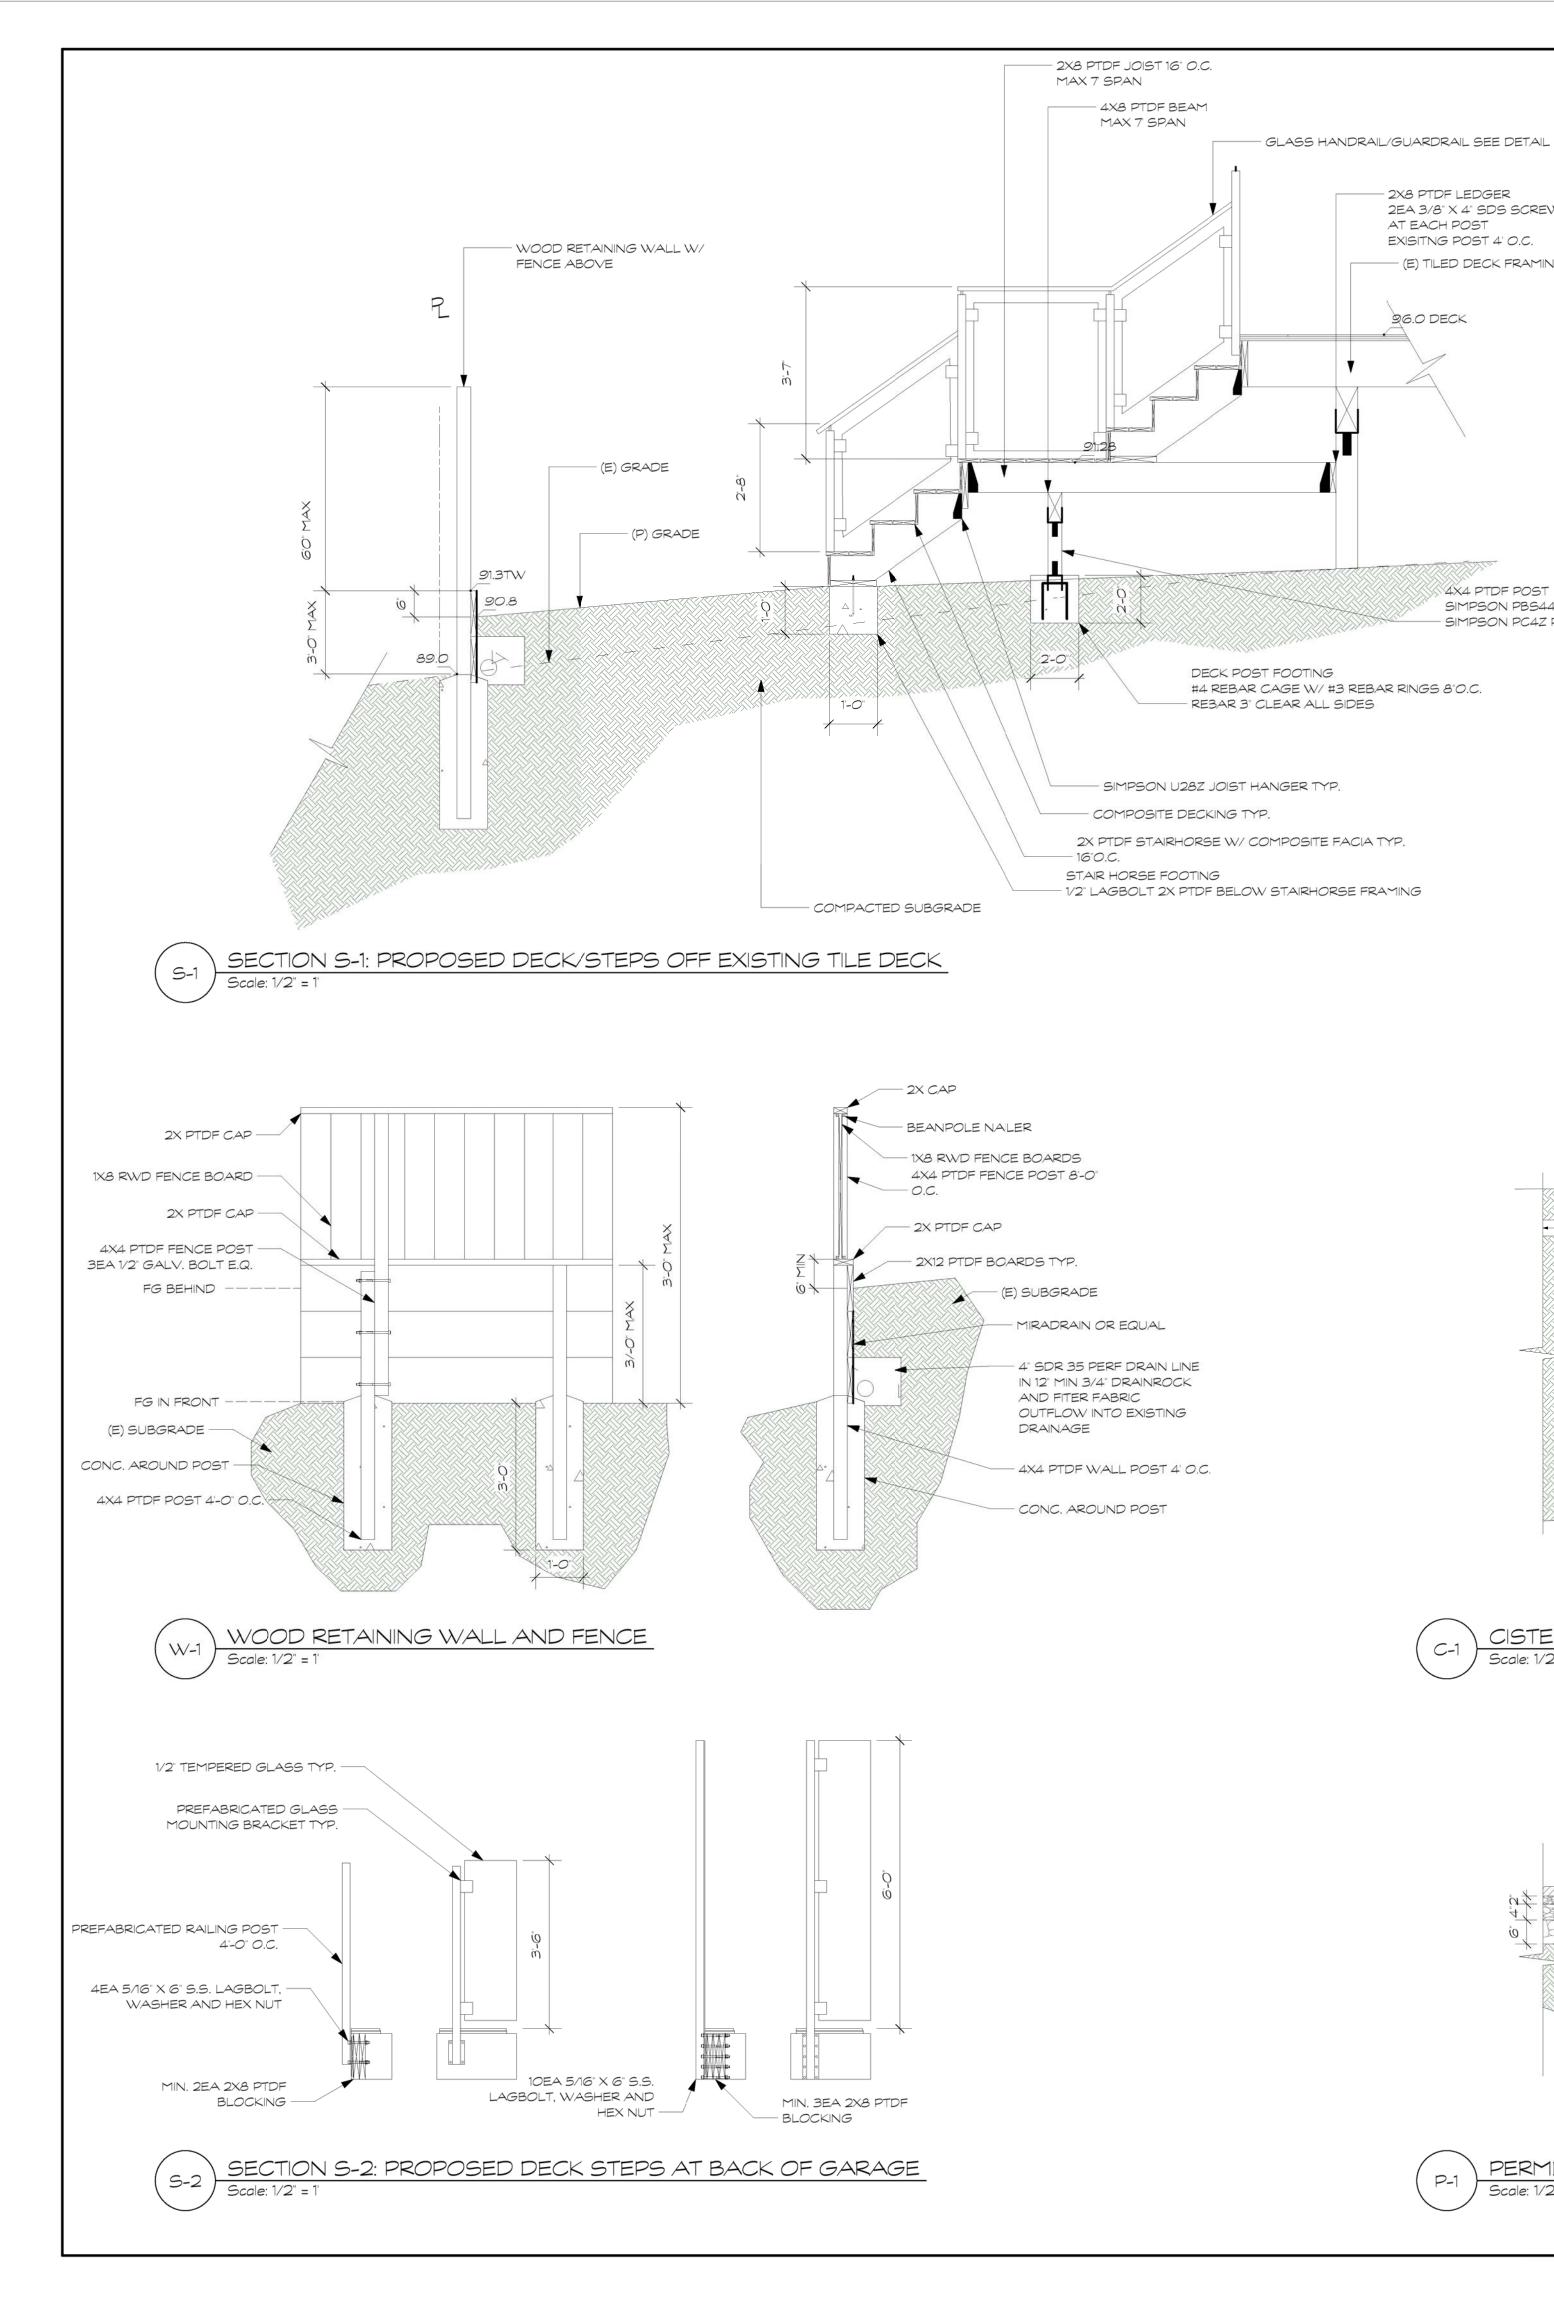

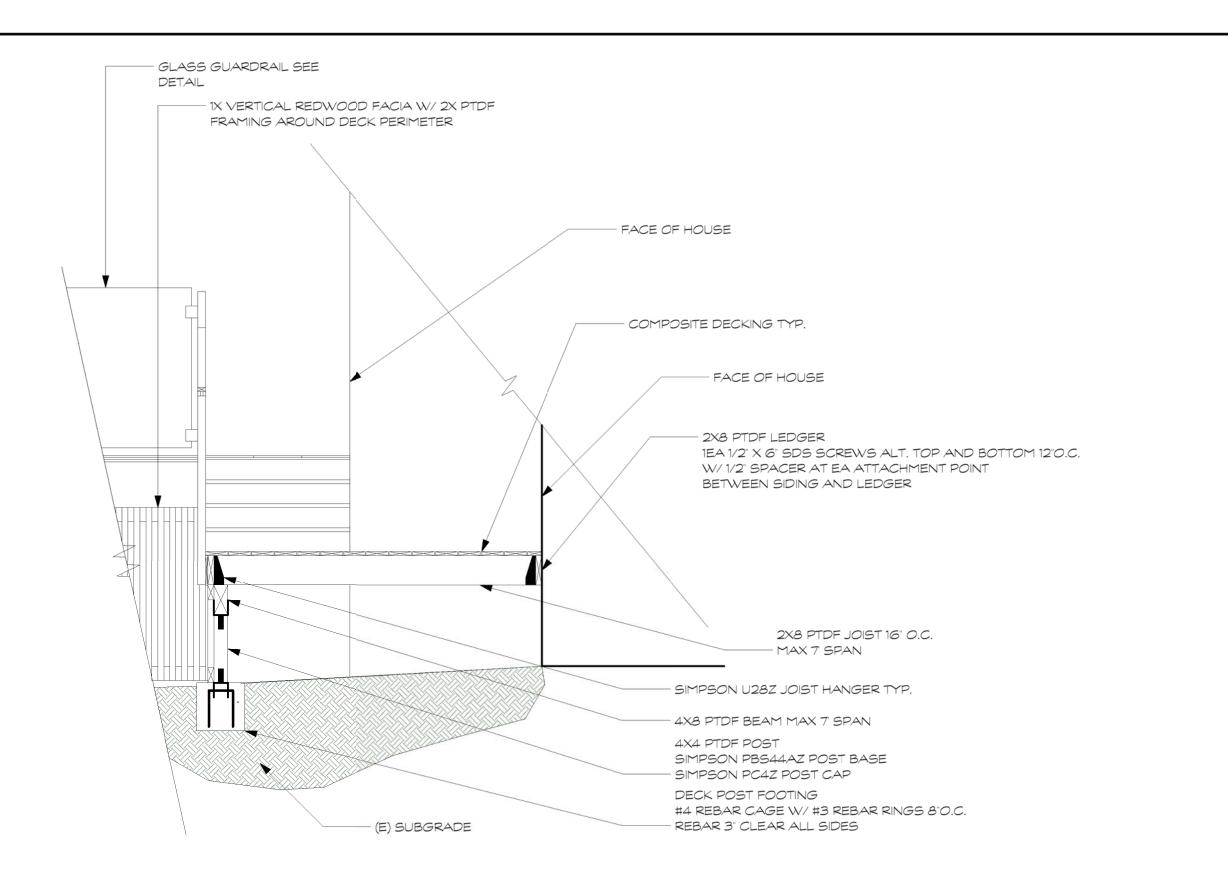SECTION S-2: PROPOSED DECK STEPS AT BACK OF GARAGE Scale: 1/2" = 1

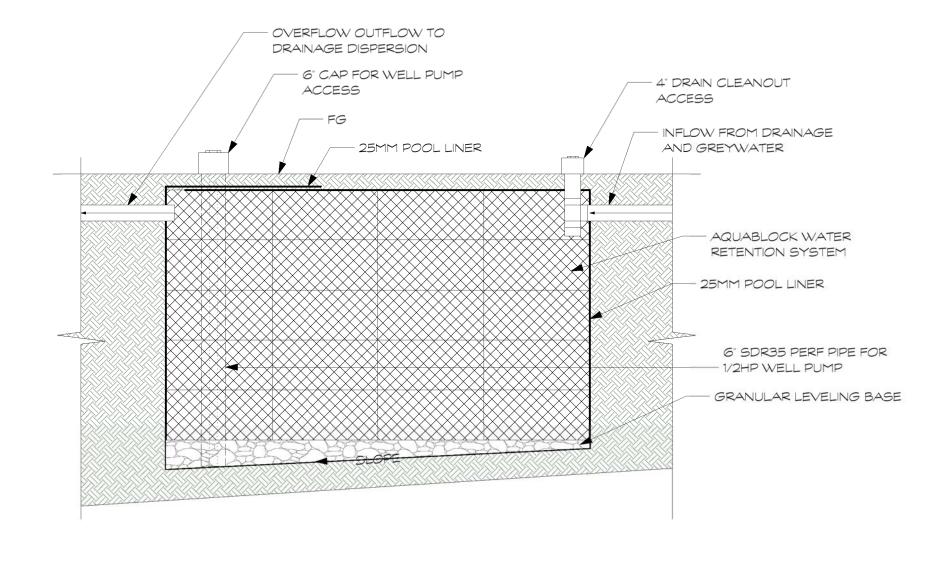

CISTERN FOR GREYWATER/RECYCLED WATER IRRIGAITON SYSTEM

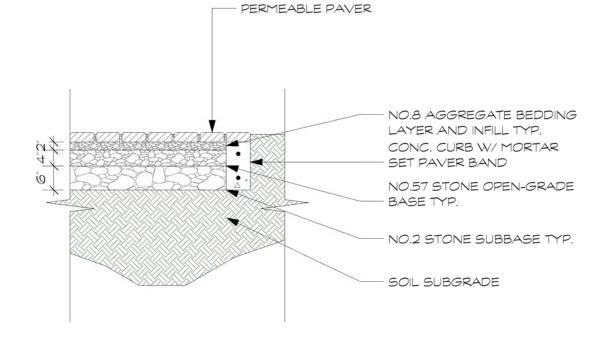

PERMEABLE PAVER DRIVEWAY Scale: 1/2" = 1

- 2X8 PTDF LEDGER

EXISITNG POST 4' O.C.

AT EACH POST

96.0 DECK

2EA 3/8" X 4" SDS SCREWS

— (E) TILED DECK FRAMING

4X4 PTDF POST

SIMPSON PBS44AZ POST BASE - SIMPSON PC4Z POST CAP

SCOPE OF WORK:

-CONSTRUCTION OF NEW EXTERIOR COMPOSITE DECKING WITH GLASS HANDRAIL/GUARDRAIL SYSTEM -RELOCATION OF EXISTING HOT TUB AND 50A/220V ELECTRICAL SUPPLY -INSTALLATION OF 1,500GAL CISTERN FOR GREYWATER/RECYCLED WATER IRRIGATION SYSTEM

-INSTALLATION OF NEW 20A/120V CIRCUIT FOR GREYWATER/RECYCLED WATER IRRIGATION SYSTEM -CONSTRUCTION OF GARDEN RETAINING WALL WITH FENCING FOR NEW LANDSCAPE GRADING -CONSTRUCTION OF NEW PERMEABLE PAVER DRIVEWAY

APPLICABLE CODES: SAN MATEO ZONING & BUILDING ORDINANCES

2022 CALIFORNIA RESIDENTIAL CODE 2022 CALIFORNIA PLUMBING CODE 2022 CALIFORNIA ELECTRICAL CODE

OBHIRST-McAFEE

NOTE:

ALL PRODUCTS TO BE INSTALLED PER MANUFACTURERS RECOMMENDATIONS AND DETAILS.

REVISIONS DATE

OF THEM, HOWEVER EXECUTED) AND THE DESIGN CONCEPTS CONVEYED BY THEM ARE ND SHALL REMAIN THE EXCLUSIVE ROPERTY OF THE DESIGNER WHETHER TH PROJECT FOR WHICH THEY WERE CREATED EXECUTED OR NOT. THEY MAY NOT BE USED IN WIHOLE OR IN PART BY ANY PERSON OR BUSINESS ENTITY OR ANY THER PROJECT NOR EXTENSIONS OF THIS PROJECT WITHOUT APPROPRIATE COMPENSATION TO, AND WRITTEN ERMISSION FROM THE DESIGNER. THE DESIGNER ASSUMES NO LIABILITY FOR IDEA. NOT EXECUTED BY, OR UNDER THE DIRECT UPERVISION OF, BLUE SKY DESIGNS, INC.

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SCALBEE DRAWING

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CONSTRUCTION DETAILS

DWG. NO.

SHEET 7 OF 7