SHEET NUMBER

KITCHEN

LAUNDRY

LANDING

LAVATORY

MAXIMUM

MINIMUM

MOUNTED

MULLION

MECHANICAL

MEDICINE CABINET

MANUFACTURER

NOT APPLICABLE

NOT TO SCALE

ON CENTER

OVERHANG

PERFORATED

PROPERTY LINE

PARTIALLY OPERABLE

PRESSURE TREATED

OR POST TENSIONED

OPENING

PLATE

PLAS. LAM. PLASTIC LAMINATE

PAINTED

PLYWOOD

RECESSED

REQUIRED

SOLID CORE

SCHEDULE

SUBFLOOR

SAFETY GLAZING

SECTION

SHELF

SHELVES

SHEET

SIMILAR

SHEET METAL

SPECIFICATIONS

STAINLESS STEEL

TONGUE AND GROOVE

TOILET PAPER HOLDER

TREAD (OR TEMPERED)

UNLESS OTHERWISE NOTED

VERTICAL GRAIN DOUG. FIR

VINYL COMPOSITION TILE

TEMPERED GLASS

STANDPIPE

SQUARE

STANDARD

STORAGE

STRUCTURAL

SHEET VINYL

TOWEL BAR

TELEPHONE

THRESHOLD

TOP OF CURB

TOP OF PLATE

TOP OF SLAB

TOP OF WALL

TUBE STEEL

TYPICAL

VERTICAL

WASHER

WOOD

WINDOW

WITHOUT

VESTIBULE

VERIFY IN FIELD

WATER CLOSET

WATER HEATER

WHERE OCCURS

WATERPROOF

WHEELSTOP

TOP OF

STEEL

ROOM

REFRIGERATOR

ROUGH OPENING

RAINWATER LEADER

SEE CIVIL DRAWINGS

SEE ARCHITECTURAL DRAWINGS

SEE STRUCTURAL DRAWINGS

SEE ELECTRICAL DRAWINGS

SEE LANDSCAPE DRAWINGS

SEE PLUMBING DRAWINGS

SEE MECHANICAL DRAWINGS

REINFORCED

NOT IN CONTRACT

LIGHT

LAND'G

M.C.

MFR.

MIN.

OPNG.

PLYWD.

REQ'D

R.O.

R.W.L

S.A.D.

S.C.

S.C.D

S.S.D

SCH.

SEC.

S.G.

SIM.

S.L.D.

S.M.

S.M.D.

S.P.D.

S.S.

STD.

STRUC^{*}

T&G

T.O.

T.O.PL.

T.O.S.

T.O.W.

TYP.

U.O.N.

VERT.

VEST.

V.G.D.F

WD.

WDW.

W/O

W.O.

TEMP.GL

THRESH

SHLVS.

INTERIOR

ABBREVIATIONS

ACOUS

ADJ.

BD.

BLDG.

BLKG

B.S.W.

CLG.

CLR.

C.M.U

COL.

CONC

CONN.

CONT.

CONST

CNTR.

CSMT

DET

DIM.

DR.

D.S.

DWG.

ELEV.

ELEC.

ENCL

EQ.

EXT.

FDN.

F.E.

F.E.C.

FIN.

FLASH'(

FLEX

F.O.B.

F.O.C

F.O.S.

F.O.W

G.B.

GLAZ.

G.S.M.

G.W.B

GYP.

HDWR

HORIZ

HPR.

HT.

INSUL

INTERM.

INT.

FLR.

EQPT

CLKG.

CEM.PLAS.

ALUM.

AND

ANGLE

ABOVE

ANCHOR BOLT

ACCESSIBLE

ACOUSTICAL

AREA DRAIN

ADJACENT

ALUMINIUM

AUTOMATIC

BALCONY

BUILDING

BLOCKING

BETWEEN

CABINET

CEILING

CLOSET

COLUMN

COUNTER

DRYER

DOUBLE

DETAIL

DOOR

EACH

DIAMETER

DIMENSION

DOWNSPOUT

EXPANSION JOINT

ELECTRIC PANEL

FRESH AIR INTAKE

FIRE EXTINGUISHER

FINISH OR FINISHED

FACE OF CONCRETE

GALVINIZED SHEET METAL

GYPSUM WALL BOARD

FINISHED FLOOR

FACE OF BEAM

FACE OF FINISH

FACE OF STUD

FACE OF WALL

FIRE EXTINGUISHER CABINET

DRAWING

ELEVATION

ENCLOSURE

EQUIPMENT

FLOOR DRAIN

FOUNDATION

FLASHING

FLEXIBLE

FLOOR

FOOT

FOOTING

GAUGE

GARAGE

GRAB BAR

GLAZING

GYPSUM

HOPPER

HANDRAIL

HEIGHT

INCHES

INSULATION

INTERMEDIATE

INTERIOR

JOINT

HOSE BIB

HARDWARE

HOLLOW METAL

HORIZONTAL

EXTERIOR

ELECTRIC

EQUAL

CASEMENT

CONCRETE

CONNECTION

CONTINUOUS

CONSTRUCTION

CLEAR

CAULKING

BOTTOM OF CURB

BACK OF SIDEWALK

CEMENT PLASTER

CONTROL JOINT

CONCRETE MASONRY UNIT

CENTERLINE

BOARD

ASPHALTIC CONC

ASSUMED PROPERTY LINE

ELEVATION NUMBER

PROJECT DESCRIPTION

THE CYPRESS POINT AFFORDABLE HOUSING PROJECT INCLUDES 71 NEW AFFORDABLE FAMILY HOUSING UNITS WITH A MIX OF 1-, 2- AND 3-BR UNITS. NEW BUILDINGS ARE ORGANIZED AROUND A SHARED CENTRAL OPEN SPACE, WITH HOMES ARRANGED TO TAKE ADVANTAGE OF HILLSIDE OCEAN VIEWS WHILE ALSO CREATING A CLOSE KNIT COMMUNITY A SHARED COMMUNITY BUILDING AT THE HEART OF THE NEW COMMUNITY PROVIDES INDOOR AND OUTDOOR GATHERING SPACES, SHARED LAUNDRY AND RESIDENT SERVICES INCLUDING AFTER SCHOOL PROGRAMS FOR RESIDENTS.

THE EFFICIENT ARRANGEMENT OF NEW HOMES ON THE PREVIOUSLY DEVELOPED PORTION OF THE SITE ALLOWS APPROXIMATELY 50% OF THE SITE TO REMAIN OPEN SPACE AND FROM STREETS. OPEN SPACE AREAS UTILIZE NATIVE PLANTINGS FOR ADDITIONAL SCREENING BETWEEN NEW HOMES AND THE EXISTING NEIGHBORHOOD.

ACCESS TO THE SITE IS PROVIDED VIA A NEW DRIVE FROM CARLOS STREET. THE RESIDENTIAL LOOP ROAD PROVIDES ACCESS TO RESIDENT PARKING AND THE SITE FOR EMERGENCY VEHICLES. NEIGHBORS ARE PROVIDED WITH ACCESS TO THE OPEN AREAS OF THE SITE VIA NEW TRAILS THROUGH THE SOUTHERN PORTION OF THE SITE; ACCESS POINTS ARE LOCATED ON CARLOS STREET, SIERRA STREET AND LINCOLN STREET

BUILDINGS AND CAREFUL INTEGRATION WITH THE TOPOGRAPHY ENSURES THAT BUILDINGS NEIGHBORING HOMES AND ADDRESSING NIGHT SKY REQUIREMENTS. SUSTAINABLE CHARGING STATIONS, SECURE BICYCLE STORAGE, COMMUNITY GARDEN AND CONVENIENT PEDESTRIAN ROUTES TO ENCOURAGE WALKING.

CYPRESS POINT FAMILY COMMUNITY

CARLOS STREET, MOSS BEACH, SAN MATEO COUNTY, CA

REVISED COASTAL DEVELOPMENT PERMIT SET - JANUARY 2024

510.465.7010 p | 510.465.8575 f

OAKLAND, CA 94612

MidPen H O U S I N G

MIDPEN HOUSING 303 Vintage Park Drive Foster City, CA 94404

STAMP:

REVISION SCHEDULE

JOB NUMBER: DRAWN BY: CHECKED BY January 24, 2024 SCALE: 12" = 1'-0"

NOT FOR CONSTRUCTION

PROJECT TEAM

NUMBER

OWNER / APPLICANT MIDPEN HOUSING CORP. 303 VINTAGE PARK DRIVE, SUITE 250 FOSTER CITY, CA 94404 650.339.0581 CONTACT: SERENA IP

ARCHITECT PYATOK ARCHITECTS 1611 TELEGRAPH AVENUE, SUITE 200 OAKLAND, CA 94612 510.465.7010

CONTACT: PETER WALLER

CIVIL ENGINEER BKF ENGINEERS 255 SHORELINE DRIVE, SUITE 200 REDWOOD CITY, CA 94065 CONTACT: LAUREN BOYLE BERMAN

LANDSCAPE ARCHITECT JONI L. JANECKI & ASSOCIATES, INC. 515 SWIFT STREET SANTA CRUZ, CA 95060 831.423.6040 CONTACT: GEORGIA LEUNG **DRY UTILITY**

5820 STONERIDGE MALL RD., #345 PLEASANTON, CA 94588 925-467-1740 CONTACT: ROSA OLIVARES

CODE (ACCESSIBILITY) CONTACT:

CONTACT:

GIACALONE DESIGN

CODE (FIRE LIFE SAFETY, FIRE ALARM & SPRINKLER)

STRUCTURAL ENGINEER

ELEMENT 580 2ND ST., SUITE 255 OAKLAND, CA 94607 510.573.1557 CONTACT: THUY FONTELERA

MECHANCIAL / ELECTRICAL / PLUMBING ENGINEERS EMERALD CITY ENGINEERING

150 8TH STREET SAN FRANCISCO, CA 94103 425-741-1200 CONTACT: ADAM FRENCH

WATERPROOFING CONSULTANT STEELHEAD ENGINEERS INC. 2708 WASATCH DRIVE MOUNTAIN VIEW, CA 94040 CONTACT: ALAN E. BURNETT

SUSTAINABILITY (T24, GPR, SOLAR) **BEYOND EFFICIENCY**

BERKELEY, CA 415.236.1333 CONTACT: JENNIFER LOVE **ACOUSTICAL**

CONTACT:

SPECIFICATION WRITER CONTACT: GLORIA ABSTON EMAIL: GLORIA@PAWPRINTSPECS.COM

CONSTRUCTION TYPE: TYPE VB TYPE VB OCCUPANCY TYPE:

0.94 ACRES 2 STORIES, 28' MAXIMUM 142 SPACES

PROJECT DATA

THE PROPOSED PROJECT CONSISTS OF 71 UNITS OF NEW AFFORDABLE MULTIFAMILY RESIDENTIAL | BUILDING GROSS AREAS UNITS IN 16 BUILDINGS, AND A COMMUNITY BUILDING FOR RESIDENT SERVICES AND LEASING.

PROJECT ADDRESS: CARLOS STREET, MOSS BEACH, SAN MATEO COUNTY, CA

SITE AREA: 11.02 ACRES **TOTAL UNITS: 71 UNITS** SITE DENSITY: 6.4 UNITS / ACRE

> **COMMUNITY BUILDING** RESIDENTIAL BUILDINGS

DEVELOPMENT STANDARDS

AERIAL CONTEXT

Google Earth

<u>PROVIDED</u> 20 FT **BLDG. SETBACK WEST** 157 FT **BLDG. SETBACK SOUTH** 182 FT BLDG. SETBACK EAST 137 FT **BLDG. SETBACK NORTH**

LOT COVERAGE **BUILDING HEIGHT** PARKING SPACES

*GROSS AREA CALCULATIONS INCLUDE COVERED EXT CIRCULATION					
BUILDING TYPE BUILDING TYPE A BUILDING TYPE B BUILDING TYPE C BUILDING TYPE D BUILDING TYPE E BUILDING TYPE F	QUANTITY [1 BLDG] [1 BLDG] [4 BLDGS] [1 BLDG] [1 BLDG] [8 BLDGS]	SF PER BUILDING 9,243 SF 6,663 SF 3,703 SF 11,060 SF 3,703 SF 2,321 SF	TOTAL SF 9,243 SF 6,663 SF 14,812 SF 11,060 SF 3,703 SF 18,568 SF		
TOTAL SF OF RESIDENTIAL BLDGS: 64,049 SF					
COMMUNITY BUILDING	[1 BLDG]	3,369 SF	3,369 SF		
TOTAL SF OF ALL BUILDINGS: 67,418 SF					

	UNIT TYPE	<u>DESCRIPTION</u>	# UNITS	% OF TOTAL	UNIT AREA (SF)		
TAL SF	A1	1-BR FLAT	16	22.5	497 SF		
,243 SF	B1	2-BR FLAT	23	32.0	805 SF		
,663 SF	B2	2-BR FLAT	12	17.0	805 SF		
,812 SF	B3	2-BR FLAT	1	1.5	887 SF		
,060 SF	B4	2-BR TH (MGR)	1	1.5	1,144 SF		
,703 SF	C1	3-BR FLAT	2	3.0	1,012 SF		
,568 SF	C2	3-BR TH	15	21.0	1,144 SF		
	C3	3-BR FLAT	1	1.5	1,086 SF		
,049 SF							
260.05	TOTAL # OF	UNITS:	71	100.0			
,369 SF	UNIT ACCESSIBILITY SUMMARY						
,418 SF							
,		IITS REQUIRED					
	(MIN 15% OF	EACH UNIT TYPE I	PER TCAC)			
	UNIT TYPE	TOTAL # OF UNIT	S M	N REQUIRED	PROVIDED		
	1-BR 16		<u> </u>	2.4	3		

3-BR 2.7 ADAPTABLE UNITS REQUIRED (ALL GROUND FLOOR FLATS & MIN 10% TOWNHOMES VISITABLE PER CBC 11B) ADAPTABLE FLATS: 16 UNITS VISITABLE TOWNHOMES: 2 UNITS

5.55

2-BR

APPLICABLE CODES & STANDARDS

2022 CALIFORNIA BUILDING CODE 2022 CALIFORNIA ELECTRICAL CODE 2022 CALIFORNIA MECHANICAL CODE 2022 CALIFORNIA PLUMBING CODE 2022 CALIFIRONIA ENERGY CODE 2022 CALIFORNIA FIRE CODE INCLUDING APENDICES B, C, & D 2022 CALGREEN NFPA 10, 13R, 72, & 80 COASTSIDE FIRE PROTECTION DISTRICT DEVELOPED STANDARDS

ACCESSIBILITY SUMMARY

THIS PROJECT IS A PUBLICLY FUNDED PROJECT COMPLYING WITH CHAPTER 11B OF THE CALIFORNIA BUILDING CODE (CBC).

BUILDINGS TYPE A, B, C, D, E: MULTI-FAMILY, STACKED FLATS WITH STAIR-ONLY ACCESS TO LEVEL 2 UNITS DWELLING UNITS WITH REQUIRED MOBILITY OR

TBD

COMMUNITY BUILDING: THE COMMUNITY BUILDING IS A LEASING OFFICE, RESIDENTIAL SERVICES AND COMMUNITY CENTER AND COMPLIES WITH CHAPTER 11B OF THE CBC.

RESIDENTIAL BUILDINGS: MINIMUM 15% 1-BR 11B MOBILITY UNITS MINIMUM 15% 2-BR 11B MOBILITY UNITS MINIMUM 15% 3-BR 11B MOBILITY UNITS

ALL OTHER GROUND FLOOR FLATS 11B ADAPTABLE 10% OF TOWNHOMES 11B VISITABLE

BUILDING TYPE F: MULTI-FAMILY, NON-ELEVATOR-SERVED BUILDINGS COMPRISED OF MULTI-STORY TOWNHOMES WITH GROUND-LEVEL ENTRIES 15% OF UNITS MUST COMPLY WITH 11B, AND PROVIDE

AN ACCESSIBLE ROUTE

HEARING / VISUALLY IMPAIRED FEATURES ARE ALSO LOCATED ON THE GROUND-LEVEL, AND SHALL COMPLY WITH CHAPTER 11B OF THE CBC.

DEFERRED SUBMITTALS

TITLE SHEET

DRAWING INDEX

SHEET NUMBER	SHEET NAME	Original CDP	CDP Upo
GENERAL			
G0.00	TITLE SHEET	•	•
G0.01	SHEET INDEX	•	•
G1.01	RENDERED SITE VIEWS	•	•
G1.02	RENDERED SITE VIEWS	•	•
G1.03	RENDERED SITE VIEWS	•	•
G1.04	MATERIALS BOARD	•	•
6			
SURVEY			
0 OF 4	TOPOGRAPHIC SURVEY	•	•
1	1101 0010 11110 0011121		
CIVIL			
C1.0	EXISTING CONDITIONS PLAN	•	•
C2.0	SITE PLAN	•	•
C3.0	SITE GRADING PLAN	•	•
C4.0	PROPOSED UTILTIES	•	•
C5.0	DRIVEWAY PLAN AND PROFILE	•	
C6.0	STORMWATER CONTROL PLAN	•	•
C7.0	CONSTRUCTION DETAILS	•	
C8.0	EROSION CONTROL PLAN	•	
C8.1	EROSION CONTROL DETAILS		
TPZ1.01 TPZ1.02	TREE REMOVAL LIST TREE PROTECTION NOTES	•	•
L1.00	OVERALL LANDSCAPE SITE PLAN	•	•
L1.01	LANDSCAPE MATERIAL DETAILS	•	•
L1.02	LANDSCAPE MATERIAL DETAILS	•	•
L1.03	LANDSCAPE MATERIAL DETAILS	•	•
ARCHITECT	JRE		
A1.00	OVERALL SITE PLAN	•	•
A1.01	OVERALL SITE ROOF PLANS	•	•
A2.11	FLOOR & ROOF PLANS - BUILDING TYPE A (BUILDING 1)	•	•
	FLOOR & ROOF PLANS - BUILDING TYPE B (BUILDING 2)	•	•
A2.12	FLOOR & ROOF PLANS - BUILDING TYPE C (BUILDINGS 3,5,& 6)	•	•
A2.12 A2.13	TEOOR & ROOF TEARS - BOILDING THE C (BOILDINGS 3,3,& 0)		_
	FLOOR & ROOF PLANS - BUILDING TYPE C (BUILDING 4, L1 MOBILITY UNITS)	•	•
A2.13	1	•	•
A2.13 A2.14	FLOOR & ROOF PLANS - BUILDING TYPE C (BUILDING 4, L1 MOBILITY UNITS)	_	•
A2.13 A2.14 A2.15	FLOOR & ROOF PLANS - BUILDING TYPE C (BUILDING 4, L1 MOBILITY UNITS) FLOOR & ROOF PLANS - BUILDING TYPE D (BUILDING 7)	_	•
A2.13 A2.14 A2.15 A2.16	FLOOR & ROOF PLANS - BUILDING TYPE C (BUILDING 4, L1 MOBILITY UNITS) FLOOR & ROOF PLANS - BUILDING TYPE D (BUILDING 7) FLOOR & ROOF PLANS - BUILDING TYPE E (BUILDING 8)	_	•
A2.13 A2.14 A2.15 A2.16 A2.17	FLOOR & ROOF PLANS - BUILDING TYPE C (BUILDING 4, L1 MOBILITY UNITS) FLOOR & ROOF PLANS - BUILDING TYPE D (BUILDING 7) FLOOR & ROOF PLANS - BUILDING TYPE E (BUILDING 8) FLOOR & ROOF PLANS - BUILDING TYPE F (BUILDINGS 9, 11-16)	•	•
A2.13 A2.14 A2.15 A2.16 A2.17 A2.18	FLOOR & ROOF PLANS - BUILDING TYPE C (BUILDING 4, L1 MOBILITY UNITS) FLOOR & ROOF PLANS - BUILDING TYPE D (BUILDING 7) FLOOR & ROOF PLANS - BUILDING TYPE E (BUILDING 8) FLOOR & ROOF PLANS - BUILDING TYPE F (BUILDINGS 9, 11-16) FLOOR & ROOF PLANS - BUILDING TYPE F (BUILDING 10)	•	•
A2.13 A2.14 A2.15 A2.16 A2.17 A2.18 A2.19	FLOOR & ROOF PLANS - BUILDING TYPE C (BUILDING 4, L1 MOBILITY UNITS) FLOOR & ROOF PLANS - BUILDING TYPE D (BUILDING 7) FLOOR & ROOF PLANS - BUILDING TYPE E (BUILDING 8) FLOOR & ROOF PLANS - BUILDING TYPE F (BUILDINGS 9, 11-16) FLOOR & ROOF PLANS - BUILDING TYPE F (BUILDING 10) FLOOR & ROOF PLANS - COMMUNITY BUILDING (BUILDING 17)	•	•
A2.13 A2.14 A2.15 A2.16 A2.17 A2.18 A2.19 A3.11	FLOOR & ROOF PLANS - BUILDING TYPE C (BUILDING 4, L1 MOBILITY UNITS) FLOOR & ROOF PLANS - BUILDING TYPE D (BUILDING 7) FLOOR & ROOF PLANS - BUILDING TYPE E (BUILDING 8) FLOOR & ROOF PLANS - BUILDING TYPE F (BUILDINGS 9, 11-16) FLOOR & ROOF PLANS - BUILDING TYPE F (BUILDING 10) FLOOR & ROOF PLANS - COMMUNITY BUILDING (BUILDING 17) ELEVATIONS - BUILDING TYPE A (BUILDING 1)	•	•
A2.13 A2.14 A2.15 A2.16 A2.17 A2.18 A2.19 A3.11 A3.12	FLOOR & ROOF PLANS - BUILDING TYPE C (BUILDING 4, L1 MOBILITY UNITS) FLOOR & ROOF PLANS - BUILDING TYPE D (BUILDING 7) FLOOR & ROOF PLANS - BUILDING TYPE E (BUILDING 8) FLOOR & ROOF PLANS - BUILDING TYPE F (BUILDINGS 9, 11-16) FLOOR & ROOF PLANS - BUILDING TYPE F (BUILDING 10) FLOOR & ROOF PLANS - COMMUNITY BUILDING (BUILDING 17) ELEVATIONS - BUILDING TYPE A (BUILDING 1) ELEVATIONS - BUILDING TYPE B (BUILDING 2)	•	•
A2.13 A2.14 A2.15 A2.16 A2.17 A2.18 A2.19 A3.11 A3.12 A3.13	FLOOR & ROOF PLANS - BUILDING TYPE C (BUILDING 4, L1 MOBILITY UNITS) FLOOR & ROOF PLANS - BUILDING TYPE D (BUILDING 7) FLOOR & ROOF PLANS - BUILDING TYPE E (BUILDING 8) FLOOR & ROOF PLANS - BUILDING TYPE F (BUILDINGS 9, 11-16) FLOOR & ROOF PLANS - BUILDING TYPE F (BUILDING 10) FLOOR & ROOF PLANS - COMMUNITY BUILDING (BUILDING 17) ELEVATIONS - BUILDING TYPE A (BUILDING 1) ELEVATIONS - BUILDING TYPE B (BUILDING 2) ELEVATIONS - BUILDING TYPE C (BUILDINGS 3-6)	•	•
A2.13 A2.14 A2.15 A2.16 A2.17 A2.18 A2.19 A3.11 A3.12 A3.13 A3.14	FLOOR & ROOF PLANS - BUILDING TYPE C (BUILDING 4, L1 MOBILITY UNITS) FLOOR & ROOF PLANS - BUILDING TYPE D (BUILDING 7) FLOOR & ROOF PLANS - BUILDING TYPE E (BUILDING 8) FLOOR & ROOF PLANS - BUILDING TYPE F (BUILDINGS 9, 11-16) FLOOR & ROOF PLANS - BUILDING TYPE F (BUILDING 10) FLOOR & ROOF PLANS - COMMUNITY BUILDING (BUILDING 17) ELEVATIONS - BUILDING TYPE A (BUILDING 1) ELEVATIONS - BUILDING TYPE B (BUILDING 2) ELEVATIONS - BUILDING TYPE C (BUILDINGS 3-6) ELEVATIONS - BUILDING TYPE D (BUILDING 7)	•	•
A2.13 A2.14 A2.15 A2.16 A2.17 A2.18 A2.19 A3.11 A3.12 A3.13 A3.14 A3.15	FLOOR & ROOF PLANS - BUILDING TYPE C (BUILDING 4, L1 MOBILITY UNITS) FLOOR & ROOF PLANS - BUILDING TYPE D (BUILDING 7) FLOOR & ROOF PLANS - BUILDING TYPE E (BUILDING 8) FLOOR & ROOF PLANS - BUILDING TYPE F (BUILDINGS 9, 11-16) FLOOR & ROOF PLANS - BUILDING TYPE F (BUILDING 10) FLOOR & ROOF PLANS - COMMUNITY BUILDING (BUILDING 17) ELEVATIONS - BUILDING TYPE A (BUILDING 1) ELEVATIONS - BUILDING TYPE B (BUILDING 2) ELEVATIONS - BUILDING TYPE C (BUILDINGS 3-6) ELEVATIONS - BUILDING TYPE D (BUILDING 7) ELEVATIONS - BUILDING TYPE E (BUILDING 8)	•	•

19 TOTAL SHEETS: 42

1611 TELEGRAPH AVE. SUITE 200 OAKLAND, CA 94612 510.465.7010 p | 510.465.8575 f www.pyatok.com

MidPen H O U S I N G

MIDPEN HOUSING 303 Vintage Park Drive Suite 250

Foster City, CA 94404

COMMUNIT FAMIL

SCALE:

SHEET INDEX

PYATOK

1611 TELEGRAPH AVE. SUITE 200
OAKLAND, CA 94612

510.465.7010 p | 510.465.8575 f www.pyatok.com

MidPen H O U S I N G

MIDPEN HOUSING

303 Vintage Park Drive Suite 250

Foster City, CA 94404

RENDERED SITE VIEWS



[VIEW 1] SIERRA STREET VIEW, TRANSPARENT LANDSCAPE



[VIEW 1] SIERRA STREET VIEW







[VIEW 2] LINCOLN STREET VIEW

1611 TELEGRAPH AVE. SUITE 200 OAKLAND, CA 94612

510.465.7010 p | 510.465.8575 f www.pyatok.com

MidPen H O U S I N G

MIDPEN HOUSING 303 Vintage Park Drive Suite 250 Foster City, CA 94404

CYPRESS POINT FAMILY COMMUNITY

 EVISION SCHEDULE

 O. ISSUE
 DATE

 1 Planning Resubmittal
 03/25/19

 2 Adjusted Heights
 07/10/20

 3 Coastal Development Permit
 06/21/22

 4 CDP Resubmittal
 12/01/23

 5 CDP Resubmittal
 01/24/24

JOB NUMBER: 160
DRAWN BY: GI
CHECKED BY: PV
DATE: January 24, 202
SCALE:
TITLE:

RENDERED SITE VIEWS

SHEET: **G1.02**



PYATOK

1611 TELEGRAPH AVE. SUITE 200
OAKLAND, CA 94612


510.465.7010 p | 510.465.8575 f www.pyatok.com

MidPen H O U S I N G

MIDPEN HOUSING

303 Vintage Park Drive Suite 250

Foster City, CA 94404

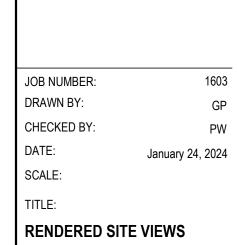

G1.03



[VIEW A] SITE ENTRY, TRANSPARENT LANDSCAPE



[VIEW B] INTERIOR SITE VIEW



MATERIAL PALETTE



1 Horizontal Cement Board, 9" Exposure Widths, Smooth Painted Finish




2) Horizontal Cement Board, 6" Exposure Widths, Smooth Painted Finish




Fiber Cement Board + Batten Siding, Variable Exposure Widths, Painted Finish



Certainteed Solaris
Composite Shingle Roof,
in Birchwood Color

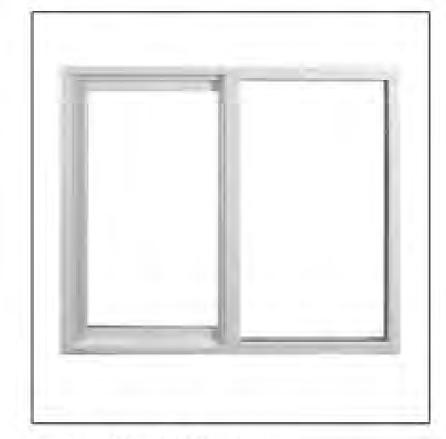

White Finish

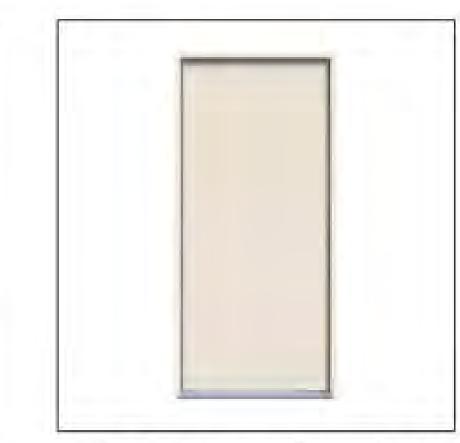

6 Fiberglass Entry Door, Painted



Wall Mounted
Exterior Light Fixture




8 Pole Mounted Exterior Lamp Fixture

COLOR PALETTE

HOUSING SIDING



A COUNTRY TWEE

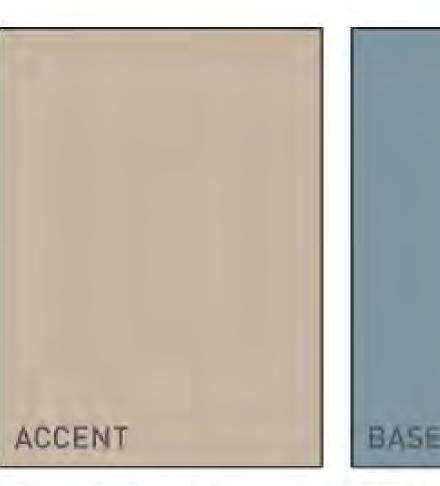

B PAVILION BEIGE SW 7512



C WHIRLPOOL SW 9135



SEA MARINER SW 9640

COMMUNITY BUILDING




E AESTHETIC WHITE SW 7035

MIDPEN HOUSING


MATERIALS BOARD

SHEET:

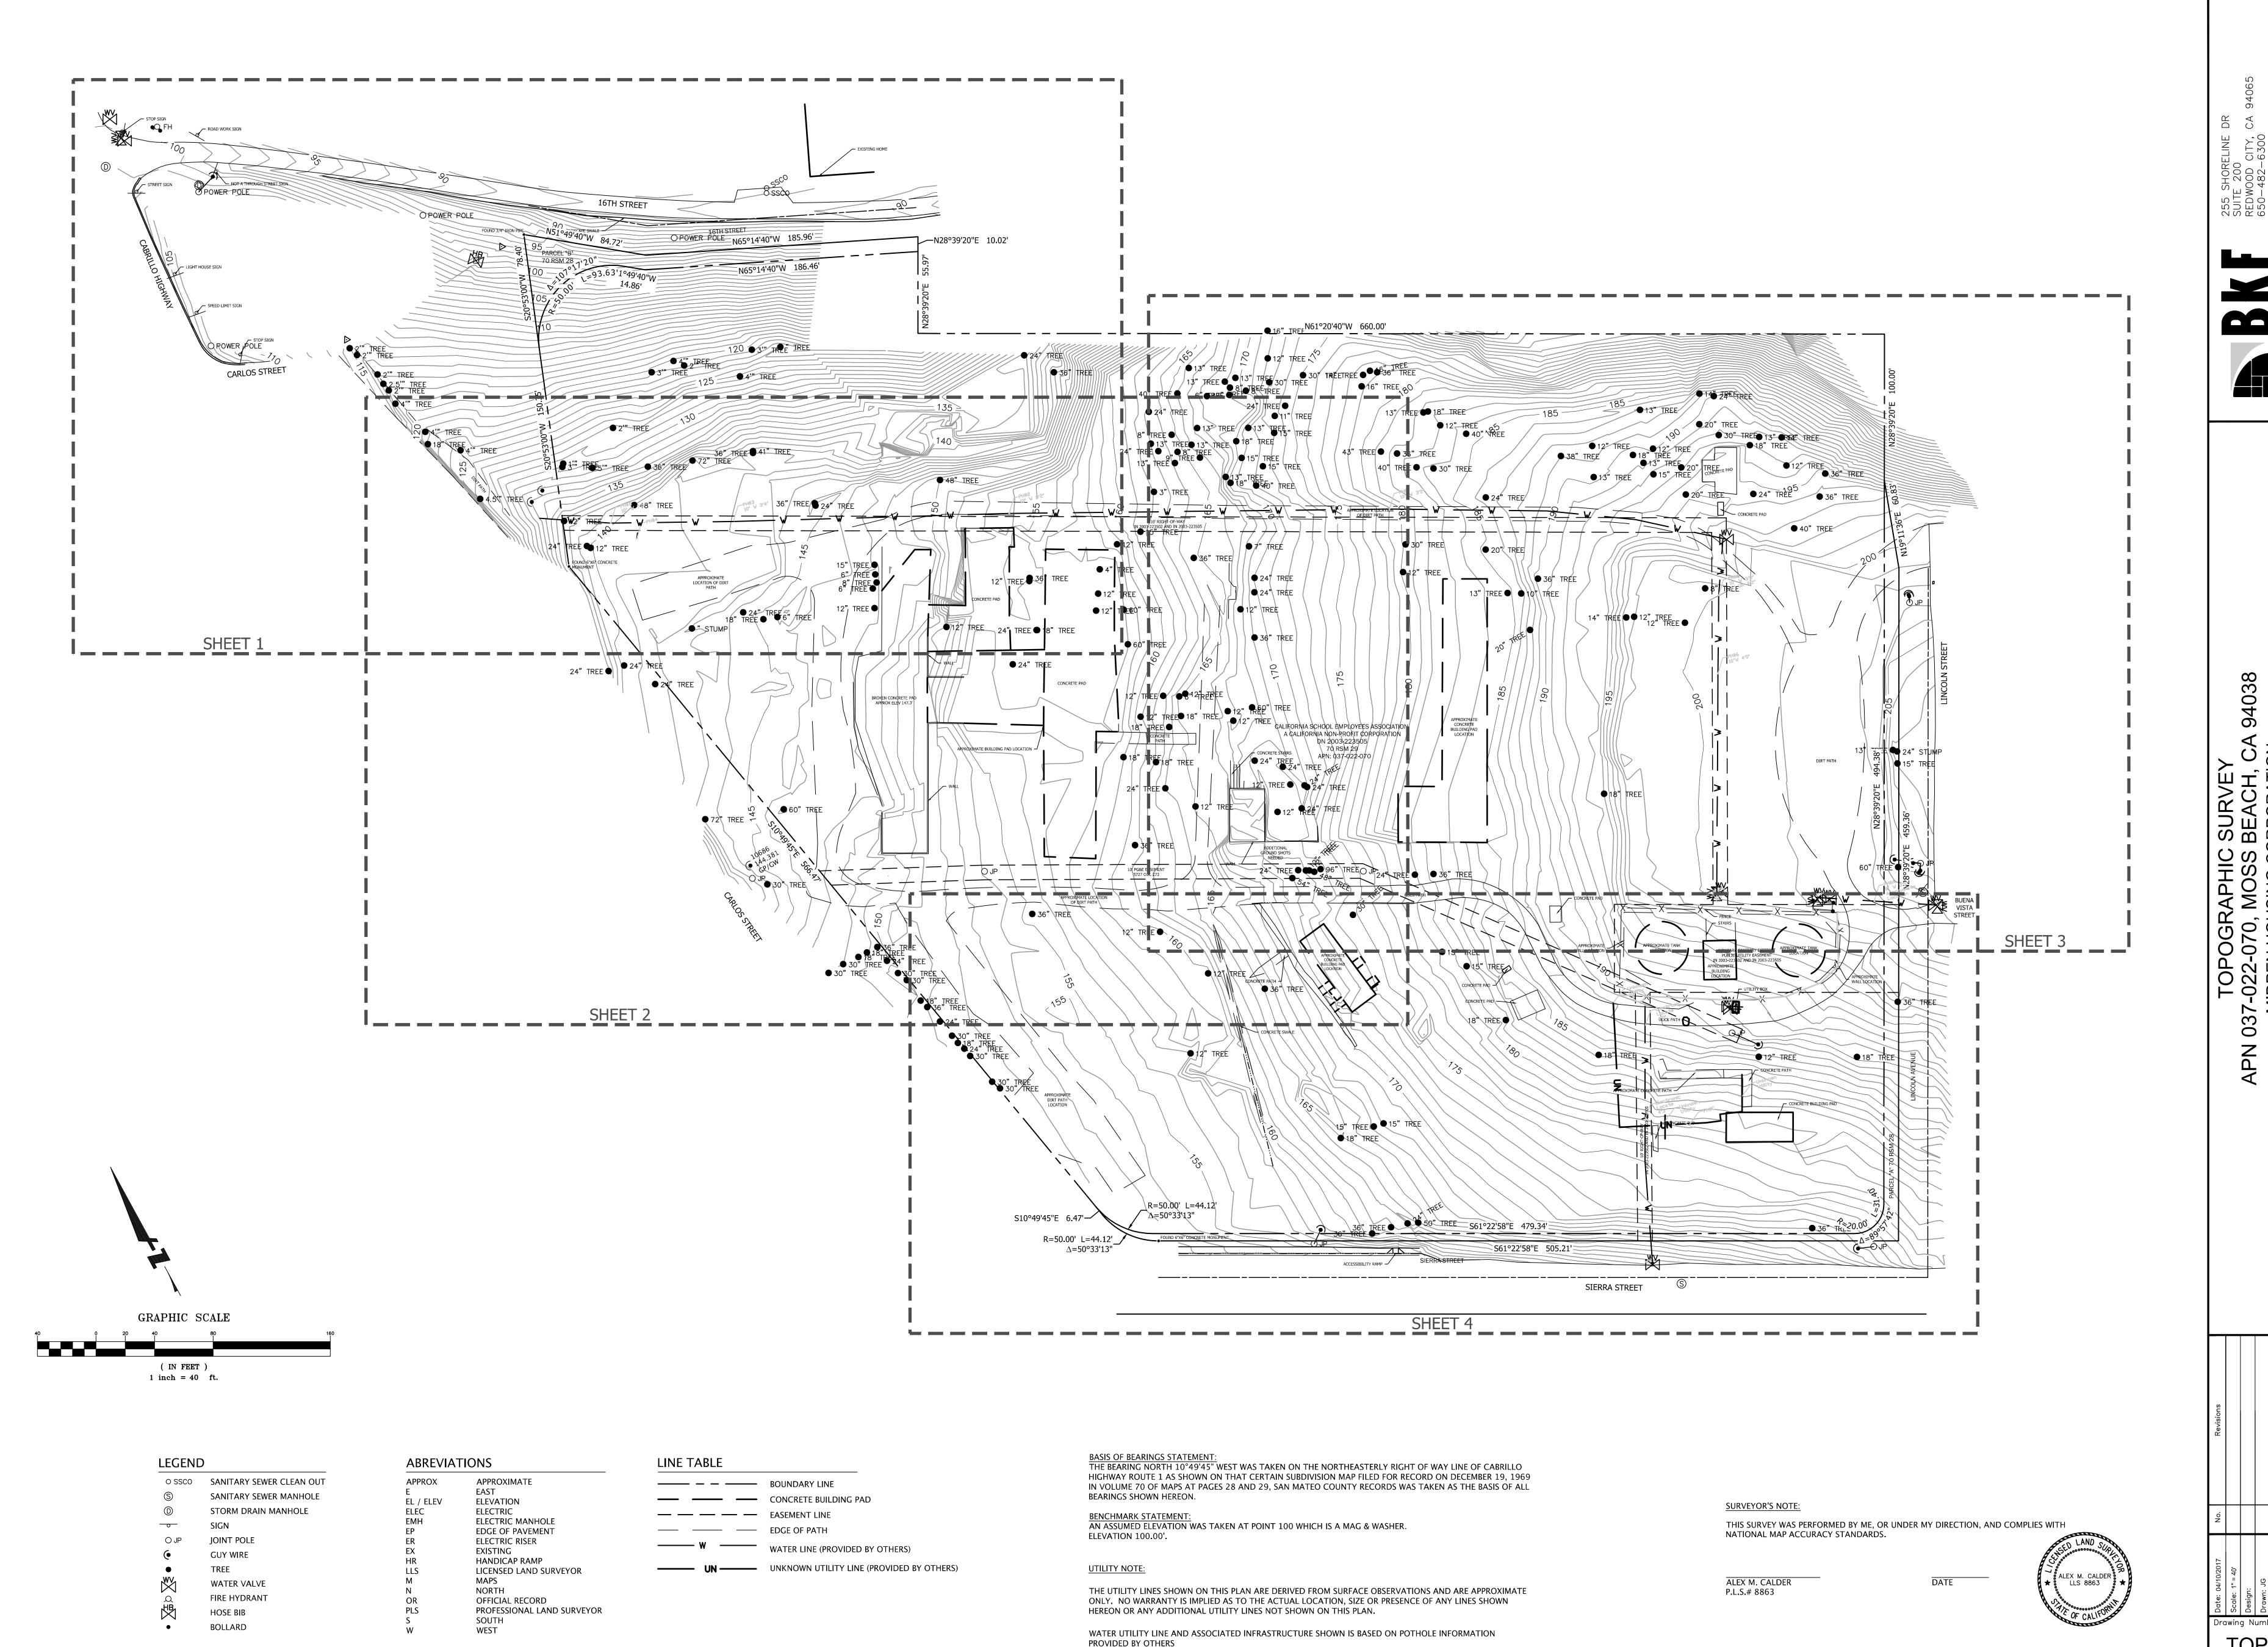

PROVIDED BY OTHERS

Drawing Number:

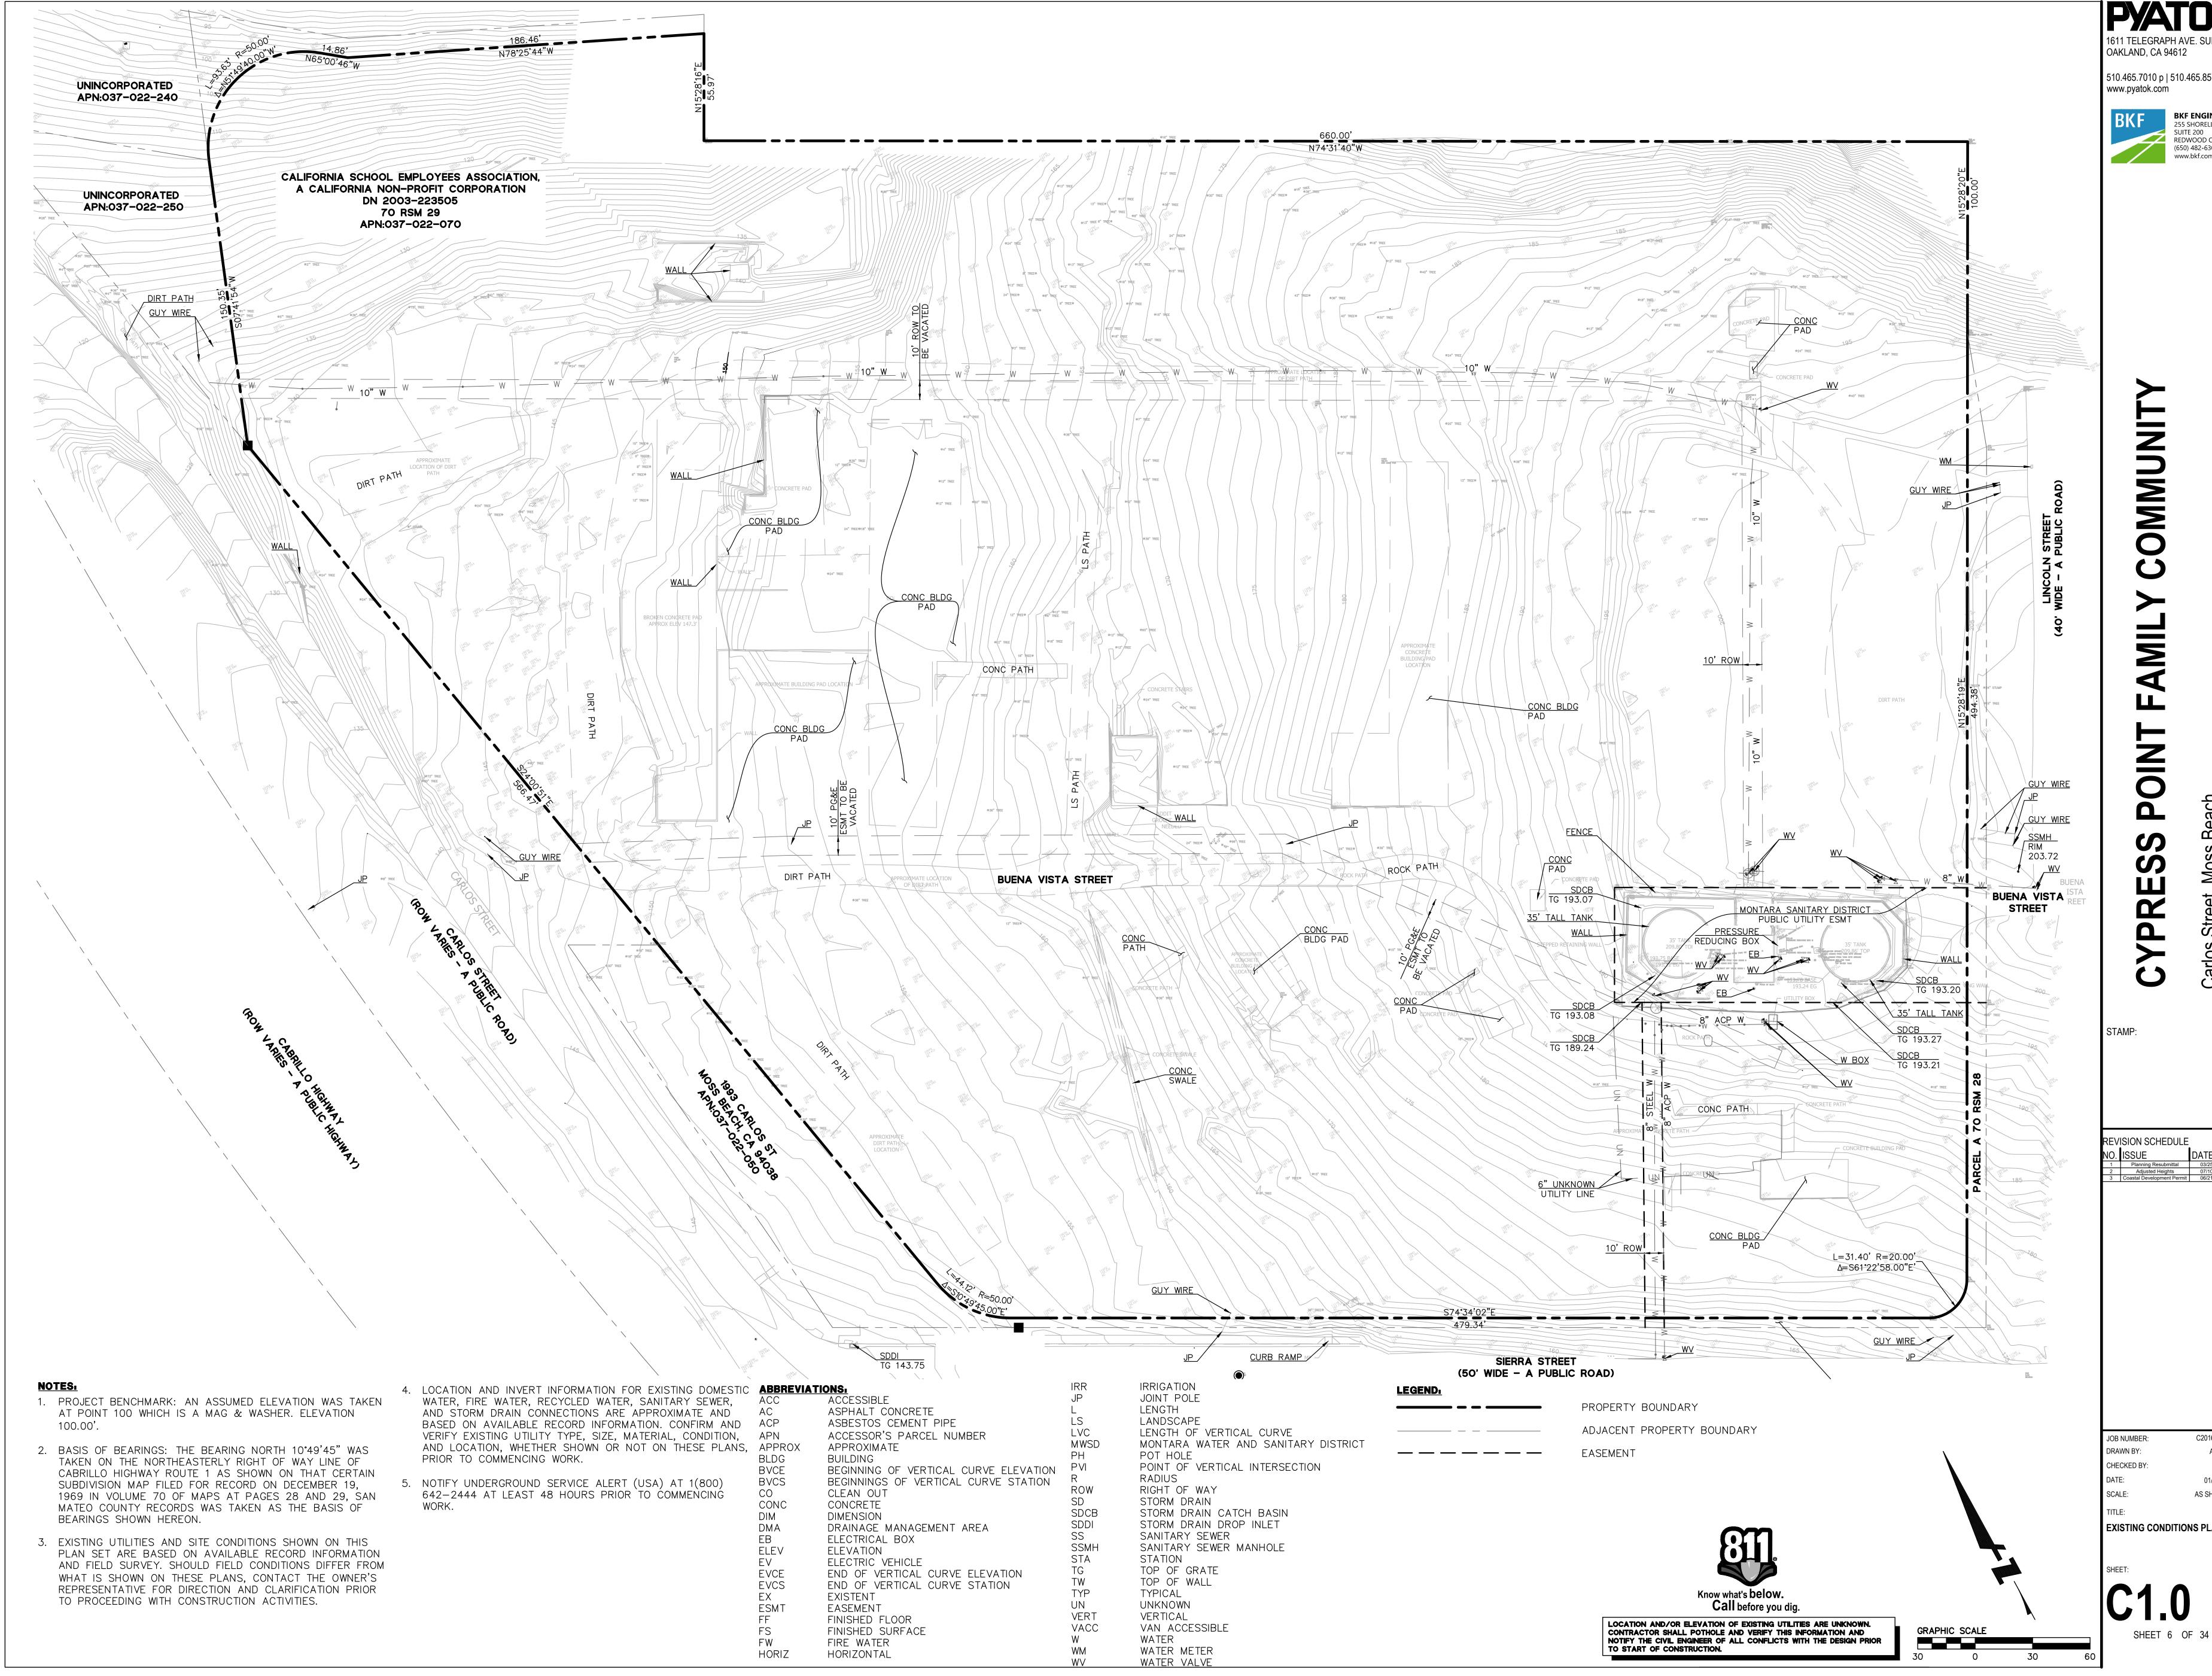


OAKLAND, CA 94612

510.465.7010 p | 510.465.8575 f



C20160074 AC/CF CHECKED BY:

AS SHOWN **EXISTING CONDITIONS PLAN**

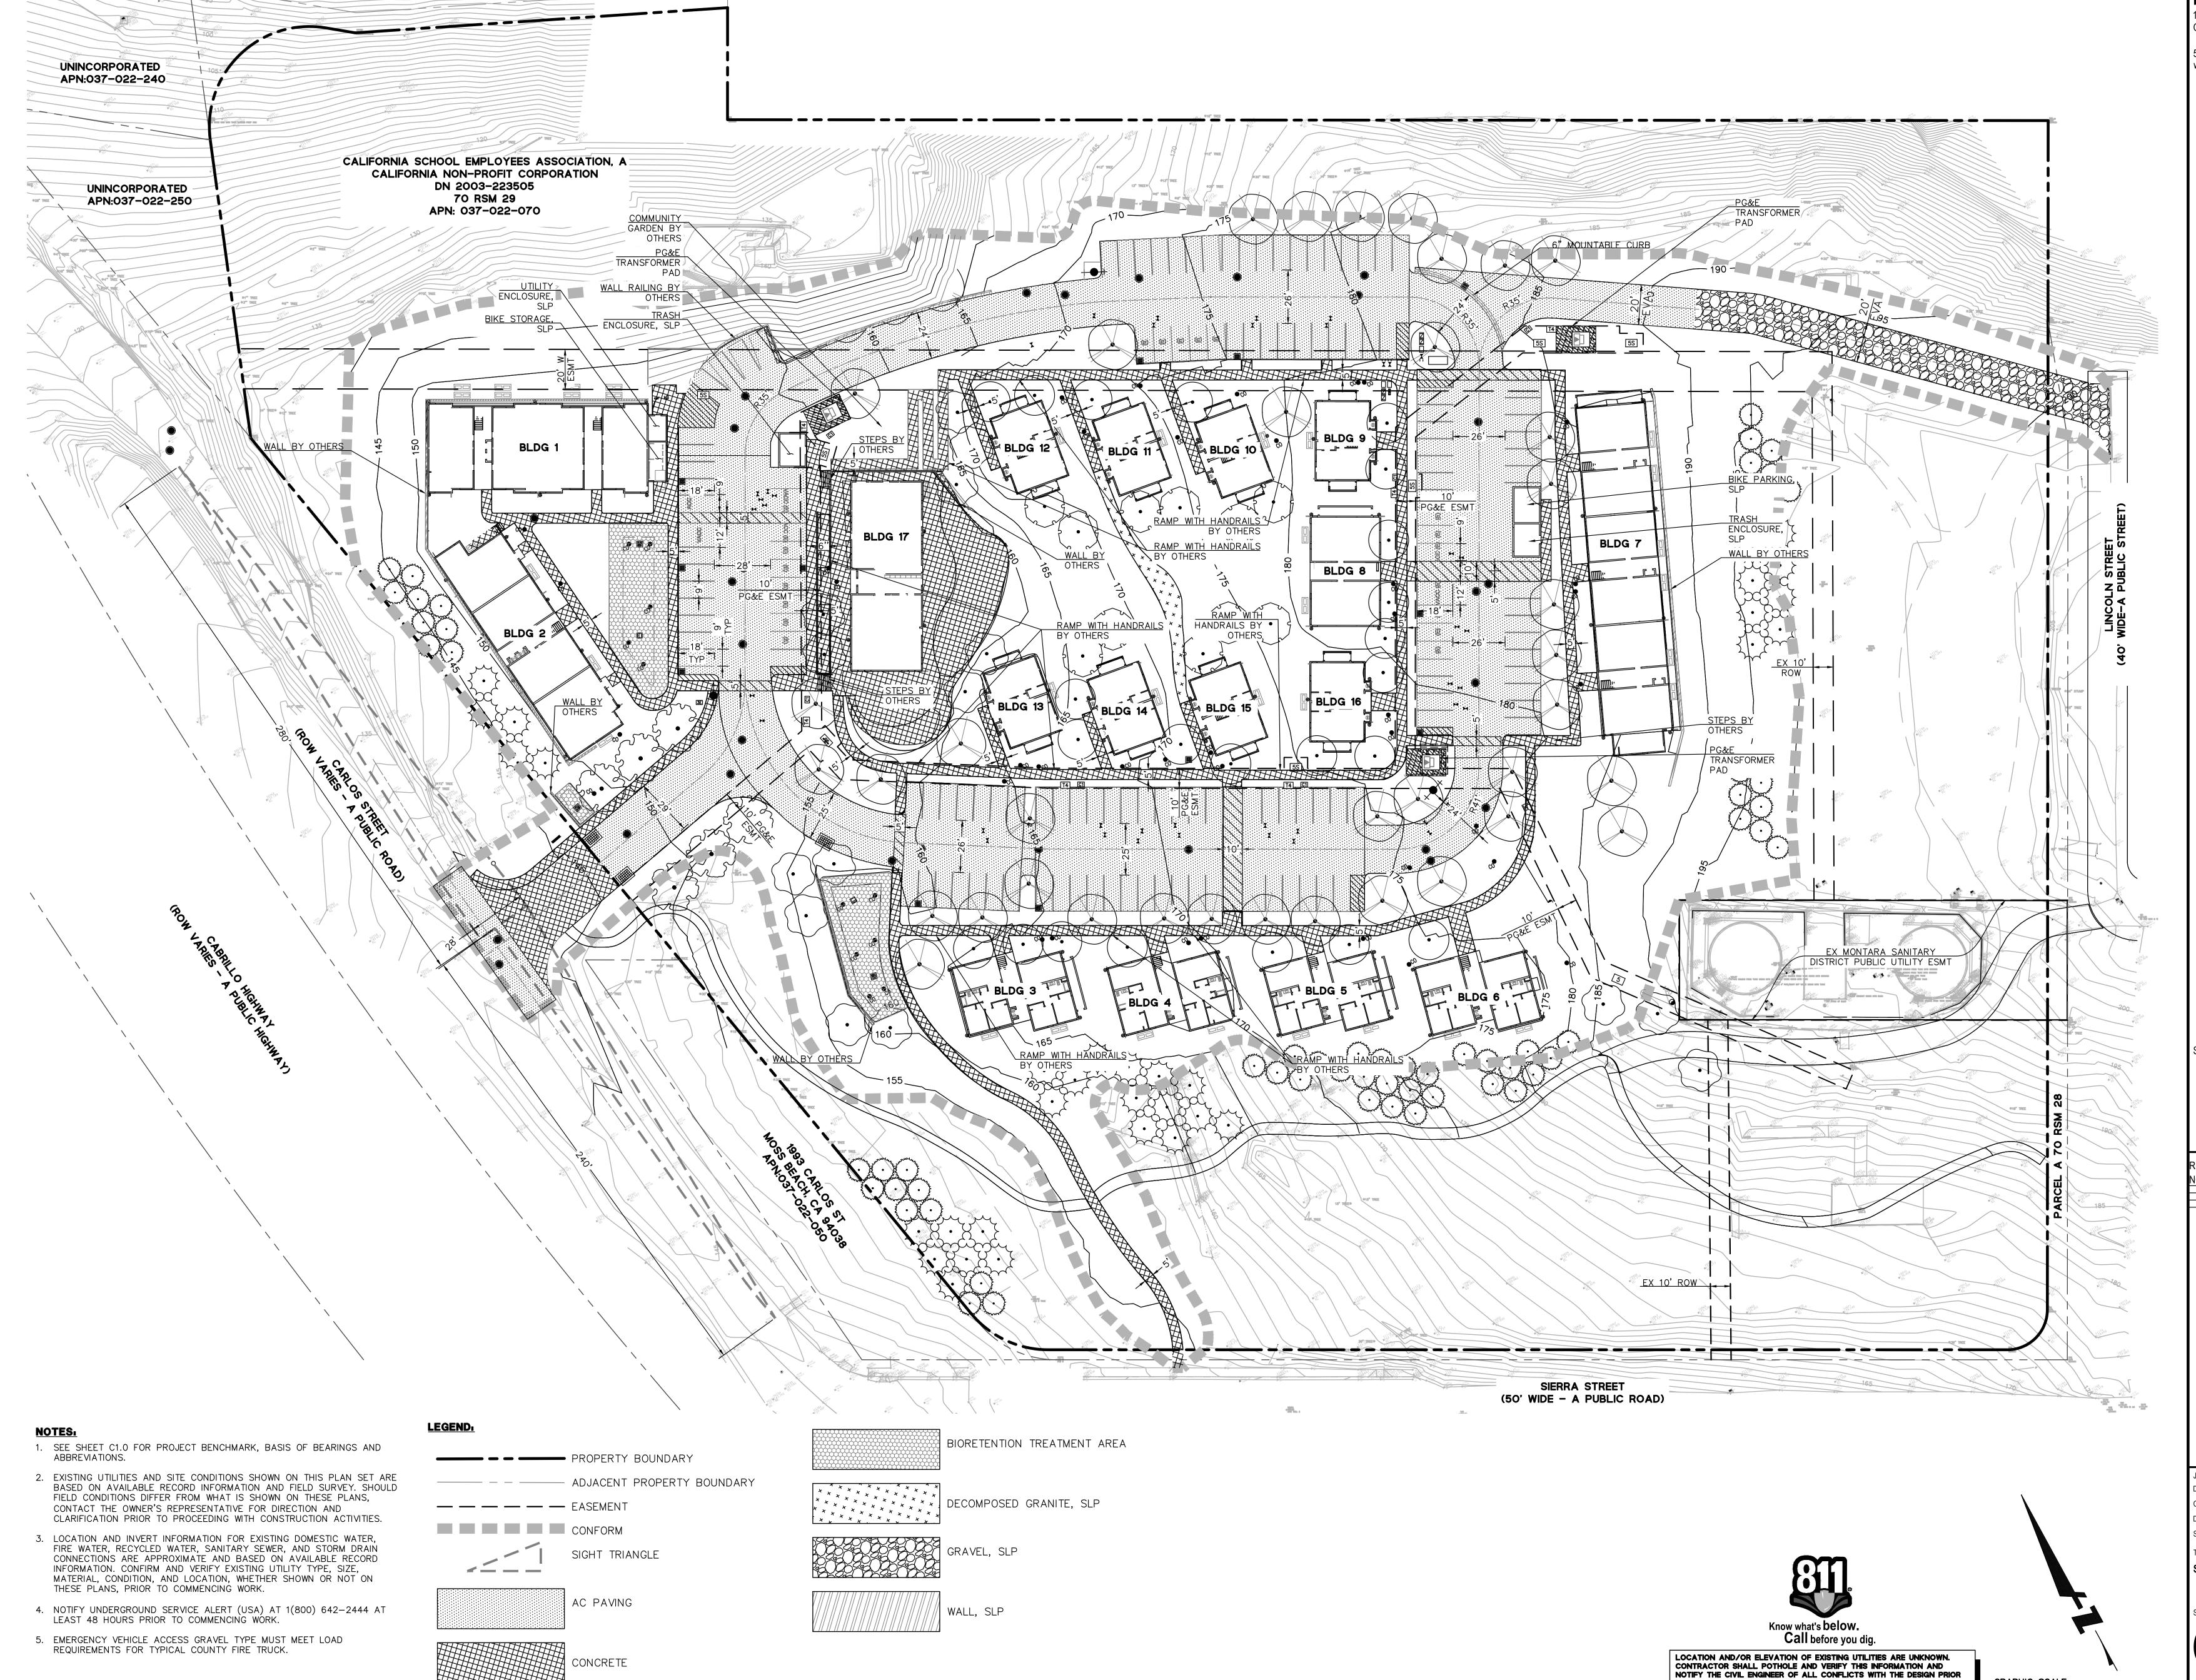

PYATOK

1611 TELEGRAPH AVE. SUITE 200
OAKLAND, CA 94612

510.465.7010 p | 510.465.8575 f www.pyatok.com



POINT FAMILY COMMUNI

CTAM

/ISION SCHEDULE
ISSUE DATE
Planning Resubmittal 03/25/19
Adjusted Heights 07/10/20

JOB NUMBER: C20160074
DRAWN BY: AC/CF
CHECKED BY: JD
DATE: 01/24/24
SCALE: AS SHOWN

SCALE:
TITLE:
SITE PLAN

C2.0

GRAPHIC SCALE

TO START OF CONSTRUCTION.

OAKLAND, CA 94612


510.465.7010 p | 510.465.8575 f www.pyatok.com

255 SHORELINE DRIVE SUITE 200 REDWOOD CITY, CA 94065 www.bkf.com

C20160074 AC/CF 01/24/24 AS SHOWN

FIRE ACCESS PLAN

SHEET ---- OF 34

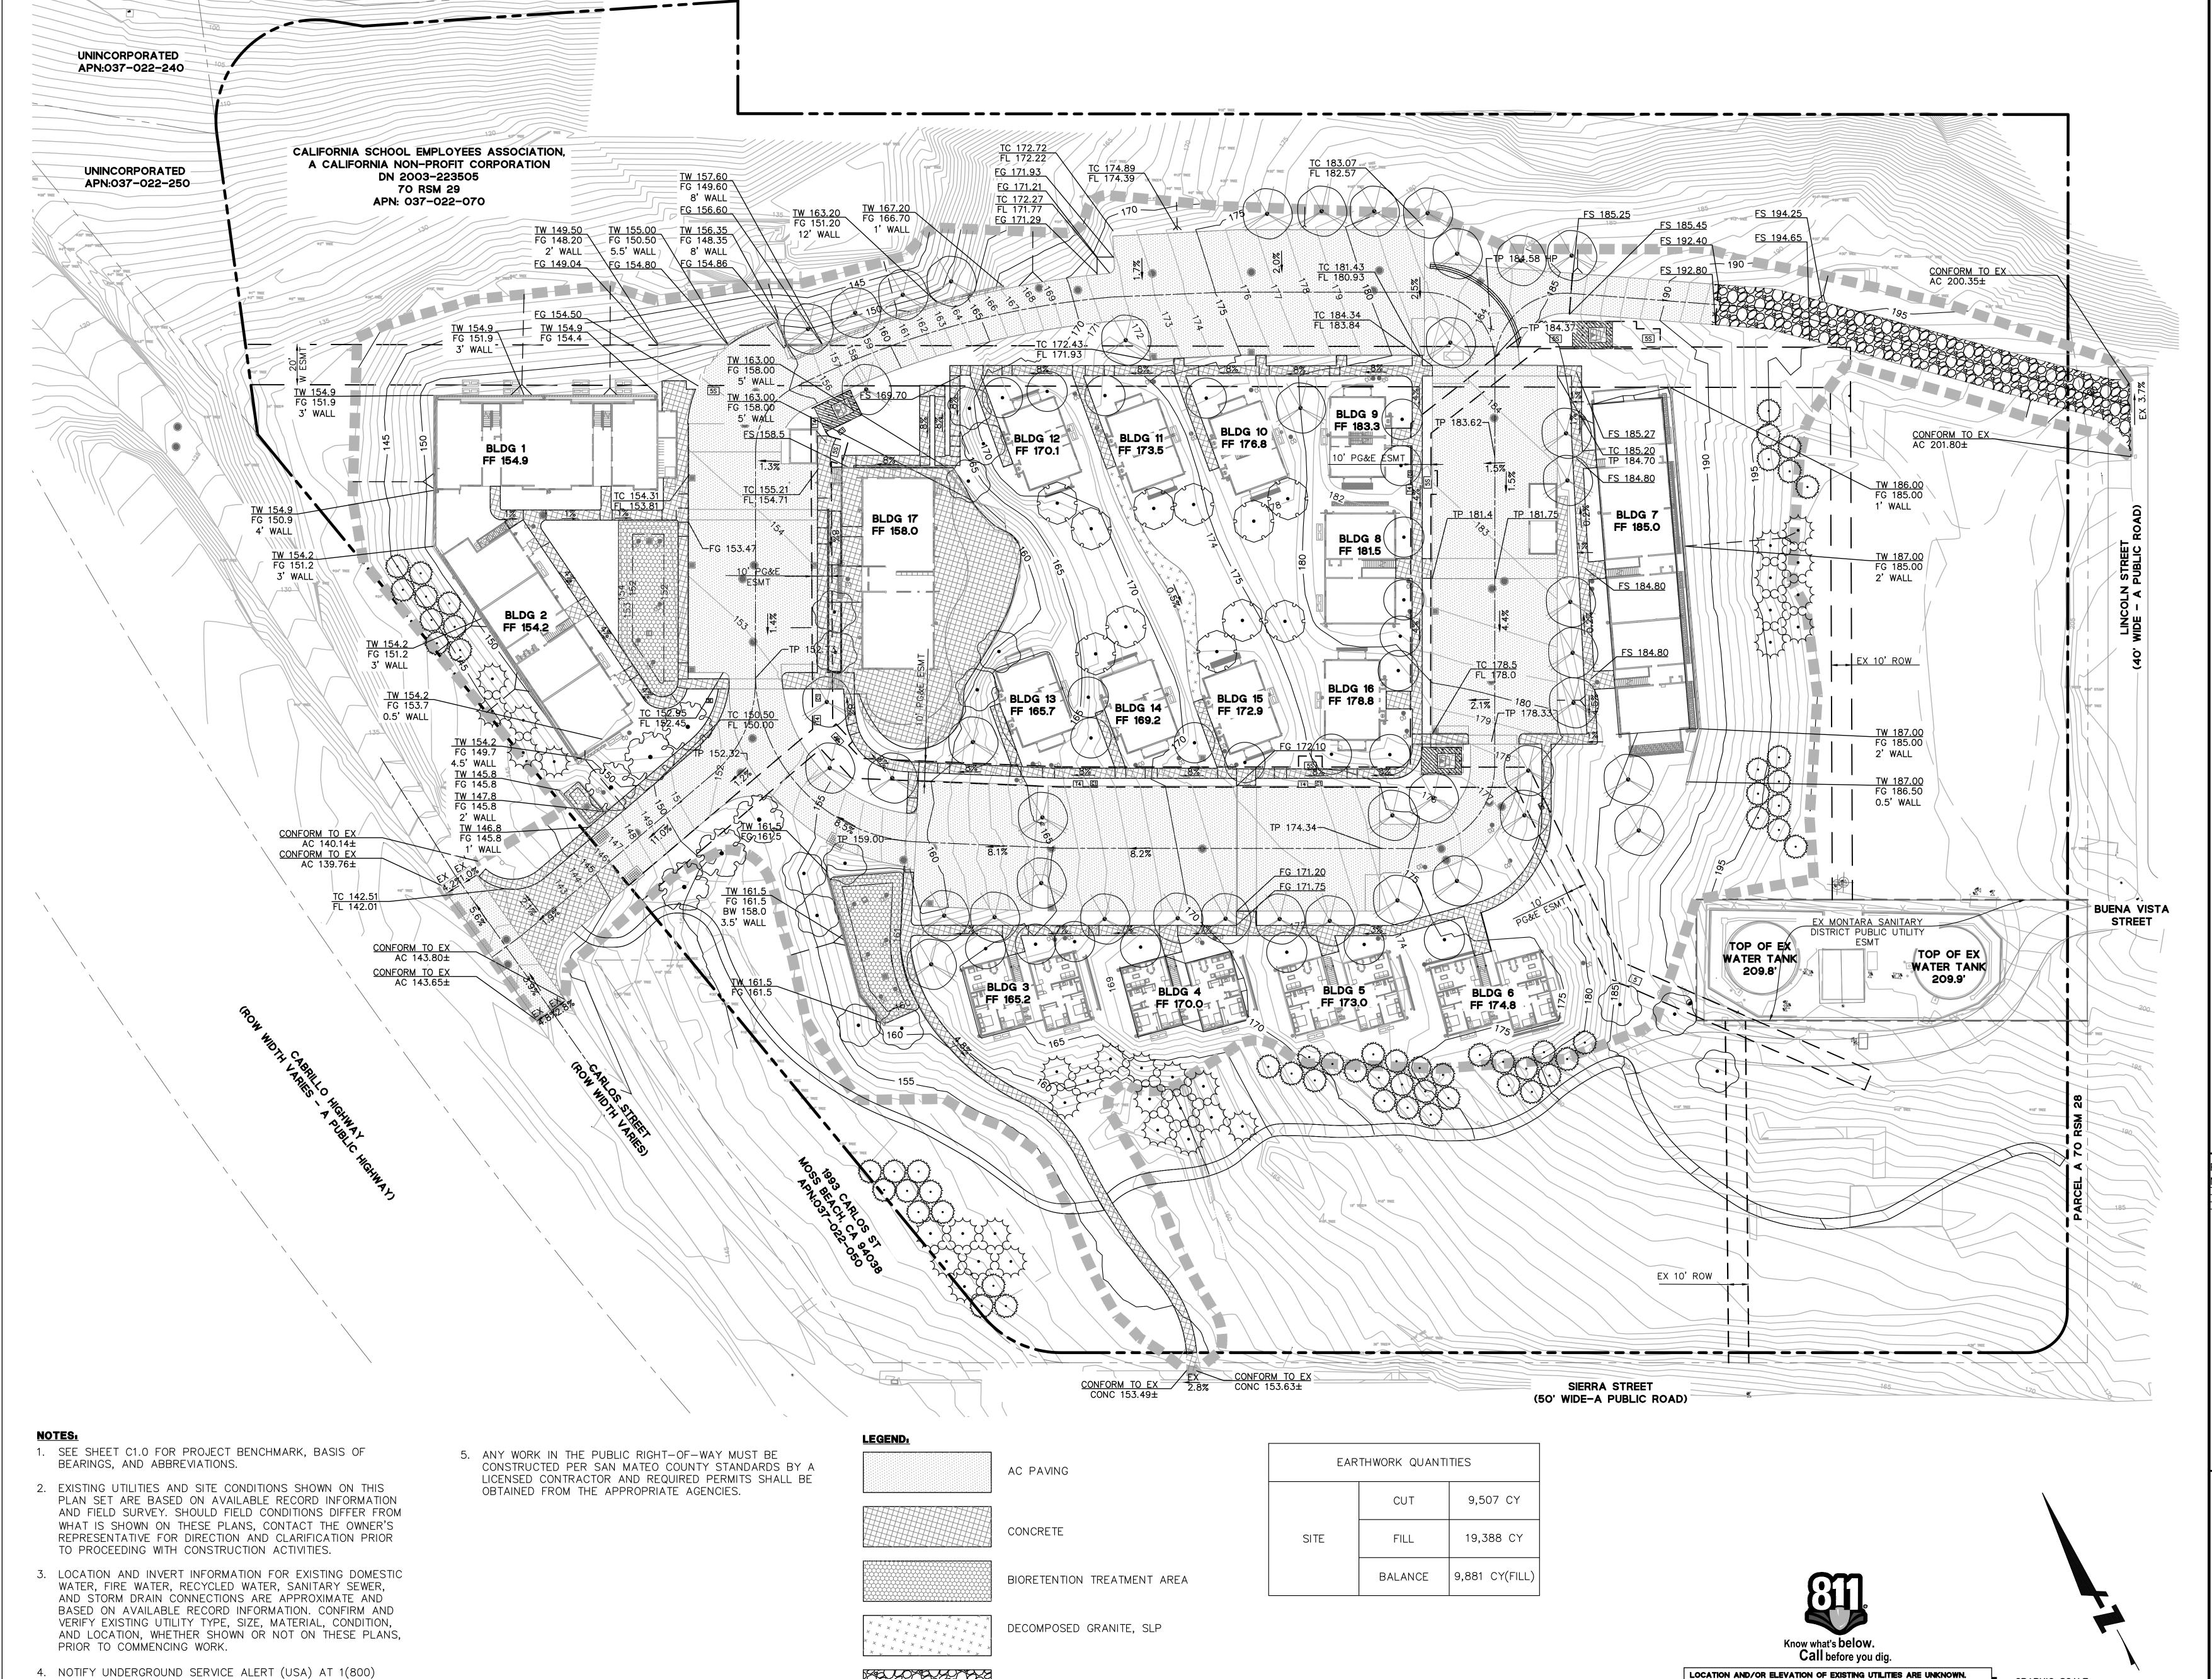

GRAVEL, SLP

642-2444 AT LEAST 48 HOURS PRIOR TO COMMENCING

PYATOK 1611 TELEGRAPH AVE. SUITE 200 OAKLAND, CA 94612

> 510.465.7010 p | 510.465.8575 f www.pyatok.com

> > BKF ENGINEERS
> > 255 SHORELINE DRIVE
> > SUITE 200
> > REDWOOD CITY, CA 94065
> > (650) 482-6300
> > www.bkf.com

NT FAMILY COMMUNIT

QTAMI

ISION SCHEDULE

JOB NUMBER: C20160074
DRAWN BY: AC/CF
CHECKED BY: JD
DATE: 01/24/24

AS SHOWN

TITLE:
SITE GRADING PLAN

C3.0

GRAPHIC SCALE

30

CONTRACTOR SHALL POTHOLE AND VERIFY THIS INFORMATION AND NOTIFY THE CIVIL ENGINEER OF ALL CONFLICTS WITH THE DESIGN PRIOR TO START OF CONSTRUCTION.

OAKLAND, CA 94612

510.465.7010 p | 510.465.8575 f

BKF ENGINEERS
255 SHORELINE DRIVE
SUITE 200
REDWOOD CITY, CA 94065 (650) 482-6300 www.bkf.com

JOB NUMBER: C20160074 AC/CF

01/24/24

AS SHOWN

PROPOSED UTILTIES

SHEET 9 OF 34

OAKLAND, CA 94612

510.465.7010 p | 510.465.8575 f


BKF ENGINEERS
255 SHORELINE DRIVE
SUITE 200
REDWOOD CITY, CA 94065 (650) 482-6300 www.bkf.com

JOB NUMBER: C20160074

DRAWN BY: AC/CF CHECKED BY: 01/24/24 AS SHOWN

PROPOSED UTILITIES

SHEET ---- OF 34

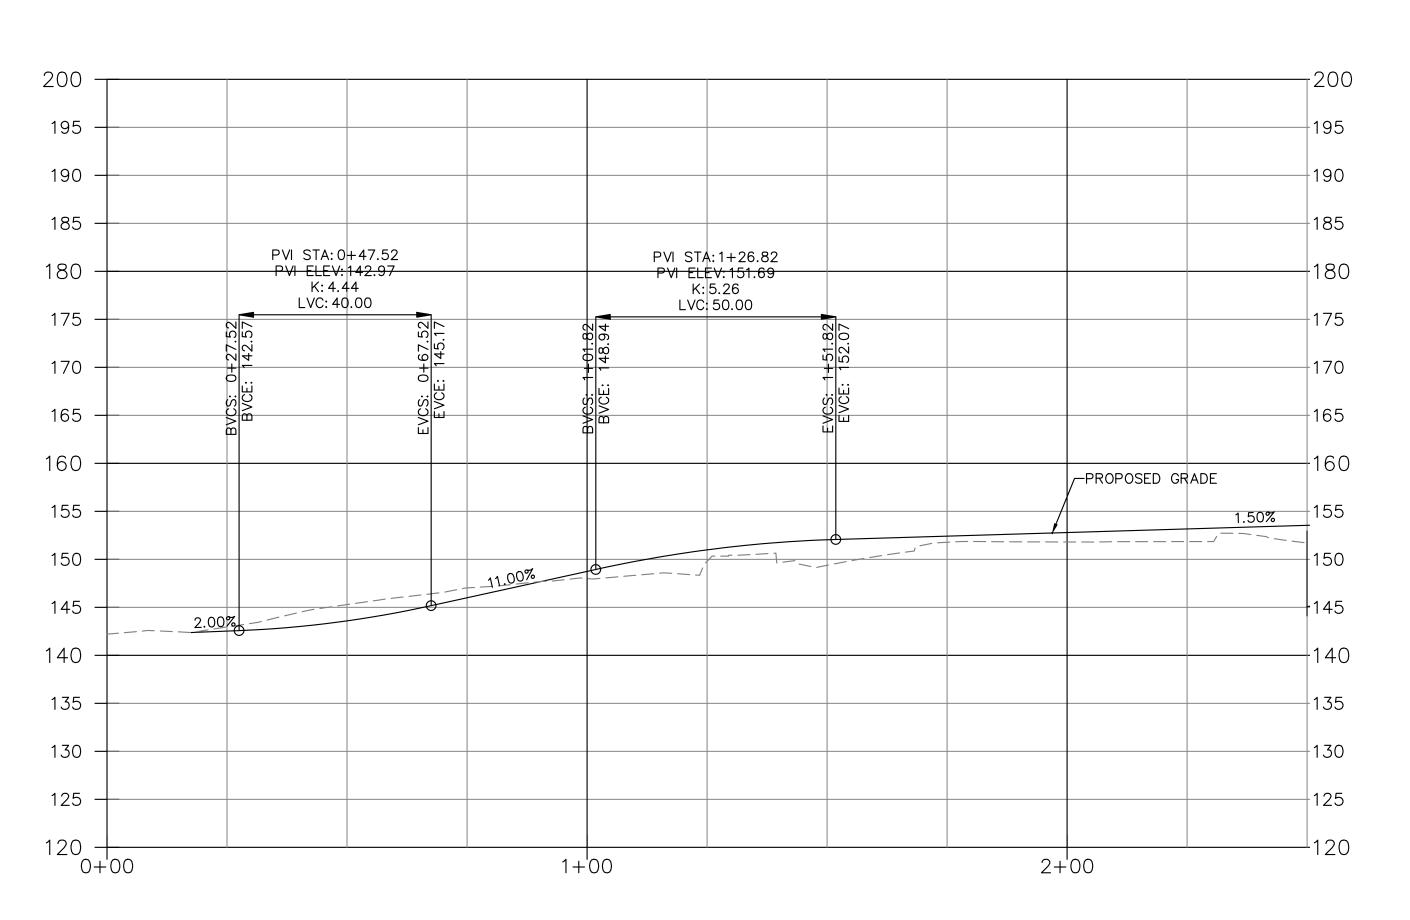

CYPRESS POINT DRIVE STA: 0+00 TO STA: 6+75

SCALE: 1" = 20' HORIZ.
1" = 10' VERT.


1611 TELEGRAPH AVE. SUITE 200 OAKLAND, CA 94612

510.465.7010 p | 510.465.8575 f www.pyatok.com



JOB NUMBER: DRAWN BY: AC/CF CHECKED BY: 01/24/24 AS SHOWN

DRIVEWAY PLAN AND PROFILE

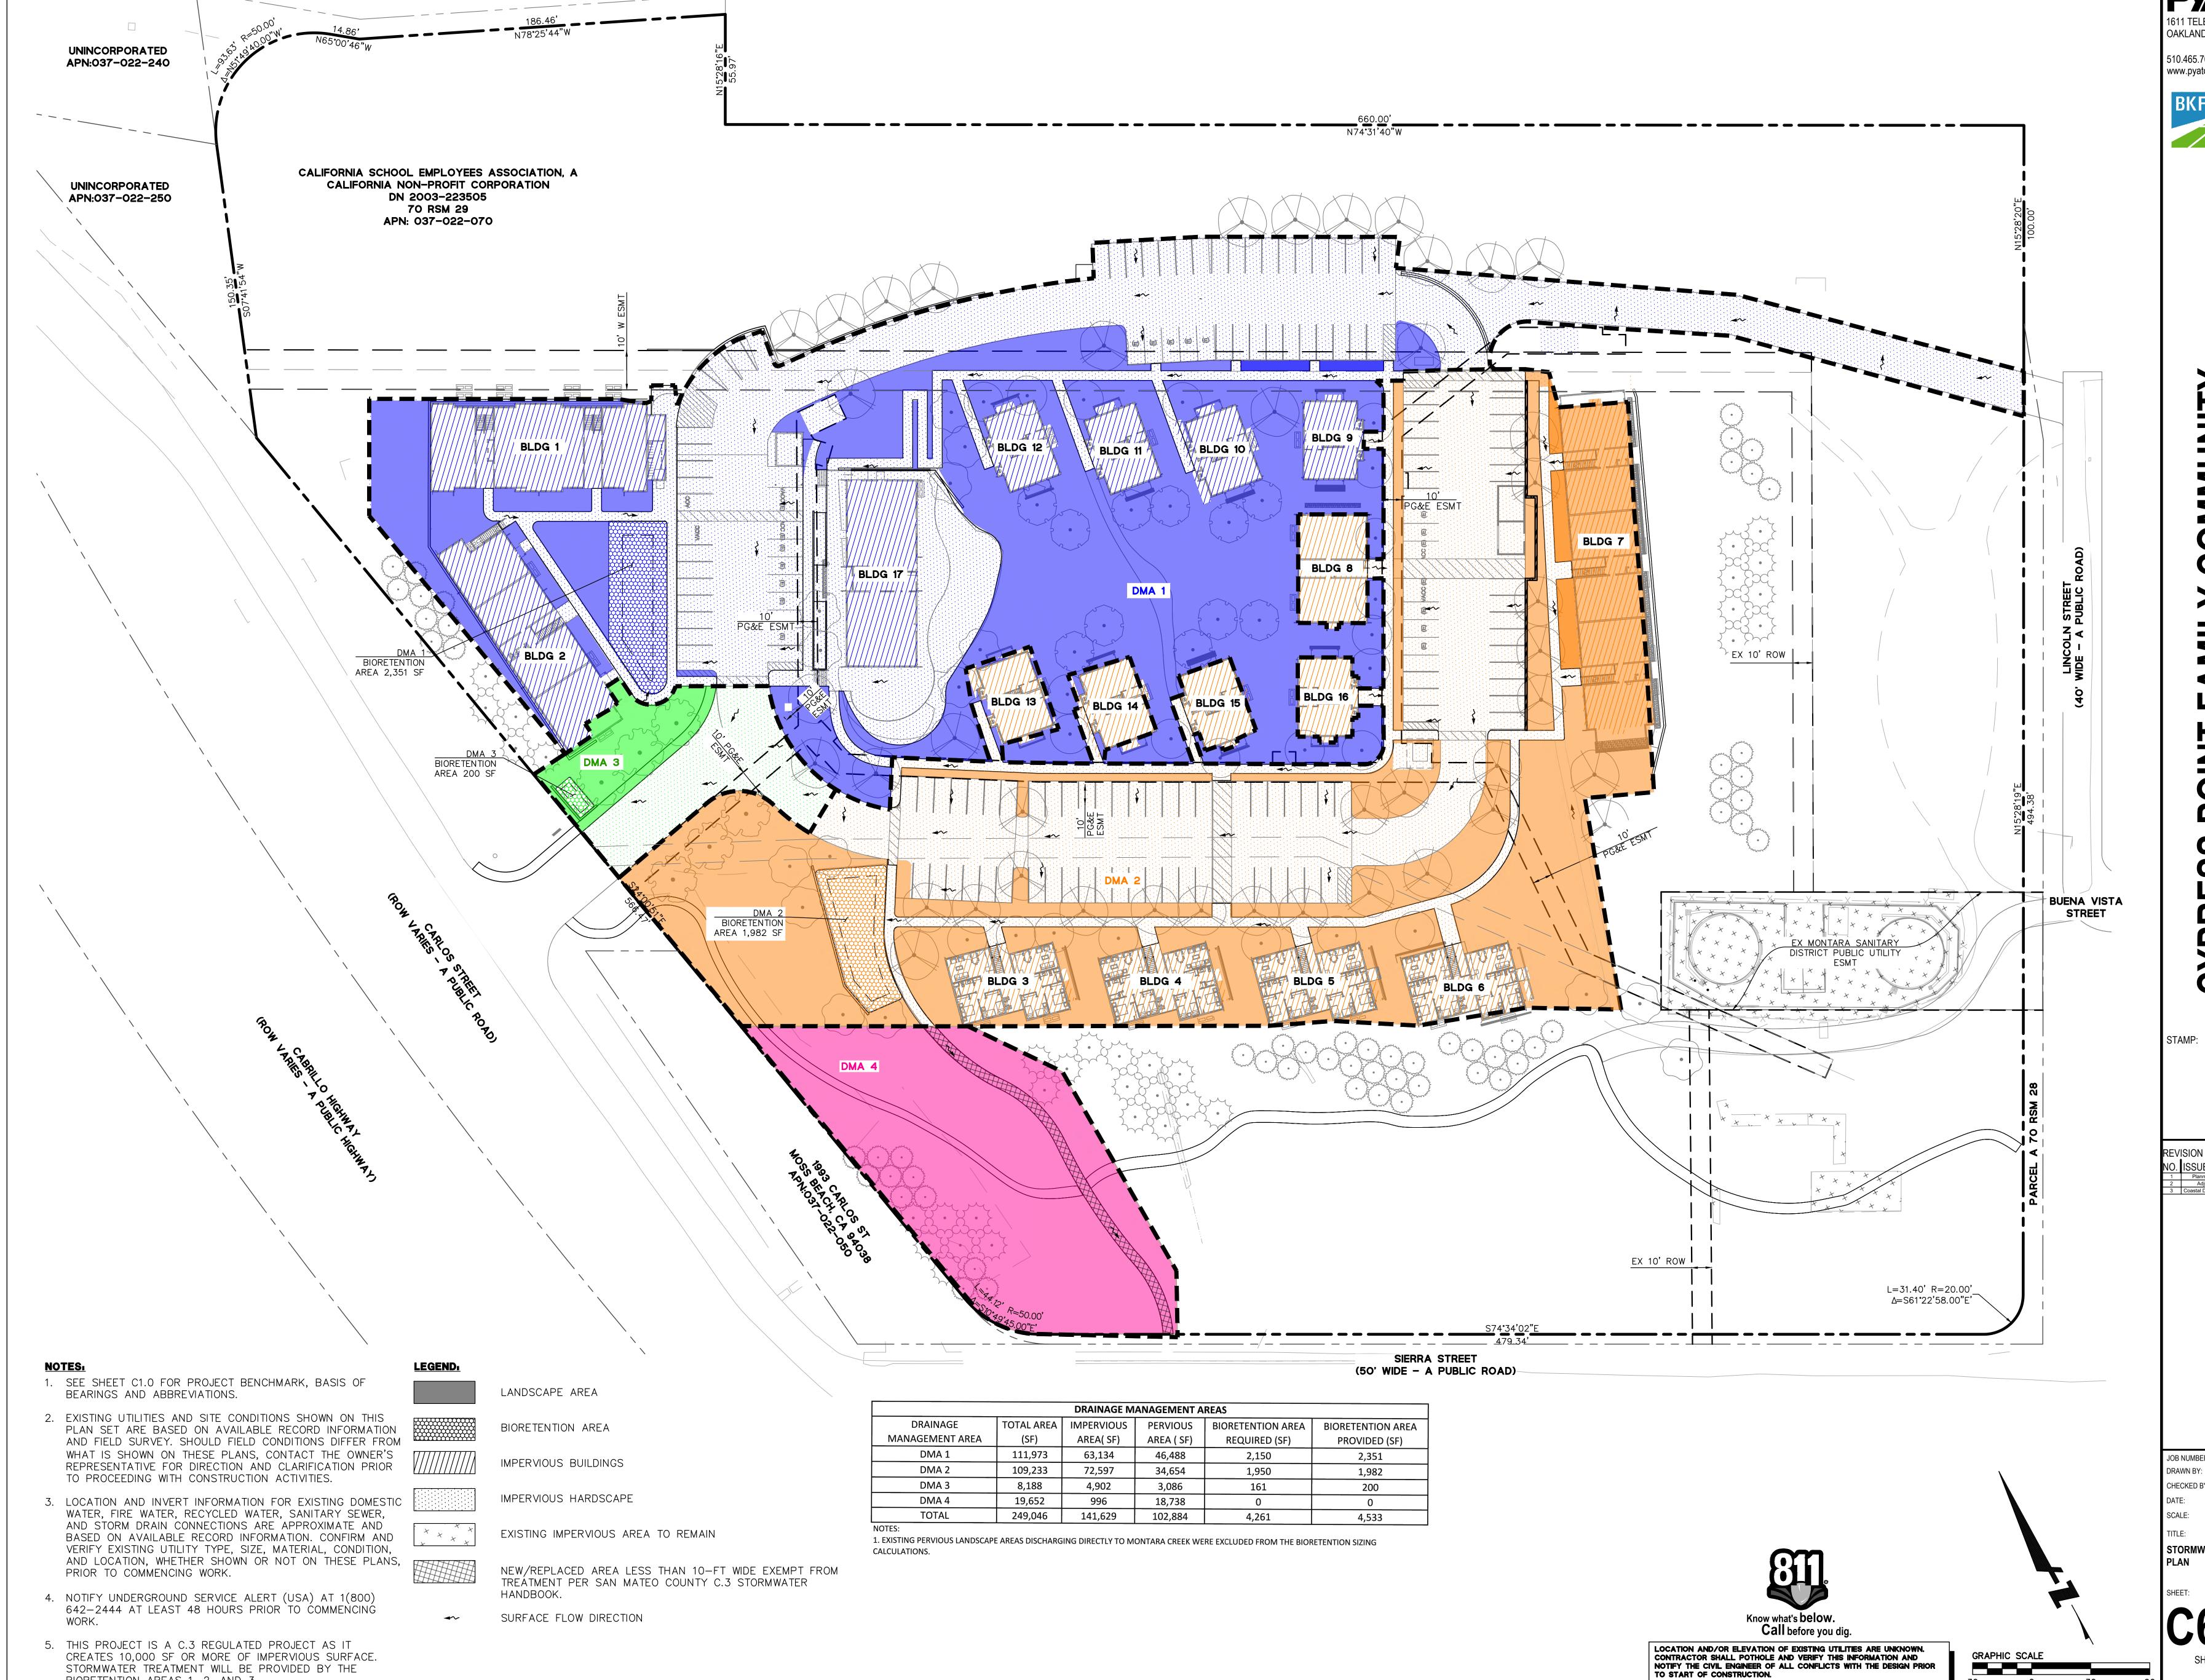

STORMWATER TREATMENT WILL BE PROVIDED BY THE

BIORETENTION AREAS 1, 2, AND 3.

OAKLAND, CA 94612

510.465.7010 p | 510.465.8575 f www.pyatok.com

> BKF ENGINEERS
> 255 SHORELINE DRIVE
> SUITE 200
> REDWOOD CITY, CA 94065 (650) 482-6300 www.bkf.com

JOB NUMBER: C20160074 AC/CF CHECKED BY: 01/24/24

AS SHOWN

STORMWATER CONTROL

30


510.465.7010 p | 510.465.8575 f

OAKLAND, CA 94612

www.pyatok.com

CONSTRUCTION DETAILS


SHEET: 12 OF 34

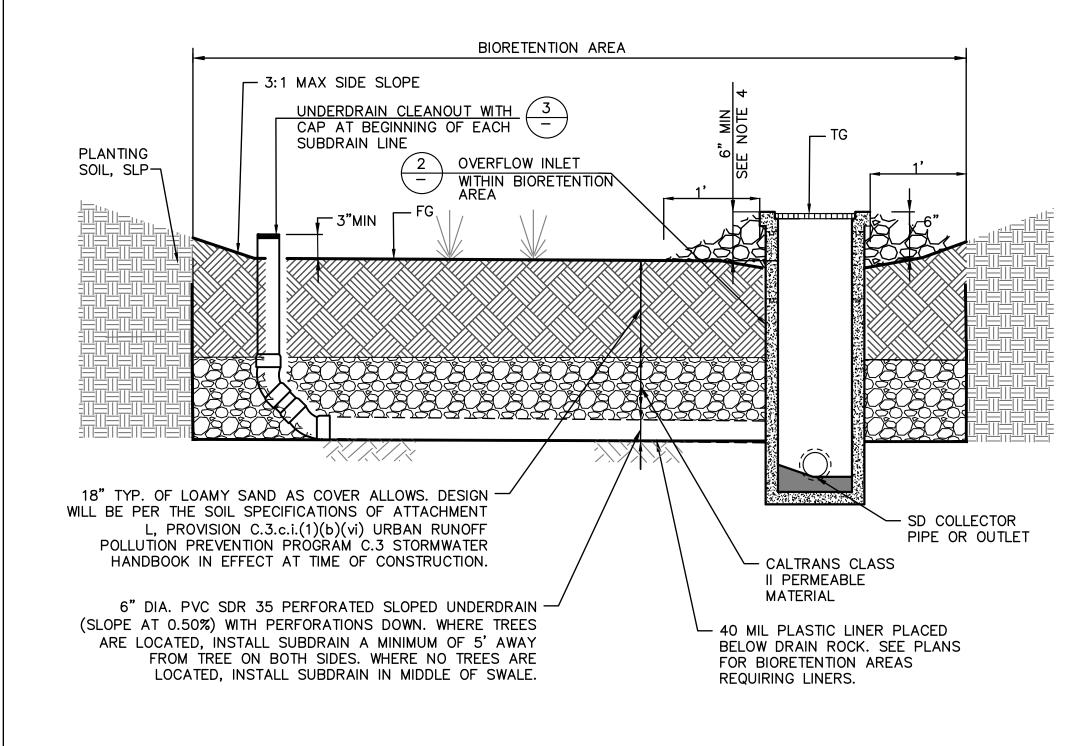

NOTES:


- 1. SEE GRADING PLANS FOR FINISH GRADE OF BIORETENTION AREAS.
- 2. SEE LANDSCAPE PLANS & SPECIFICATIONS FOR PLANTING MATERIALS WITHIN BIORETENTION AREAS.
- 3. ALL BIORETENTION SOILS USED, SHALL BE PER ATTACHMENT L PROVISION C.3.c.i.(1)(b)(vi) OF THE SANTA CLARA VALLEY URBAN RUNOFF POLLUTION PREVENTION PROGRAM C.3 HANDBOOK IN EFFECT AT TIME OF CONSTRUCTION.
- 4. PLACE COBBLE FLUSH WITH CHANNEL SURFACE AROUND ALL STRUCTURES WITHIN BIORETENTION AREA (DRAINAGE BUBBLERS, OVERFLOW DRAINS, SIGNS, LIGHT POSTS, IRRIGATION BOXES, ETC.), EXTENDING 12" TYPICAL FROM EDGE OF STRUCTURE. SEE LANDSCAPE PLANS FOR COBBLE SIZE AND COLOR.



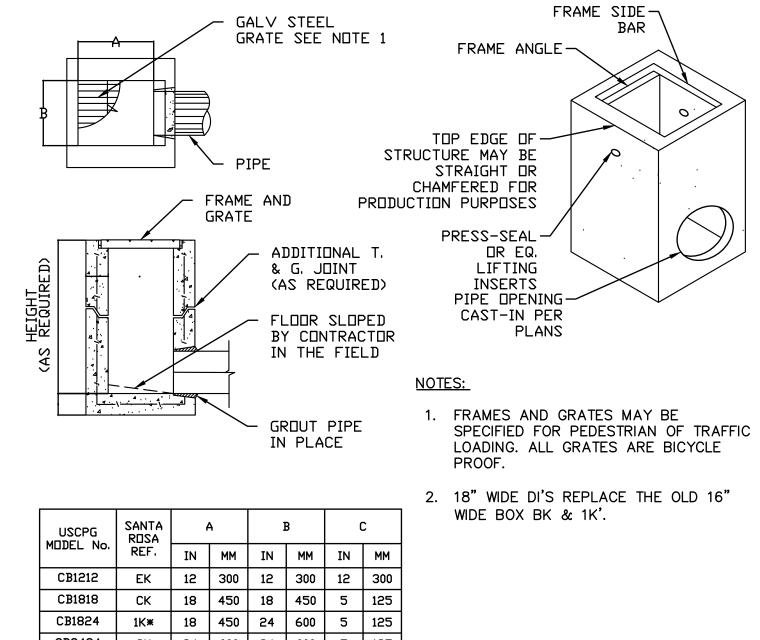

USCPG	SANTA ROSA	•	4	1	В	(2	\
MDDEL No.	REF.	IN	ММ	IN	ММ	IN	ММ	
CB1212	EK	12	300	12	300	12	300	
CB1818	СК	18	450	18	450	5	125	
CB1824	1K*	18	450	24	600	5	125	
CB2424	2K	24	600	24	600	5	125	
CB2430	3K	24	600	30	750	5	125	
CB3030	5K	30	750	30	750	6	150	
CB2436	1L	24	600	36	900	6	150	
CB3636	1M	36	900	36	900	6	150	
CB2448	3L	24	600	48	1200	6	150	
CB3648	3M	36	900	48	1200	6	150	
CB4848	1R	48	1200	48	1200	6	150	




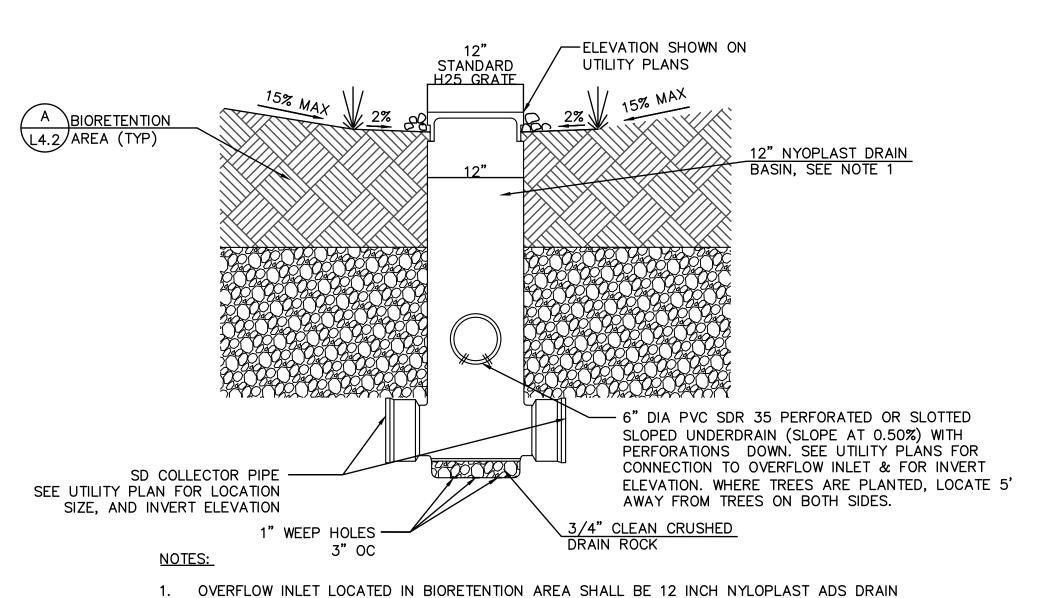

BASIN WITH AN 12 INCH CIRCULAR STANDARD H-25 GRATE. PAINT STRUCTURE BLACK.


OVERFLOW INLET WITH BIORETENTATION AREA

NTS

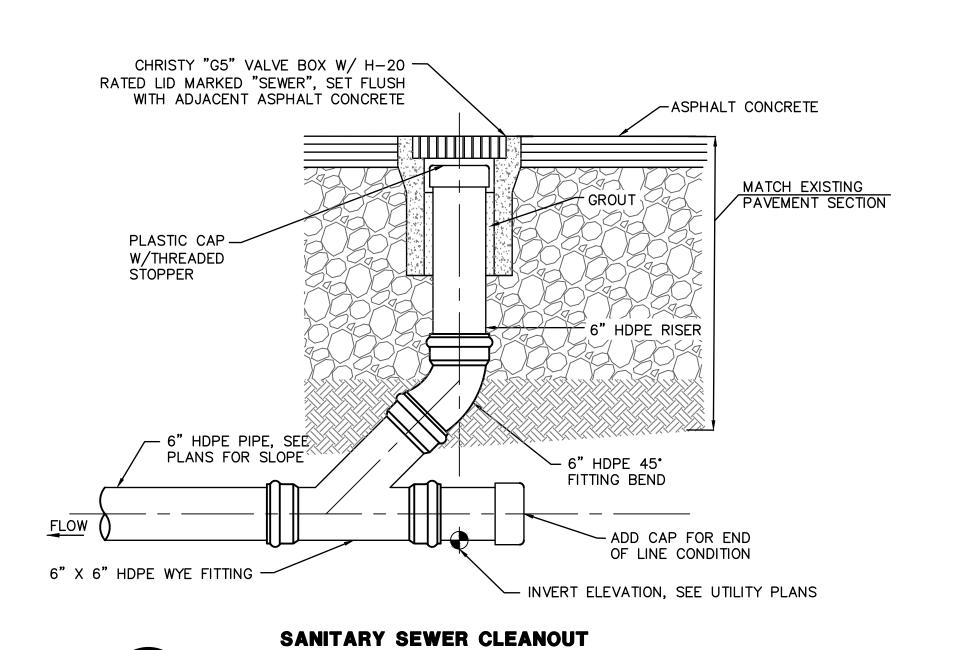

WITH TRAFFIC RATED LID

NTS

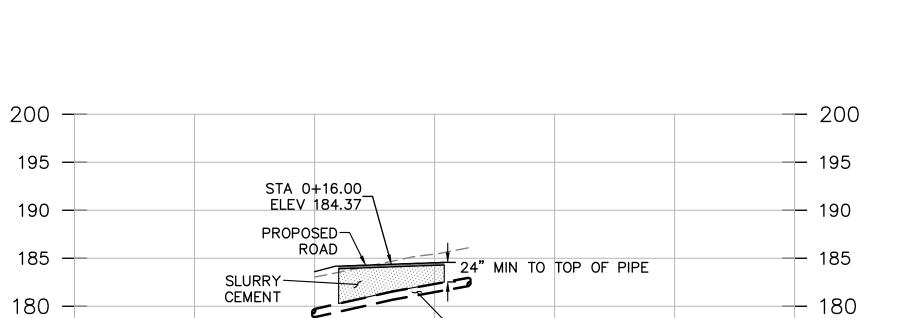


EX. 10" WATER LINE

- 175

+ 170 1+00


TO REMAIN

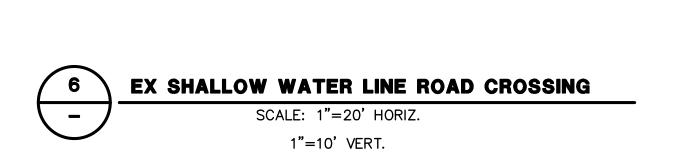

0+'00


175 —

170 | -0+50

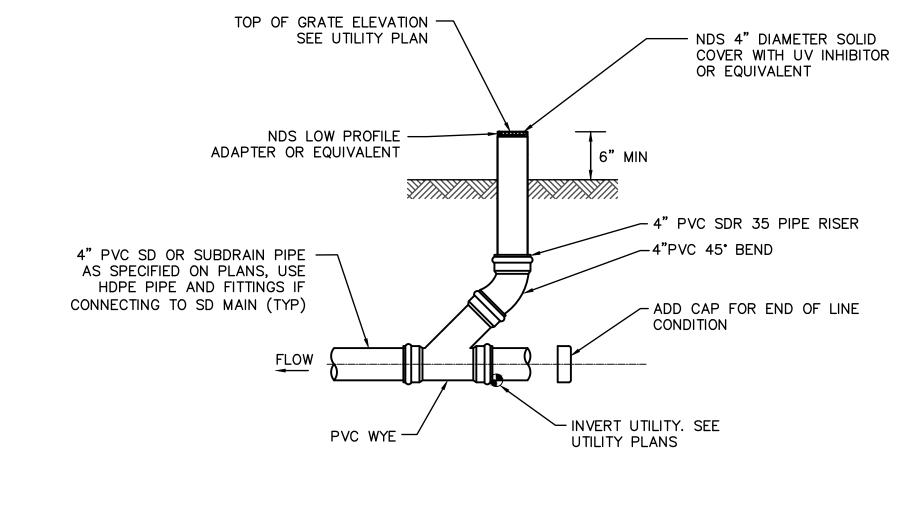

STORM DRAIN CLEANOUT

NTS

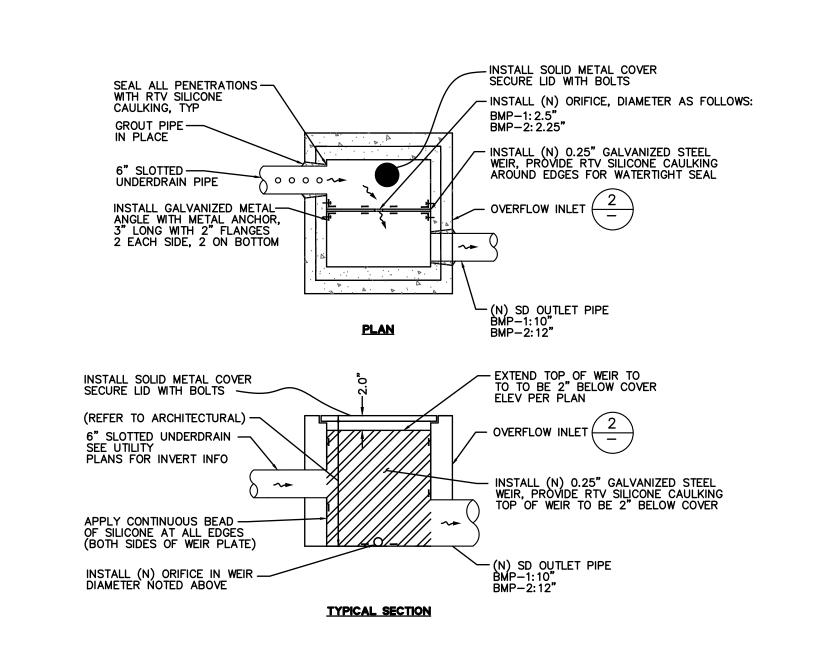

ORIFICE CONTROL STRUCTURE

PYATOK 1611 TELEGRAPH AVE. SUITE 200 OAKLAND, CA 94612

510.465.7010 p | 510.465.8575 f www.pyatok.com



SS POINT FAMILY COMMUNITY

STAMP:

/ISION SCHEDULE
ISSUE DATE
Planning Resubmittal 03/25/19

 ISSUE
 DATE

 1
 Planning Resubmittal
 03/25/19

 2
 Adjusted Heights
 07/10/20

 3
 Coastal Development Permit
 06/21/22

JOB NUMBER: C20160074
DRAWN BY: AC/CF
CHECKED BY: JD
DATE: 01/24/24
SCALE: AS SHOWN

TITLE:
EROSION CONTROL PLAN

SHEET:

OAKLAND, CA 94612

www.pyatok.com

ROUGH GRADE

EMBED FIBER ROLL

3"TO 4" INTO SOIL

PROVIDE 1' WIDE BY 6"


DEEP SEDIMENT TRAP TRENCH AROUND INLET 510.465.7010 p | 510.465.8575 f

01/24/24

AS SHOWN EROSION CONTROL DETAILS

SHEET 14 OF 34

GRAVEL FILLED BAGS STACKED TIGHTLY -BACK OF CURB LIP OF GUTTER STREET SLOPE (RUNOFF DIRECTION) STREET SLOPE (RUNOFF DIRECTION) **PLAN VIEW**

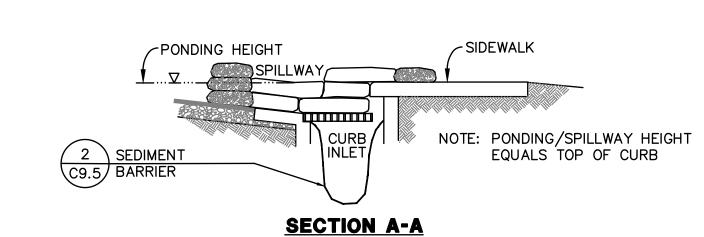

- 1. PLACE CURB TYPE SEDIMENT BARRIERS ON GENTLY SLOPING STREETS, WHERE WATER CAN POND AND ALLOW
- 2. PERVIOUS BAGS OF EITHER BURLAP OR WOVEN GEOTEXTILE FABRIC, ARE FILLED WITH GRAVEL, LAYERED AND PACKED

CATCH BASIN INLET PROTECTION

SEDIMENT TO SEPARATE FROM RUNOFF.

3. LEAVE ONE BAG GAP IN THE TOP ROW TO PROVIDE A SPILLWAY OVERFLOW. TOP OF SPILLWAY SHALL BE LOWER THAN TOP OF CURB.

4. INSPECT BARRIERS AND REMOVE SEDIMENT AFTER EACH STORM EVENT, SEDIMENT, AND GRAVEL MUST BE REMOVED FROM THE TRAVELED WAY IMMEDIATELY.

ENTRENCHMENT DETAIL

IN FLAT AREA

WOOD STAKE ~

4' SPACING

3/4"x3/4" MAX

FIBER ROLL —

RUNOFF WATER

WITH SEDIMENT

GRADE '

FIBER ROLL INSTALLATION REQUIRES THE PLACEMENT AND SECURE STAKING OF THE ROLL IN A TRENCH, 3" TO 4" DEEP, DUG ON CONTOUR.

FIBER ROLL

3. RUNOFF MUST NOT BE ALLOWED TO RUN UNDER OR AROUND FIBER ROLL.

-FIBER ROLL

WOOD STAKE 3/4"x3/4"


ENTRENCHMENT DETAIL
IN SLOPE AREA

2. ADJACENT ROLLS SHALL TIGHTLY ABUT.

MAX 4' SPACING

Technical Data Sheet GENERAL INFORMATION The FODS Composite trackout control system is designed to be used as a temporary construction entrance which provides site access while minimizing sediment leaving the site. The top surface of the FODS mat is a geometric pattern formed in the shape of pyramids. The mats are unidirectional and are meant to have the staggered pyramids in the direction of travel. Individual mats are connected together with hardware to form various configurations to fit your jobsite. Mat Size: 12'(w) x 7' (l) x 3 3/4" (t) (2 7/8" pyramid height)
 Truck-Load: 96-Mats Mat Weight: 430lbs Hardware boxes are contained within the palletized mats Pallet Size: 8-Mats ATURES & BENEFITS Extreme Durability Re-Usable Increased Effectiveness at Rapid Installation & Removal Reducing Site Trackout Excavation not required U/V Stable Chemical Resistant Highly Visible Rock-less Easy to Clean Reduces Waste Economical Easy and efficient to Recyclable / Reduces Waste transport from site-site TYPICAL INSTALLATION LAYOUTS Each site must be evaluated to determine the proper layout, width, and duration of the FODS Trackout Control System (FTCS) based site conditions, entry and exit egress, traffic levels, site soil conditions, and ability to the maintain trackout system. Outlined below are a number of common layouts, the mats are unidirectional and due to the versatility of the mats design the FTCS can be engineered to fit the needs of any site: FODS 1x4T FODS 2x4 FODS 1x7T FODS 1x4 FODS LLC | The Mud Stops Here | GetFods.com | 1-844-200-3637



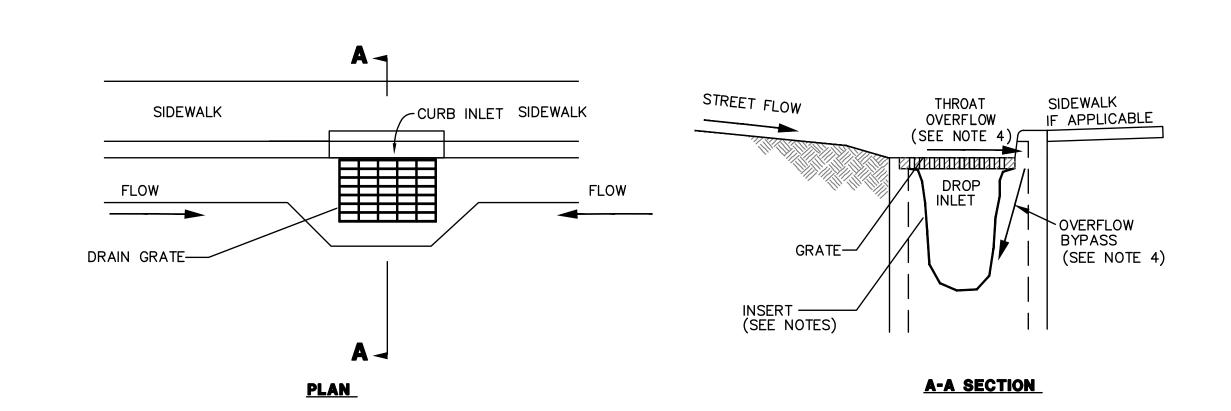

FIBER ROLLS

WOOD STAKES

_3/4"x3/4" @ 3'

O.C. MÁX. SPACING

1. PLACE FIBER ROLLS AROUND THE INLET CONSISTENT WITH DROP INLET GRAVEL BAG PROTECTION AND CURB INLET GRAVEL BAG

3. THE TOP OF THE STRUCTURE (PONDING HEIGHT) MUST BE WELL BELOW THE GROUND ELEVATION DOWNSLOPE TO PREVENT

RUNOFF FROM BY-PASSING THE INLET. EXCAVATION OF A BASIN ADJACENT TO THE DROP INLET OR A TEMPORARY DIKE ON

4. TEMPORARY REMOVABLE TRASH RACK: IF SITE CONDITIONS WARRANT, PROVIDE AND INSTALL TRASH RACK MADE FROM GALVANIZED WELDED WIRE FABRIC WITH OPENING SIZE 2" BY 2" FORMED AND ATTACHED TO THE INLET TOP GRATE WITH STEEL WIRE TIES AND

DROP INLET PROTECTION

2. FIBER ROLL INSTALLATION REQUIRES THE PLACEMENT AND SECURE STAKING OF THE FIBER ROLL IN A TRENCH, 3" - 4"

DEEP, DUG ON CONTOUR. RUNOFF MUST NOT BE ALLOWED TO RUN UNDER OR AROUND FIBER ROLL.

BURRY WELDED WIRE FABRIC 4" MINIMUM BELOW TEMPORARY ROUGH GRADE GROUND ELEVATION.

PROTECTION DETAILS SHOWN ON THIS SHEET. ROLLS ARE TUBES MADE FROM STRAW BOUND W/ PLASTIC NETTING, APPROX. 8"

SEDIMENT

TRENCH

TRAP

GRATE

PLAN VIEW

DIAMETER AND 20 TO 30 FEET LONG.

THE DOWNSLOPE OF THE STRUCTURE MAY BE NECESSARY.

SWALE SLOPE

~~►

(RUNOFF DIRECTION)

TIGHTLY WRAPED

SWALE SLOPE

◆~

 \sim

(RUNOFF DIRECTION)

PONDING HEIGHT

SLOPE (2.5:1)

FIBER ROLLS

SECTION A-A (DROP INLET/SWALE LOW POINT)

- 1. PROVIDE APPROVED CATCH BASIN INSERT FILTER BAG. CONTRACT SHALL INSTALL AND MAINTAIN FILTER BAG IN A MANNER THAT STORM DRAINAGE SYSTEM FLOWS ARE NOT OBSTRUCTED AND/OR IMPEDED.
- 2. INSPECT INLET PROTECTION DEVICE BEFORE AND AFTER RAIN EVENTS, AND WEEKLY THROUGHOUT THE RAINY SEASON. DURING EXTENDED RAIN EVENTS, INSPECT AT LEAST ONCE EVERY 24 HOURS.
- 3. REMOVE AND PROPERLY DISPOSE OF ACCUMULATED SILT AND DEBRIS TO ALLOW FOR PROPER FUNCTION OF DEVICE.
- 4. CONTRACTOR SHALL PROVIDE, INSPECT AND MAINTAIN INLET THROAT OVERFLOW RELIEF FOR ALL OFF-SITE AND ON-SITE INLETS AT ALL TIMES.

STABILIZED CONSTRUCTION ENTRANCE/EXIT

INLET SEDIMENT BARRIER

NTS

PYATOK 1611 TELEGRAPH AVE. SUITE 200 OAKLAND, CA 94612

510.465.7010 p | 510.465.8575 f www.pyatok.com

BKF ENGINEERS
255 SHORELINE DRIVE
SUITE 200
REDWOOD CITY, CA 9406
(650) 482-6300
www.bkf.com

YPRESS POINT FAMILY COMMUNIT

STA

ISION SCHEDULE

D. ISSUE DATE
Planning Resubmittal 03/25/19
Adjusted Heights 07/10/20
Coastal Development Permit 06/21/22

JOB NUMBER: C20160074
DRAWN BY: AC/CF
CHECKED BY: JD
DATE: 01/24/24
SCALE: AS SHOWN

TITLE:

OFFSITE IMPROVEMENTS

SHEET: C9.0
SHEET ---- OF 34



RESS POINT FAMILY COMMUNITY

STAMD.

/ISION SCHEDULE
ISSUE DATE
Planning Resubmittal 03/25/19

 O.
 IOSOUL
 DATE

 1
 Planning Resubmittal
 03/25/19

 2
 Adjusted Heights
 07/10/20

 3
 Coastal Development Permit
 06/21/22


JOB NUMBER: C20160074
DRAWN BY: AC/CF
CHECKED BY: JD
DATE: 01/24/24
SCALE: AS SHOWN

TITLE:

OFFSITE IMPROVEMENTS

SHEET: **C9.1**

SHEET ---- OF 34

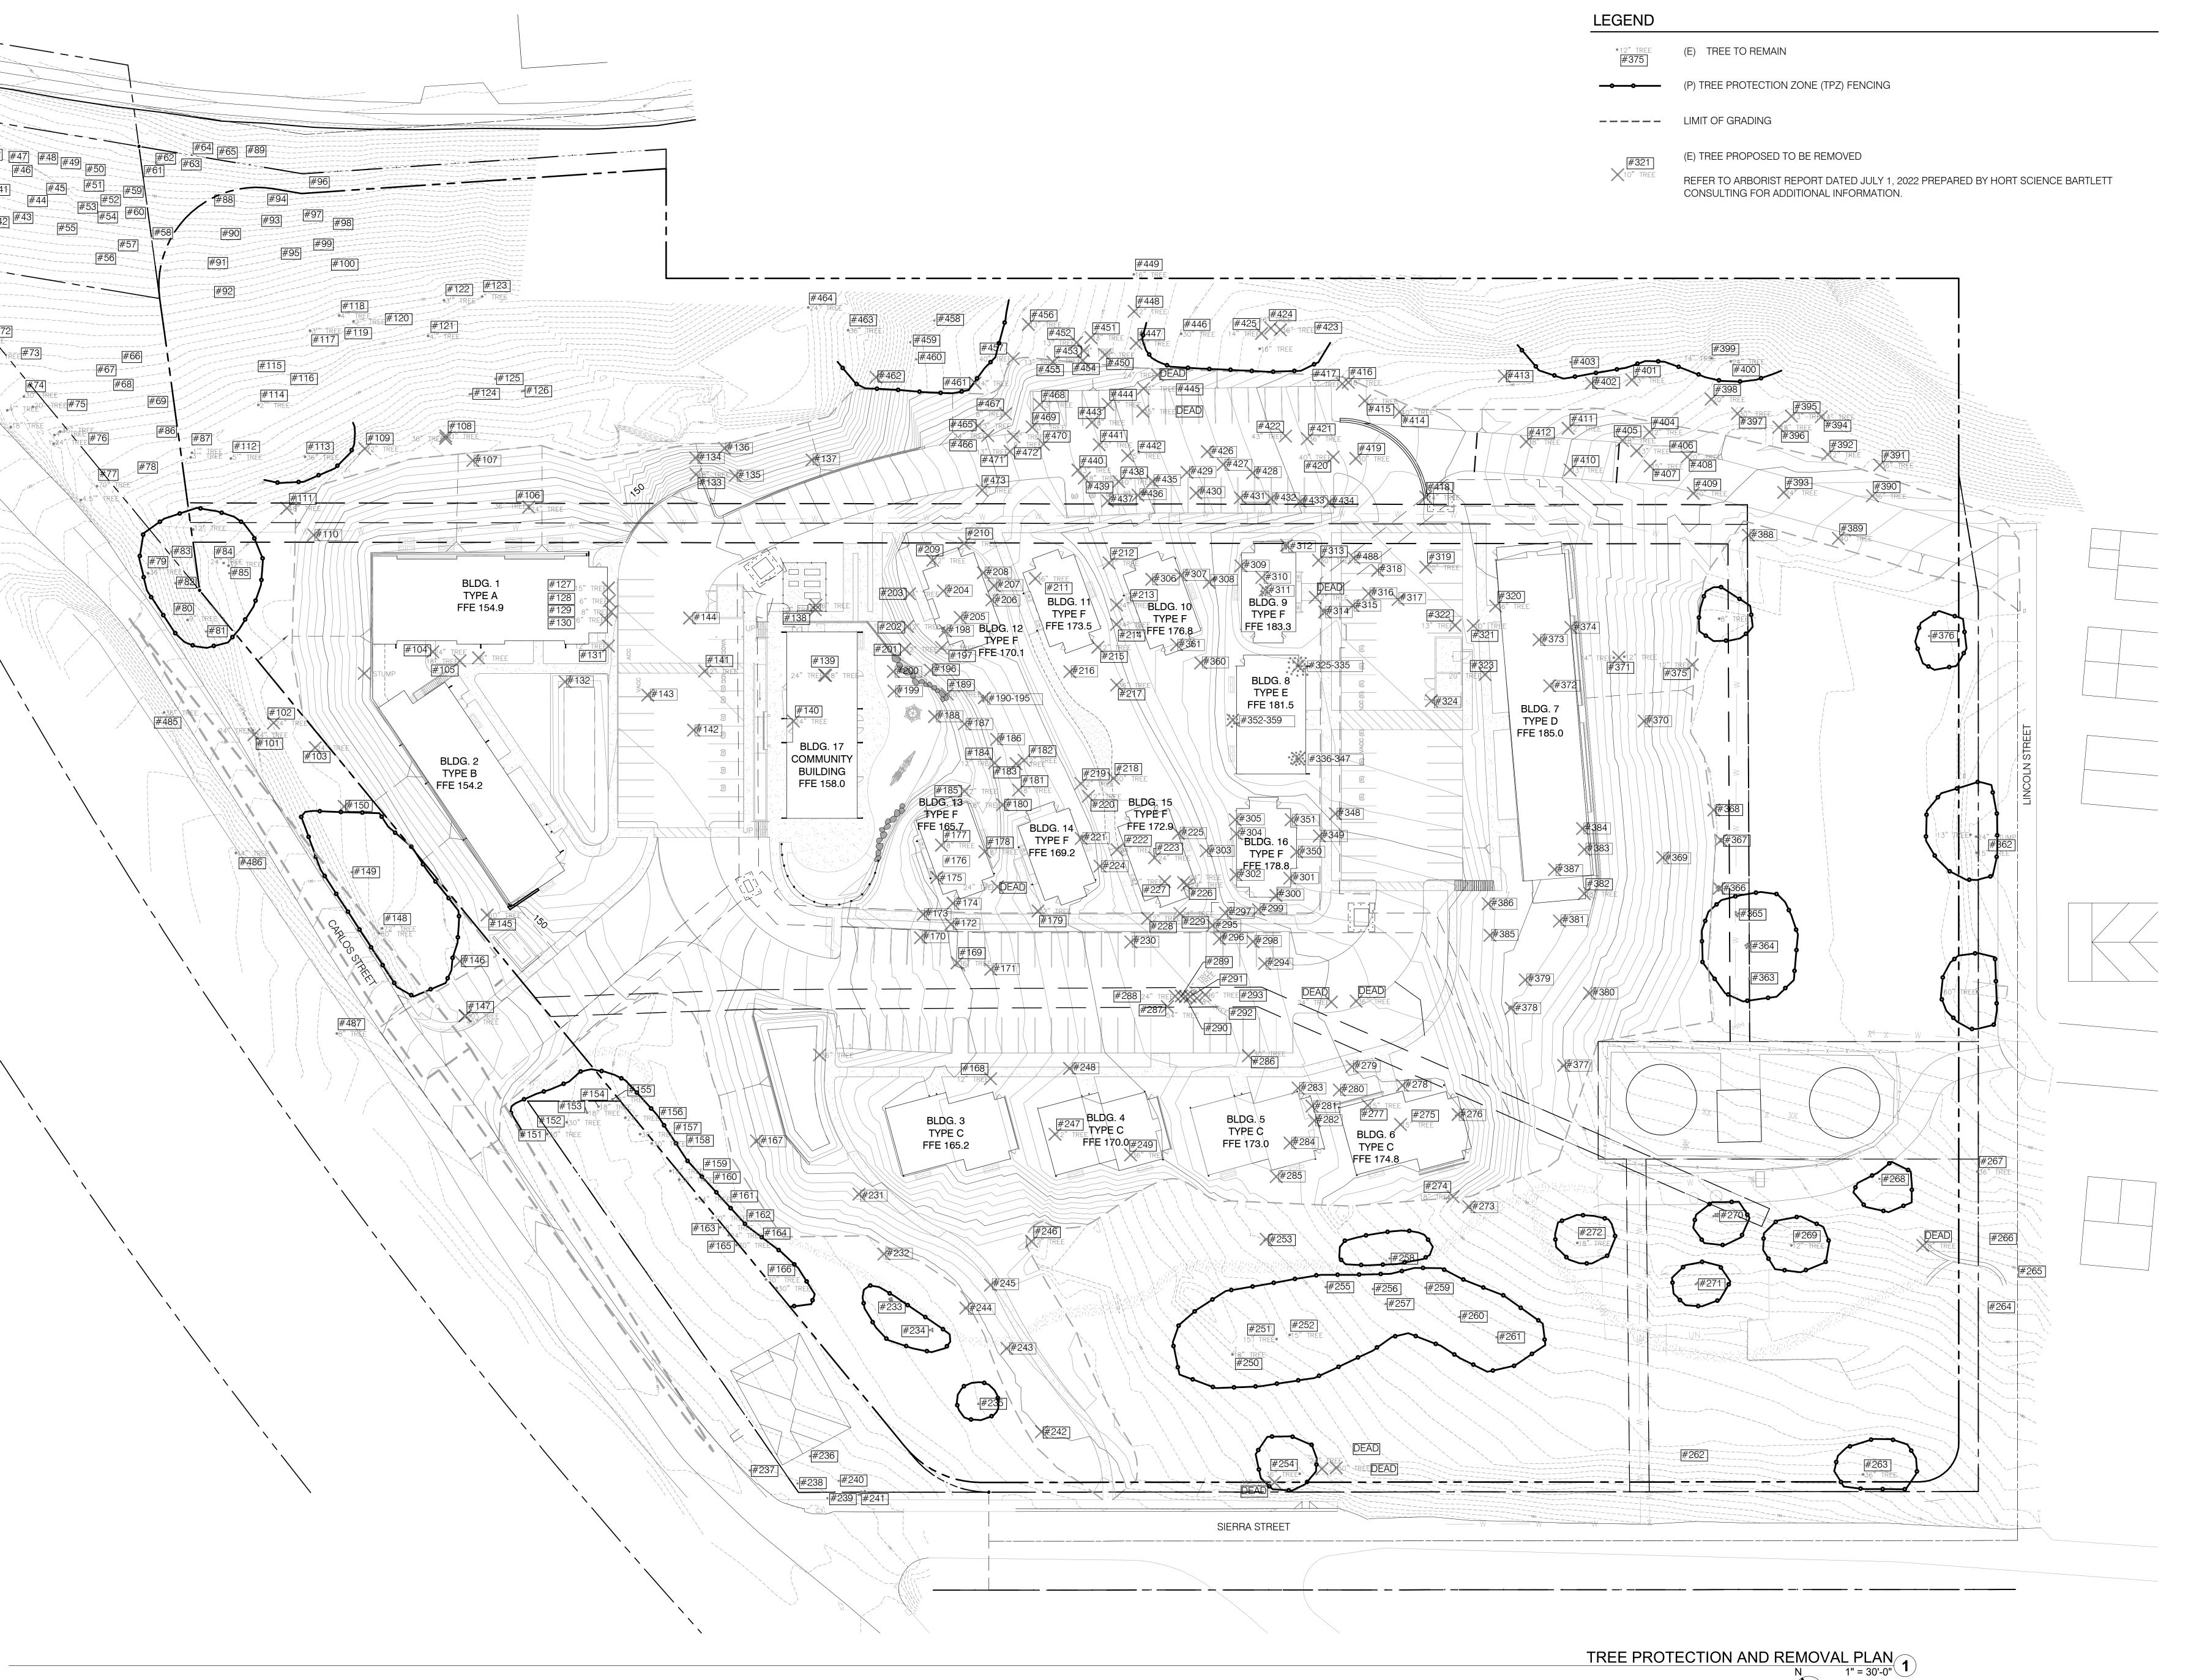

1611 TELEGRAPH AVE. SUITE 200 OAKLAND, CA 94612

510.465.7010 p | 510.465.8575 f www.pyatok.com

MIDPEN HOUSING

303 Vintage Park Drive, Suite 250 Foster City, CA 94404

JONI L. JANECKI & ASSOCIATES

515 SWIFT ST. SANTA CRUZ CA 95060

PHONE 831.423.6040 | WWW.JLJA.COM California Landscape Architect License 3163

COMMUNIT

POINT CYPRESS

STAMP:

REVISION SCHEDULE

 NO.
 ISSUE
 DATE

 1
 Planning Resubmittal
 03/25/19

 2
 Added Dimensions
 10/08/20

 3
 Adjusted Heights
 07/10/20

 4
 Footprint Reduction
 03/17/22

 5
 Tree Removal Updates
 05/03/23

 6
 Reduce Site Scope
 01/24/24

JOB NUMBER: DRAWN BY: CHECKED BY

TREE PROTECTION AND REMOVAL PLAN

TPZ1.00

EVICTING THE TO BE DEMOVED

FREE NUMBER	SPECIES	TRUNK DIAMETER (INCHES)
101	MONTEREY CYPRESS	36
102	MONTEREY CYPRESS	16
103	MONTEREY CYPRESS	27
104	MONTEREY CYPRESS	22
105 106	MONTEREY PINE MONTEREY CYPRESS	24
106	MONTEREY CYPRESS MONTEREY CYPRESS	40,10,10,7,7,6,5
108	MONTEREY CYPRESS	42
109	MONTEREY CYPRESS	48,36,26,20,18,17,16,12,12
110	MONTEREY PINE	10
111	MONTEREY CYPRESS	48
127	MONTEREY PINE	17
128	MONTEREY PINE	7
129	MONTEREY PINE MONTEREY PINE	10
131	MONTEREY PINE MONTEREY PINE	8,5 11,7
132	MONTEREY PINE	9
133	MONTEREY PINE	35,28,17
134	MONTEREY PINE	14,11
135	MONTEREY PINE	12
136	MONTEREY PINE	10
137	MONTEREY PINE	23
138 139	MONTEREY PINE MONTEREY PINE	18
140	MONTEREY PINE	18
141	MONTEREY PINE	14
142	MONTEREY PINE	8
143	MONTEREY PINE	10,6,5
144	MONTEREY PINE	6
145	MONTEREY PINE	48,28,28,222,20
146	MONTEREY PINE	11
147 150	MONTEREY CYPRESS MONTEREY PINE	28,17,13,10,10,8,8,8
167	ITALIAN STONE PINE	13,12,11,10
168	MONTEREY CYPRESS	19,19,15,14,14,13,12,12,10
		9,7,7
169	MONTEREY CYPRESS	25
170	MONTEREY PINE MONTEREY PINE	8 9
171 172	MONTEREY PINE	14
173	MONTEREY PINE	11
174	MONTEREY PINE	14
175	MONTEREY PINE	8
176	MONTEREY PINE	18
177	MONTEREY PINE	16
178	MONTEREY PINE	17
179 180	MONTEREY PINE MONTEREY PINE	17
181	MONTEREY PINE	16
182	MONTEREY PINE	12
183	MONTEREY PINE	8
184	MONTEREY PINE	15
185	MONTEREY PINE	15
186 187	MONTEREY PINE	11 9
188	MONTEREY PINE MONTEREY PINE	11
189	MONTEREY CYPRESS	21,16,15,15,14,10,10
190	MONTEREY PINE	15
191	MONTEREY PINE	8
192	MONTEREY PINE	10
193	MONTEREY PINE	14
194	MONTEREY PINE	14
195 196	MONTEREY PINE MONTEREY PINE	13
196	MONTEREY PINE MONTEREY PINE	11 15
198	MONTEREY CYPRESS	28,24,16,12,9
199	MONTEREY PINE	8
200	MONTEREY PINE	6
201	MONTEREY PINE	14,8
202	MONTEREY PINE	14
203	MONTEREY PINE	6
204	MONTEREY PINE	7
205	MONTEREY PINE MONTEREY PINE	9
207	MONTEREY PINE	13
208	MONTEREY PINE	11
209	MONTEREY PINE	13
210	MONTEREY PINE	18
211	MONTEREY CYPRESS	24,24,22,18,13,13,12,8
212	MONTEREY PINE	9
213	MONTEREY PINE MONTEREY PINE	16,11
214	MONTEREY PINE MONTEREY CYPRESS	17,15,8 10,5,5,5,5
216	MONTEREY PINE	9
217	MONTEREY PINE	22,18
218	MONTEREY CYPRESS	60
219	MONTEREY PINE	12
220	MONTEREY PINE	9
221	MONTEREY CYPRESS	9,4,3,2
222	MONTEREY PINE	16,10,9,8,6
223	MONTEREY PINE	16
	NAONITEDEV DIVIE	10
224	MONTEREY PINE MONTEREY PINE	19 18

227	MONTEREY CYPRESS	8
228	MONTEREY PINE	13
229	MONTEREY CYPRESS	17,7
230 231	MONTEREY PINE MONTEREY PINE	8
231	MONTEREY PINE MONTEREY PINE	13,9
243	MONTEREY PINE	10,9
242	ITALIAN STONE PINE	6
244	MONTEREY PINE	6,3
245	MONTEREY PINE	6
246	MONTEREY PINE	19
247 248	MONTEREY PINE MONTEREY PINE	7,4 14,11
249	MONTEREY CYPRESS	19,18,12,12,7,6,6,5,5,4,4,4
		4
253	MONTEREY PINE MONTEREY PINE	21, 11
273 274	MONTEREY PINE MONTEREY PINE	22,13,11
275	MONTEREY PINE	25,9
276	MONTEREY PINE	9,8
277	MONTEREY PINE	20
278	MONTEREY PINE	6
279	MONTEREY PINE	8
280 281	MONTEREY PINE MONTEREY PINE	11 7
282	MONTEREY PINE	7
283	MONTEREY PINE	7
284	MONTEREY PINE	22
285	MONTEREY PINE	10
286	MONTEREY CYPRESS	26,13,13,6,6
287 288	MONTEREY CYPRESS MONTEREY CYPRESS	38,30,28,26,13 15,15
288 289	MONTEREY CYPRESS MONTEREY CYPRESS	22,20
290	MONTEREY CYPRESS	15
291	MONTEREY CYPRESS	14
292	MONTEREY CYPRESS	30,22,20
293	MONTEREY CYPRESS	34,30,28,27,24,12
294 295	MONTEREY CYPRESS MONTEREY PINE	14 7
293 296	MONTEREY CYPRESS	6
297	MONTEREY CYPRESS	6,4
298	MONTEREY PINE	8
299	MONTEREY CYPRESS	7
300	MONTEREY CYPRESS	9
301 302	MONTEREY PINE MONTEREY PINE	8 13
303	MONTEREY PINE	13
304	MONTEREY CYPRESS	38
305	MONTEREY PINE	22
306	MONTEREY PINE	7
307	MONTEREY CYPRESS	24
308	MONTEREY CYPRESS MONTEREY CYPRESS	29 68
310	MONTEREY CYPRESS	25
311	MONTEREY CYPRESS	18,15,13,13,13,12,12,12
312	MONTEREY CYPRESS	20,13,6,6,6,5
313	MONTEREY PINE	15
314	MONTEREY CYPRESS	22,8,5,4
315 316	MONTEREY PINE MONTEREY PINE	24
317	MONTEREY PINE	14
318	MONTEREY PINE	8
319	MONTEREY PINE	25
320	MONTEREY PINE	28
321 322	MONTEREY PINE	10
322 323	MONTEREY PINE MONTEREY PINE	18 25
324	MONTEREY PINE	15,14,13
325	MONTEREY PINE	16
326	MONTEREY CYPRESS	15,14,7,6,4,4
327	MONTEREY CYPRESS	9,6
328 329	MONTEREY PINE MONTEREY PINE	15 17
330	MONTEREY PINE	6
331	MONTEREY CYPRESS	6,5
332	MONTEREY CYPRESS	9,4
333	MONTEREY PINE	16
334	MONTEREY CYPRESS MONTEREY PINE	8,5,5,4,3
336	MONTEREY PINE	9
337	MONTEREY CYPRESS	10
338	MONTEREY PINE	12
339	MONTEREY PINE	7
340	MONTEREY PINE	10
341 342	MONTEREY PINE MONTEREY CYPRESS	20 10 7 7 6 6
04∠	MONTEREY CYPRESS MONTEREY CYPRESS	20,10,7,7,6,6
343		19
343 344	MONTEREY PINE	1
	MONTEREY PINE MONTEREY PINE	17
344		17 12
344 345 346 347	MONTEREY PINE MONTEREY PINE MONTEREY PINE	12 16
344 345 346 347 348	MONTEREY PINE MONTEREY PINE MONTEREY PINE MONTEREY PINE	12 16 6
344 345 346 347 348 349	MONTEREY PINE MONTEREY PINE MONTEREY PINE MONTEREY PINE MONTEREY PINE	12 16 6 8
344 345 346 347 348	MONTEREY PINE MONTEREY PINE MONTEREY PINE MONTEREY PINE	12 16 6
344 345 346 347 348 349 350	MONTEREY PINE MONTEREY PINE MONTEREY PINE MONTEREY PINE MONTEREY PINE MONTEREY PINE	12 16 6 8 6

MONTEREY PINE

MONTEREY CYPRESS

353

354

	MONTEREVERINE	T
355 356	MONTEREY PINE MONTEREY PINE	12 16
357	MONTEREY CYPRESS	9,8,4
358	MONTEREY CYPRESS	9
359 360	MONTEREY PINE MONTEREY PINE	7 10
361	MONTEREY CYPRESS	6
366	MONTEREY CYPRESS	7,6,4,4,3,3
367	MONTEREY CYPRESS	6,4,2,2
368 369	MONTEREY CYPRESS MONTEREY PINE	52 18
370	MONTEREY PINE	12
371	MONTEREY PINE	20,18
372	MONTEREY PINE	8,7,5
373 374	MONTEREY PINE MONTEREY PINE	10
375	MONTEREY PINE	24
377	MONTEREY PINE	6,3
378 379	MONTEREY PINE MONTEREY PINE	22,9,8,6,6
380	MONTEREY PINE	22
381	MONTEREY PINE	9
382	MONTEREY PINE	24
383 384	MONTEREY PINE MONTEREY PINE	6
385	MONTEREY PINE	6
386	MONTEREY PINE	7
387	MONTEREY PINE	6
388 389	MONTEREY PINE MONTEREY PINE	7 34,18,17,12,10
390	MONTEREY PINE	36
391	MONTEREY PINE	36
392	MONTEREY PINE	13
393 394	MONTEREY PINE MONTEREY PINE	26 17
395	MONTEREY PINE	16
396	MONTEREY PINE	17
397	MONTEREY PINE	25
398 401	MONTEREY PINE MONTEREY PINE	19
402	MONTEREY PINE	26
404	MONTEREY PINE	13
405 406	MONTEREY PINE MONTEREY PINE	19 17
407	MONTEREY PINE	19,10,7
408	MONTEREY PINE	20
409	MONTEREY PINE	24
410 411	MONTEREY PINE MONTEREY PINE	16
412	MONTEREY PINE	40
413	MYOPORUM	10
414	MONTEREY PINE	45
415 416	MONTEREY PINE MONTEREY PINE	14 27
417	MONTEREY PINE	17
418	MONTEREY PINE	22
419	MONTEREY PINE	35
420 421	MONTEREY PINE MONTEREY PINE	38
422	MONTEREY PINE	25,16
423	MONTEREY PINE	38
424	MONTEREY PINE	15
425 426	MONTEREY PINE MONTEREY PINE	28
420	MONTEREY PINE	6
428	MONTEREY PINE	8
429	MONTEREY PINE	7
430 431	MONTEREY CYPRESS MONTEREY PINE	10
431	MONTEREY PINE	7
433	MONTEREY CYPRESS	8
434	MONTEREY PINE	7
435 436	MONTEREY PINE MONTEREY CYPRESS	18
436	MONTEREY PINE	9
438	MONTEREY CYPRESS	24,18,15,12,12,6,6,6
439	MONTEREY PINE	20
440 441	MONTEREY CYPRESS MONTEREY CYPRESS	19 15
442	MONTEREY PINE	16
443	MONTEREY PINE	23
444	MONTEREY PINE	16
445 447	MONTEREY PINE MONTEREY PINE	10 30
447	MONTEREY PINE	13
450	MONTEREY PINE	10
451	MONTEREY PINE	14
452 453	MONTEREY PINE MONTEREY PINE	18 6
453 454	MONTEREY PINE MONTEREY PINE	8
455	MONTEREY PINE	18
456	MONTEREY PINE	18
457 461	MONTEREY PINE MONTEREY PINE	33,28,24
461 462	MONTEREY PINE MONTEREY PINE	23 45
465	MONTEREY PINE	17
466	MONTEREY PINE	24
467	MONTEREY PINE	12

MONTEREY PINE

467	MONTEREY PINE	12
468	MONTEREY PINE	18
469	MONTEREY PINE	16
470	MONTEREY PINE	8
471	MONTEREY PINE	18
472	MONTEREY PINE	9
473	MONTEREY PINE	6
488	MONTEREY PINE	18

TREE SUMMARY:

PROPOSED NUMBER OF EXISTING TREES TO REMAIN: 193 PROPOSED NUMBER OF EXISTING TREES TO BE REMOVED: 295

REFER TO ARBORIST REPORT DATED JULY 1, 2022 PREPARED BY HORT SCIENCE BARTLETT CONSULTING FOR ADDITIONAL INFORMATION.

1611 TELEGRAPH AVE. SUITE 200 OAKLAND, CA 94612

510.465.7010 p | 510.465.8575 f www.pyatok.com

MIDPEN HOUSING

303 Vintage Park Drive, Suite 250 Foster City, CA 94404

> JONI L. JANECKI & ASSOCIATES

515 SWIFT ST. SANTA CRUZ CA 95060 PHONE 831.423.6040 | WWW.JLJA.COM California Landscape Architect License 3163

COMMUNIT

STAMP:

REVISION SCHEDULE

TREE REMOVAL LIST

TPZ1.01

510.465.7010 p | 510.465.8575 f www.pyatok.com

MIDPEN HOUSING

303 Vintage Park Drive, Suite 250 Foster City, CA 94404



515 SWIFT ST. SANTA CRUZ CA 95060 PHONE 831.423.6040 | WWW.JLJA.COM California Landscape Architect License 3163

COMMUNIT

1

STAMP:

REVISION SCHEDULE
 NO.
 ISSUE
 DATE

 1
 Planning Resubmittal
 03/25/19

 2
 Added Dimensions
 10/08/20

 3
 Adjusted Heights
 07/10/20

 4
 Footprint Reduction
 03/17/22

 5
 Tree Removal Updates
 05/03/23

 6
 Reduce Site Scope
 01/24/24

11. CONTRACTOR TO FULLY REMOVE AND GRIND OR DIG OUT ALL STUMPS OF TREES TO BE REMOVED.

7. NATURAL GRADE AROUND TPZ SHALL BE MAINTAINED. NO ADDITIONAL FILL OR

8. UNAUTHORIZED PRUNING OF ANY TREE SHALL NOT BE ALLOWED. IF ANY TREE

PROVIDE TEMPORARY IRRIGATION TO ALL TREES WITHIN THE FENCED AREA.

NATIONAL STANDARDS INSTITUTE (ANSI) A-300 PRUNING STANDARDS.

THROUGHOUT CONSTRUCTION UNTIL FINAL SIGN OFF BY OWNER'S

CONTRACTOR TO CLEARLY MARK TREES AND WALK SITE WITH OWNER'S

EXCAVATION WILL BE PERMITTED WITHIN AREAS OF TREE ROOT DEVELOPMENT.

CANOPY ENCROACHES ON THE PROJECT AREA, THE REQUIRED PRUNING WILL BE DONE WITH AUTHORITY OF OWNER'S REPRESENTATIVE OR PROJECT ARBORIST AND

TO INTERNATIONAL SOCIETY OF ARBORICULTURE GUIDELINES (ISA) AND AMERICAN

CONTRACTOR TO PROVIDE WATERING SCHEDULE FOR OWNER'S REPRESENTATIVE

REVIEW AND APPROVAL. WATERING SCHEDULE TO BE SUBMITTED FOR APPROVAL TEN (10) CALENDAR DAYS BEFORE CONSTRUCTION START DATE AND CONTINUE

- 12. TREE PROTECTION FENCING TO BE REMOVED BY CONTRACTOR AFTER COMPLETION OF CONSTRUCTION AND AS DIRECTED BY OWNER'S REPRESENTATIVE.
- 13. REFER TO CIVIL PLANS FOR EROSION CONTROL INFORMATION.

REPRESENTATIVE TO VERIFY TREES TO BE REMOVED.

TREE PROTECTION ZONE NOTICE TEMPLATE

PRESERVATION

AREA – KEEP

TREE PROTECTION ZONE FENCING MUST REMAIN IN PLACE DURING THE ENTIRE CONSTRUCTION PERIOD FENCING MUST NOT BE MOVED OR DISMANTLED WITHOUT THE NOTIFICATION OF THE PROJECT MANAGER AND THE WRITTEN CONSENT OF THE PROJECT ARBORIST

TREE PROTECTION AND REMOVAL NOTES

- 1. A TREE PRESERVATION ZONE (TPZ) SHALL BE ESTABLISHED AS SHOWN ON PLAN AND AS VERIFIED IN THE FIELD WITH OWNER'S REPRESENTATIVE OR PROJECT ARBORIST. PROJECT ARBORIST MUST INSPECT AND DOCUMENT THE INSTALLATION OF TREE PROTECTION BEFORE ANY EQUIPMENT COMES ON SITE.
- 2. TREE PROTECTION ZONE FENCING FENCE HEIGHT TO BE 6 FEET AND MUST COMPRISE OF STEEL CHAIN-LINK CONSTRUCTION, ATTACHED TO STEEL POSTS DRIVEN INTO THE GROUND. LAMINATED TREE PROTECTION NOTICES MUST BE ATTACHED TO TPZ FENCES AT DISTANCES OF EVERY 10-FEET (SEE TREE PROTECTION ZONE NOTICE TEMPLATE ABOVE). ALL CONSTRUCTION ACTIVITIES MUST BE EXCLUDED FROM FENCED TREE PROTECTION ZONES. THESE FENCES MUST NOT BE DISMANTLED OR MOVED AT ANY TIME DURING THE CONSTRUCTION PERIOD, WITHOUT FIRST OBTAINING THE CONSENT OF THE OWNER'S REPRESENTATIVE OR PROJECT ARBORIST.
- 3. CONTRACTOR TO SUBMIT SCHEDULE OF TREE PROTECTION FENCE INSTALLATION AND REMOVAL FOR REVIEW AND APPROVAL BY OWNER'S REPRESENTATIVE PRIOR TO 10. CONTRACTOR TO REMOVE TREES AS SHOWN ON THE PLAN. PRIOR TO REMOVAL, FENCE INSTALLATION OR REMOVAL.
- 4. VEHICLES AND EQUIPMENT MUST BE EXCLUDED FROM TREE PROTECTION ZONES. NO MATERIALS, TOOLS, DEBRIS, EXCESS SOIL, CHEMICALS, OR WASTE PRODUCTS MAY BE STORED OR DISPOSED OF WITHIN THESE PROTECTED AREAS. SOLVENTS, LIQUIDS, CONCRETE WASH-OFF, OR ANY TYPE OF DEBRIS SHOULD BE DISPOSED OF PROPERLY, NEVER WITHIN THIS PROTECTED AREA.
- 5. ALL TRENCHING NEAR EXISTING TREES TO REMAIN SHALL BE HAND DUG AND REVIEWED BY OWNER'S REPRESENTATIVE OR PROJECT ARBORIST.
- 6. NO SOIL COMPACTION SHALL OCCUR WITHIN THE TPZ. SOIL SURFACE WITHIN THE 14. REFER TO CIVIL PLANS FOR GRADING AND DRAINAGE INFORMATION. TPZ SHALL BE MULCHED WITH A 4-INCH LAYER OF AGED WOOD CHIPS AND SET BACK 9-INCHES FROM TRUNKS AT GRADE. WOOD CHIP MULCH SHALL BE APPROVED BY OWNER'S REPRESENTATIVE PRIOR TO ORDERING. SUBMIT MULCH SAMPLES TO OWNER'S REPRESENTATIVE PRIOR TO INSTALLATION.

REPRESENTATIVE.

ARBORIST'S INSPECTION SCHEDULE

- 1. THE PROJECT ARBORIST MUST ATTEND A PRE-CONSTRUCTION MEETING WITH THE 4. THE PROJECT ARBORIST MUST PROVIDE SUPERVISION AND OVERSIGHT GENERAL CONTRACTOR AND THE GRADING CONTRACTOR BEFORE ANY SITE WORK PROCEEDS IN ORDER TO DISCUSS TREE PROTECTION REQUIREMENTS. THE PROJECT ARBORIST MUST ALSO BE NOTIFIED CONCERNING SCHEDULED SITE MEETINGS THROUGHOUT THE CONSTRUCTION PERIOD.
- 2. TREE PROTECTION ZONE FENCING MUST BE INSTALLED AND APPROVED OF BY THE PROJECT ARBORIST BEFORE ANY EQUIPMENT COMES ON SITE AND ANY SITE WORK PROCEEDS.
- 3. THE PROJECT ARBORIST MUST PROVIDE SUPERVISION AND OVERSIGHT IN THE EVENT THAT ANY GRADING, EXCAVATION OR TRENCHING WORK WILL ENCROACH WITHIN THE TREE PROTECTION ZONES DEFINED BY TPZ FENCES. THE PROJECT ARBORIST MUST PROVIDE DIRECTION AND SUPERVISION CONCERNING REQUIRED ROOT PRESERVATION AND ROOT PRUNING MEASURES.
- CONCERNING ALL CONSTRUCTION DISTURBANCES THAT ENCROACH WITHIN THE CRITICAL ROOT ZONES AREAS OF PROTECTED TREES (AS DEFINED BY THEIR CANOPY DRIP LINE PERIMETERS OR THEIR TRUNK DIAMETER MEASUREMENTS).
- 5. THE PROJECT ARBORIST MUST BE NOTIFIED IN THE EVENT THAT SIGNIFICANT ROOT, 2-INCH DIAMETER OR LARGER, ARE FOUND DURING ANY GRADING, TRENCHING, AND CONSTRUCTION ACTIVITIES. THE WORK SHALL STOP, ROOTS SHALL BE COVERED WITH BURLAP OR MULCH, AND OWNER'S REPRESENTATIVE OR PROJECT ARBORIST CONTACTED TO PROVIDE RECOMMENDATIONS ON ROOT CUTTING AND TREATMENT OF IMPACTED ROOTS PRIOR TO CONTINUING WORK.
 - 6. PROJECT ARBORIST TO PROVIDE GUIDANCE AND SUPERVISION PERTAINING TO REQUIRED TREE PRUNING WORK. MEET WITH THE APPROVED TREE SERVICE PROVIDER TO DISCUSS THE REQUIRED SCOPE OF WORK AND PROVIDE INSPECTIONS AND OVERSIGHT AS NEEDED.

JOB NUMBER: DRAWN BY: CHECKED BY DATE: SCALE:

TREE PROTECTION NOTES

TITLE:

TPZ1.02



www.pyatok.com

1611 TELEGRAPH AVE. SUITE 200 OAKLAND, CA 94612 510.465.7010 p | 510.465.8575 f

MIDPEN HOUSING

303 Vintage Park Drive, Suite 250 Foster City, CA 94404

JONI L. JANECK & ASSOCIATES

515 SWIFT ST. SANTA CRUZ CA 95060 PHONE 831.423.6040 | WWW.JLJA.COM California Landscape Architect License 3163

LINOMWO

NO

C

REVISION SCHEDULE

Planning Resubmittal	03/25/19
Added Dimensions	10/08/20
Adjusted Heights	07/10/20
Footprint Reduction	03/17/22
Tree Removal Updates	05/03/23
Reduce Site Scope	01/24/24

STAMP:

DETENTION BASINS

SLOPE PLANTING - SEE CIVIL DRAWINGS FOR EROSION

PROPOSED NUMBER OF EXISTING TREES TO BE

3. FINAL PROPOSED TREE COUNT WILL FOLLOW

COUNTY REQUIREMENT FOR REPLACEMENT.

-- -- -- 6'-0" HIGH WOOD AND WIRE FENCE

BOULDER RETAINING WALL BICYCLE PARKING

RAISED VEGETABLE BEDS

SYNTHETIC TURF, FLUSH WITH ADJACENT PAVING

ASPHALT PAVING

DECOMPOSED GRANITE PAVING

FOOT-PATH TRAIL EXACT LOCATION TO BE DETERMINED IN THE FIELD

GRAVEL PAVING

CYPRESS POINT ENTRY DRIVE

BIORETENTION AREA

SYNTHETIC TURF OR ALTERNATIVE PLAY

BICYCLE PARKING, SEATING, AND BBQ

BOULDER RETAINING WALL (LESS THAN 30" CONCRETE RETAINING WALL (LESS THAN

LOW MAINTENANCE PLANTING ON TERRACED SLOPE - NATIVE TREES,

SHRUBS, AND GRASSES STAIRS WITH HANDRAILS

COMMUNITY GARDEN WITH FENCE, RAISED BEDS, AND COMPOST AREA

WASTE ENCLOSURE AND BICYCLE PARKING (2 TOTAL)

NOTE NOT USED

EXISTING GRAVEL ACCESS ROAD EXISTING WATER TANKS AND FENCE TO BE

TRAIL - CLEARED DIRT NON-ACCESSIBLE FOOT PATH AROUND SITE WITH MINIMAL

PARKING LOT - ASPHALT PAVING, SEE CIVIL DRAWINGS

ACCESSIBLE CROSSING

CONCRETE PATH TO SIERRA STREET EMERGENCY VEHICLE ROUTE (ASPHALT

DECOMPOSED GRANITE PATH WITH BENCH RAMPS WITH HANDRAILS AND LANDINGS APPROXIMATE LOCATION OF EXISTING TRAIL JOB NUMBER:

CHECKED BY: 06/21/2022 1" = 30'-0"

OVERALL LANDSCAPE SITE PLAN

- 4X4 REDWOOD POST

— 2X4 REDWOOD RAIL

(TOP AND BOTTOM)

– ATTACH STAKES TO

STEEL SCREWS

— FINISH GRADE

— ANGLE TOP OF POST TO

DRAIN. HOLD TOP OF POST

— CONCRETE FOOTING

- CLEAN DRAIN ROCK

2-INCHES BELOW TOP OF

FENCE.

2X4 REDWOOD RAIL (TOP AND BOTTOM)

- 4X4 REDWOOD POST

RAILS WITH STAINLESS

1. ALL HARDWARE AND ATTACHMENTS TO BE HOT-DIP GALVANIZED OR STAINLESS STEEL

2. SINGLE-SIDED: ATTACH PICKETS TO OUTSIDE/STREET-SIDE FACE OF RAILS.

4. FLAG LOCATION IN FIELD FOR REVIEW WITH LANDSCAPE ARCHITECT.

MAXIMUM 7'-0" ON CENTER

— 1/16-INCH SPACING

BETWEEN STAKES

3. PROVIDE GRAPE STAKE SAMPLES FOR LANDSCAPE ARCHITECT'S REVIEW AND

5. STAKES TO BE ROUGH EDGE. KEEP TOP AND BOTTOM OF STAKES LEVEL AND CLEAN

AS NOTED.

CUT.

<u>PLAN</u>

ELEVATION

2X4 REDWOOD RAIL -(TOP AND BOTTOM)

ATTACH STAKES TO —

RAILS WITH

STAINLESS STEEL

4X4 REDWOOD POST -

SINGLE-SIDED GRAPE STAKE FENCE DETAIL

FINISH GRADE -

SIDE SECTION

1/2" = 1'-0"


TITLE:

LANDSCAPE MATERIALS DETAILS


AS NOTED


SHEET:

L 1 _ 0 1

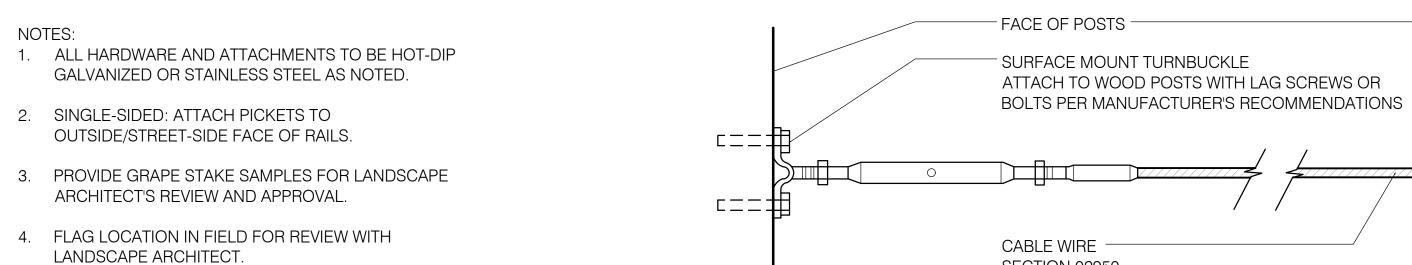

5. STAKES TO BE ROUGH EDGE. KEEP TOP AND BOTTOM OF STAKES LEVEL AND CLEAN CUT.

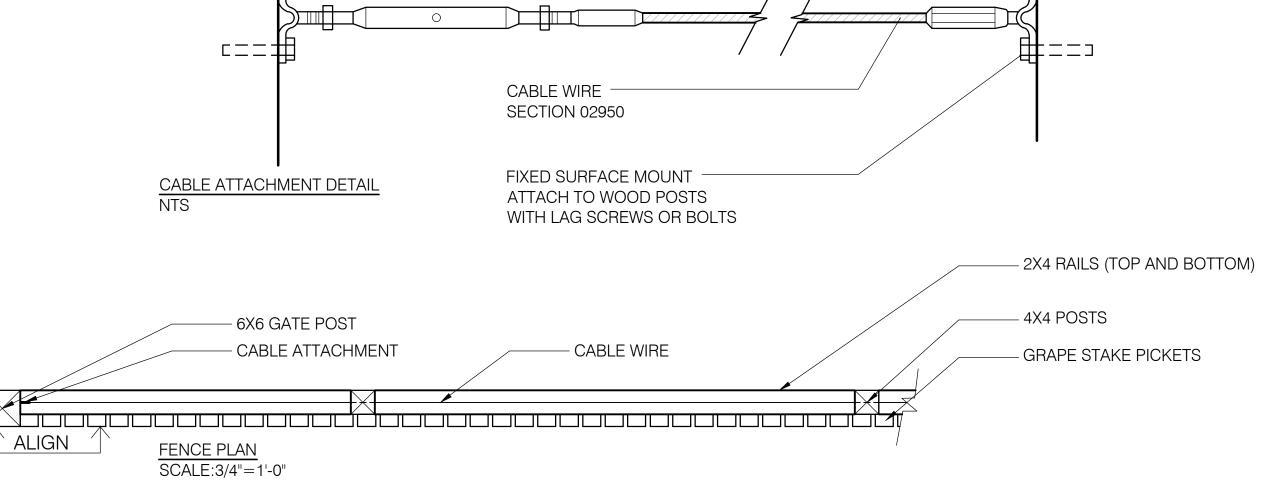

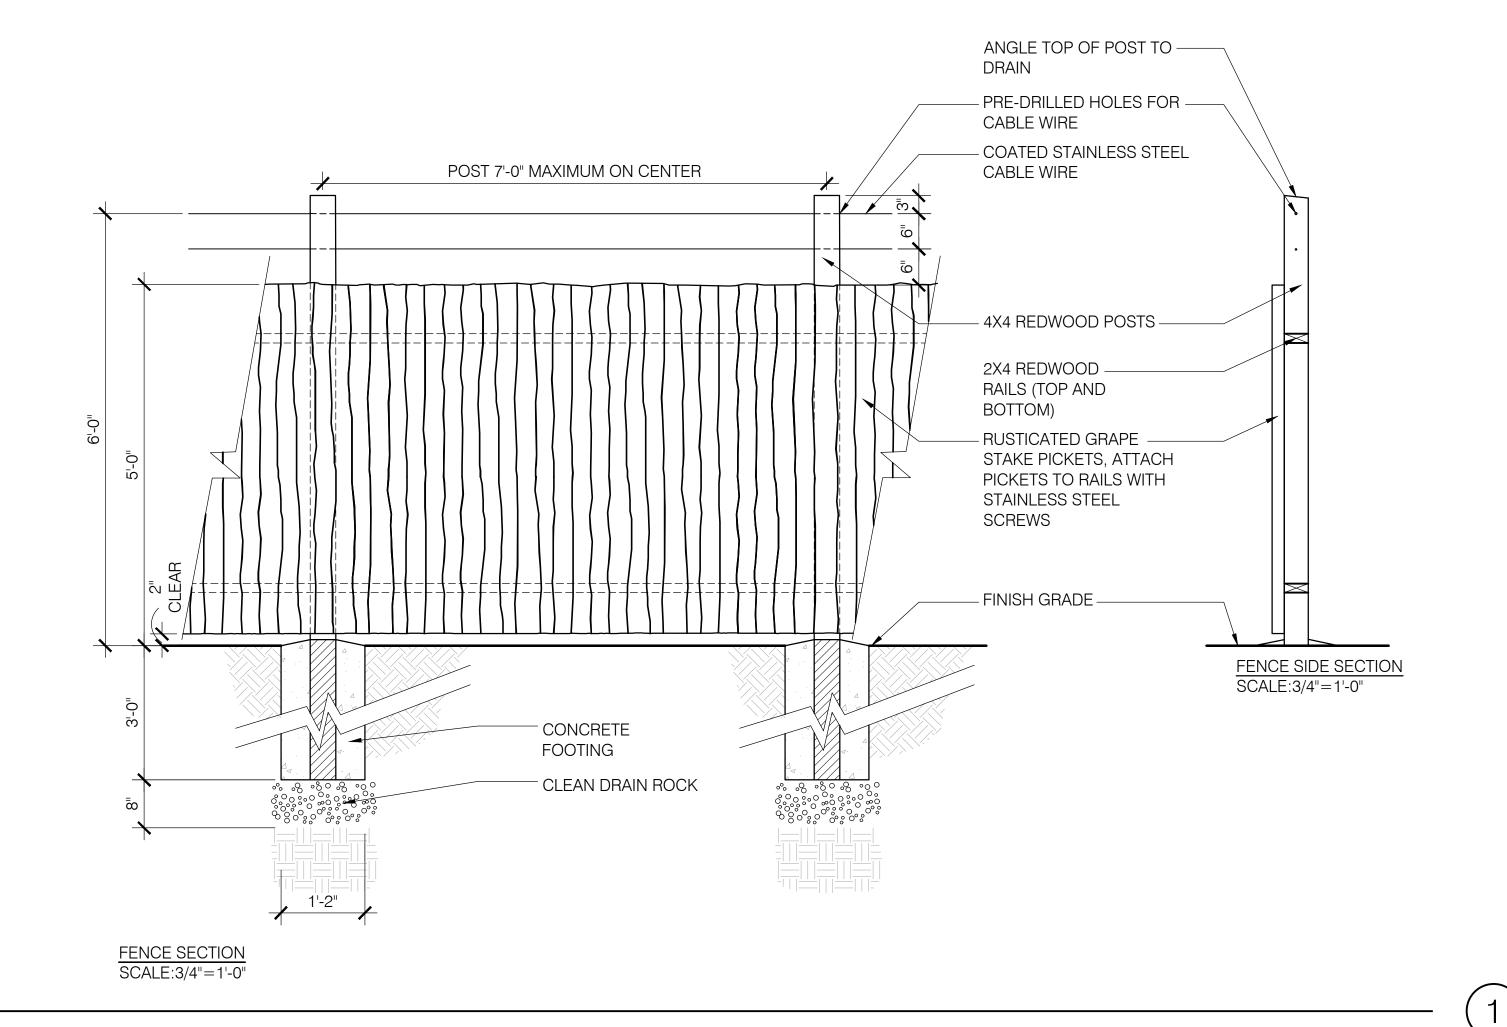

COMMUNITY GARDEN FENCE DETAIL

NOTES:

1. REFER TO DETAIL 1, THIS SHEET,

2. SLOPES LESS THAN 3:1 DO NOT

REQUIRE TEMPORARY BERMS.

PREVAILING WIND

FOR GENERAL NOTES.

TYPICAL PLANT SPACING DETAIL NOT TO SCALE

WIDTH OF PLANT OR CELL - PLANT TAMPERED FRIABLE SOIL TO COMPLETELY SURROUND AND COVER ROOT SYSTEM AND POTTING SOIL MIX AMENDED TOP SOIL NO SMOOTH EDGES OR GLAZED SURFACES

PLUG PLANTING DETAIL NOT TO SCALE

REMOVE TEMPORARY WATERING BASINS ONCE RAINY SEASON HAS COMMENCED.

 EASE SLOPE BACK TO PREVENT SLIPPING SET CROWN OF ROOTBALL 1-INCH ABOVE EXISTING GRADE - 3-INCH LAYER OF WOOD CHIP MULCH, HOLD CLEAR OF ROOT CROWN -SECTION 32 93 00 6-INCH HIGH BERM ON DOWNHILL SIDE. KEY AND TAPER INTO SLOPE ROOTBALL - FINISH GRADE - SECTION 31 22 19 BACKFILL - SECTION 32 91 13 SCARIFY AND TAMP NATIVE SOIL -UNDER ROOTBALL. SLOPE BOTTOM OF PIT DOWNHILL SIDE.

SHRUB PLANTING ON SLOPE DETAIL NOT TO SCALE

PLANT PIT

TO BE

TWO (2) TIMES

ROOTBALL

WIDTH

REMOVE TEMPORARY WATERING BASINS ONCE RAINY SEASON HAS COMMENCED.

2. IF NATIVE SOIL HAS BEEN TREATED WITH LIME, TREATED SOIL TO BE EXCAVATED AND REPLACED WITH IMPORTED SOIL. DRAINAGE/PERCOLATION TESTS TO BE ADMINISTERED. SEE CIVIL AND SECTION 32 91 13 FOR MORE INFORMATION.

EASE SLOPE BACK TO PREVENT

SLIPPING

/ 3-INCH LAYER OF MULCH, HOLD CLEAR OF ROOT CROWN - 3-INCH HIGH TEMPORARY WATERING -ROOT-BALL - FINISH GRADE - BACKFILL MIX - SECTION 32 91 13 - SCARIFY AND TAMP NATIVE SOIL UNDER ROOTBALL.

TREE PLANTING ON SLOPE DETAIL

1. ALL TREES TO BE STAKED ON PREVAILING WIND SIDE WHEN TREE IS IN LEAF. VERIFY ALL CONNECTORS ARE SECURE AND

2. CONTRACTOR SHALL DOUBLE STAKE ALL 15 GALLON, 24-INCH

& 36-INCH BOX TREES. 3. CONTRACTOR SHALL REMOVE NURSERY STAKE(S) AND TAGS

FROM TREES UPON COMPLETION OF STAKING. 4. "WONDER TREE TIES" SHALL BE

INSTALLED PER

MANUFACTURER'S

HAS COMMENCED.

INSTRUCTIONS. 5. REMOVE TEMPORARY WATERING BASINS ONCE RAINY SEASON

6. CONTRACTOR TO COORDINATE AND PROVIDE PHOTOS OF PROPOSED TREES.

PLANT PIT TO BE

THREE (3) TIMES

ROOTBALL WIDTH

PLANTS WITH LARGE CIRCLING ROOTS OR KINKED ROOTS ON INTERIOR OF THE ROOTBALL WILL NOT BE ACCEPTED.

8. TREES SHALL BE SUPPLIED WITH WELL TAPERED STRONG TRUNKS WHICH WILL STAND ALONE.

9. TREES SUPPLIED WITH TOPS TOO LARGE FOR TRUNKS TO SUPPORT SHALL BE PRUNED AS DIRECTED BY OWNER'S REPRESENTATIVE TO REDUCE CROWN HEIGHT. DO NOT REMOVE LATERALS ALONG TRUNK. DO NOT PRUNE TREES WITHOUT PRIOR APPROVAL FROM OWNER'S

REPRESENTATIVE.

PLANT PIT

MINIMUM THREE (3) TIMES

ROOTBALL WIDTH

10. IF NATIVE SOIL HAS BEEN TREATED WITH LIME, TREATED SOIL TO BE EXCAVATED AND REPLACED WITH IMPORTED SOIL. DRAINAGE/PERCOLATION TEST TO BE ADMINISTERED. SEE CIVIL AND SECTION 32 91 13 FOR

- CUT TREE WELL INTO SLOPE

SEE DETAIL 1, THIS SHEET FOR

SET TOP OF ROOTBALL 2-INCHES

3-INCH LAYER OF MULCH. HOLD

6-INCH HIGH BERM AROUND INSIDE

BACKFILL MIX - SECTION 32 91 13

SCARIFY AND TAMP NATIVE SOIL

12-INCHES AWAY FROM TRUNK

PLANT, STAKE AND TREE TIE

ABOVE FINISH GRADE

EDGE OF TREE PIT

FERTILIZER TABLETS -

SECTION 32 93 00

UNDER ROOTBALL

MORE INFORMATION.

REVISION SCHEDULE Planning Resubmittal 03/25/19

Added Dimensions 10/08/20

Adjusted Heights 07/10/20

Footprint Reduction 03/17/22


Tree Removal Updates 05/03/23

Reduce Site Scope 01/24/24

"WONDER TREE TIES" SHALL BE INSTALLED AT ONE HEIGHT. PROPER HEIGHT IS 6-INCHES ABOVE POINT WHERE TREE WILL SNAP TO UPRIGHT POSITION BY ITSELF IF TOP IS PULLED TO ONE SIDE AS IF WIND LOADED AND RELEASED. STAPLE TREE TIE WIRE TO POST TO PREVENT TIE FROM SLIPPING

> JOB NUMBER: DRAWN BY: **CHECKED BY** SCALE: AS NOTED

PLANTING DETAILS

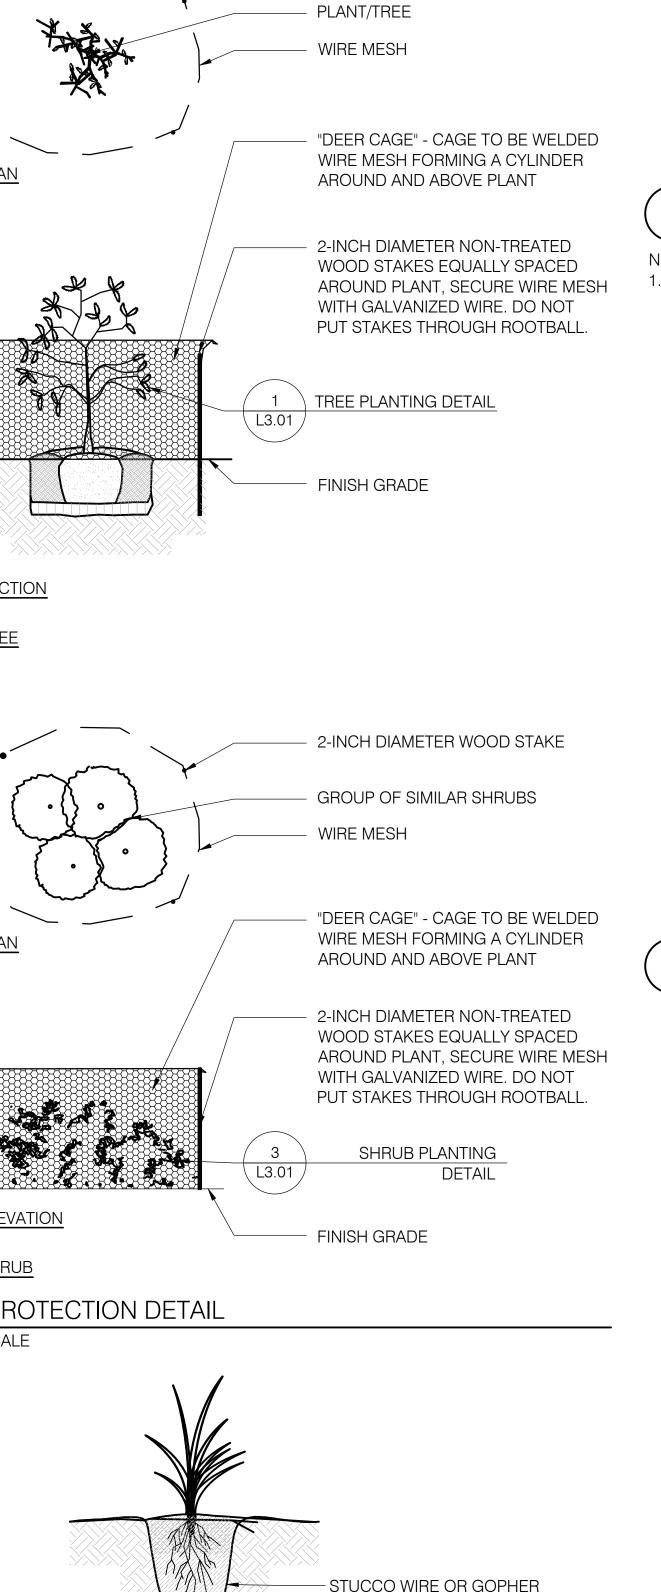

NOTE:


1. CONTRACTOR TO SUBMIT TREE

PLANTS TO BE PROTECTED FROM DEER AND RODENTS.

2-INCH DIAMETER WOOD STAKE

AND SHRUB PROTECTION PLAN FOR REVIEW AND APPROVED BY

OWNER'S REPRESENTATIVE. ALL

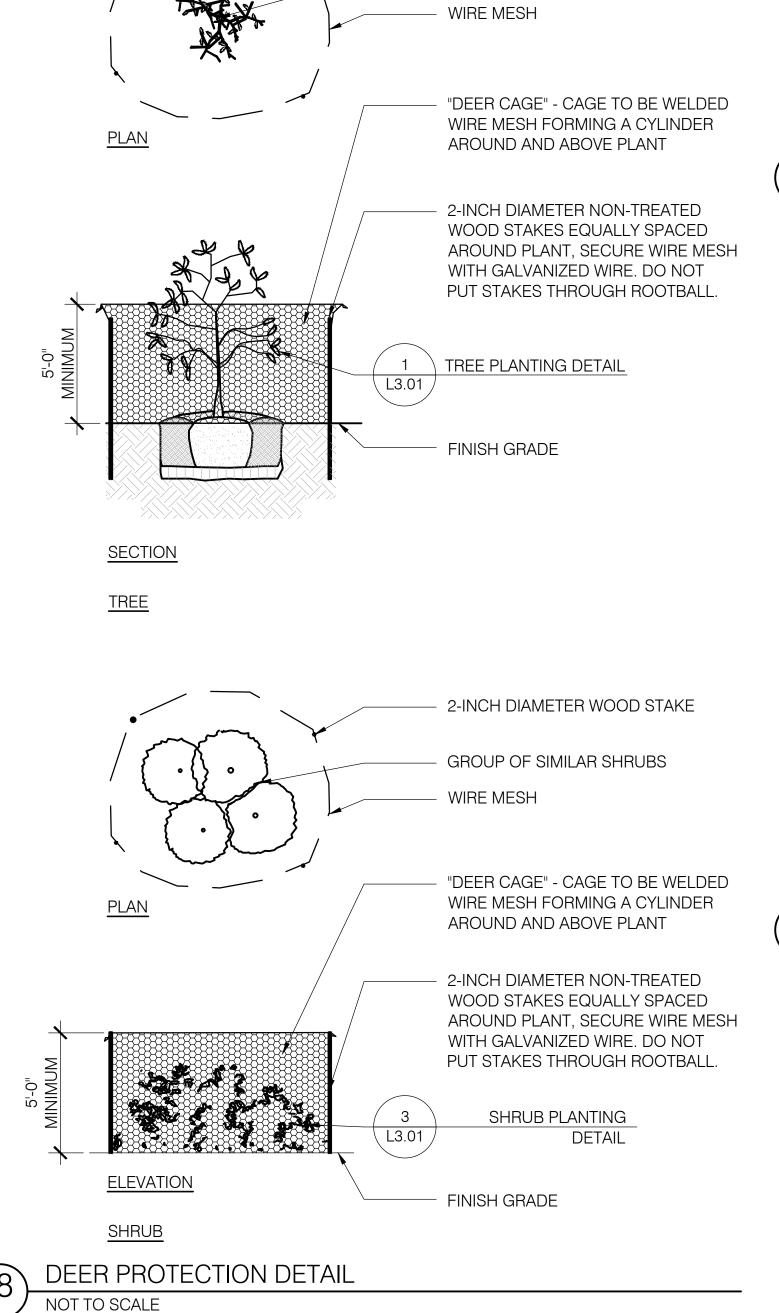

DEER PROTECTION DETAIL

1. WIND GUARDS ARE TO REMAIN

DIRECTION OF PREVAILING WIND

TREE, REFER TO PLANTING PLAN

WOOD BOARD AND BURLAP FABRIC

(4) PINE STAKES SET 3'-0" TO 4'-0"

TREE, REFER TO PLANTING PLAN

- 1X4 WOOD BOARD SCREWED TO

(4) 10'-0" X 2" DIAMETER PEELER

GRADE OR UNDISTURBED

SUBGRADE TO SECURE WIND

CORE STAKES. DO NOT PUT STAKES

BURLAP FABRIC SECURELY STAPLED

1X4 WOOD BOARD SCREWED TO

TO WOOD STAKES - SECTION 32 93 00

THROUGH ROOTBALL. SET INTO

AND DETAIL 1, THIS SHEET

STAKES

PROTECTION.

STAKES

- FINISH GRADE

AWAY FROM TRUNK, TYPICAL

AND DETAIL 1, THIS SHEET

SECURED TO STAKES

4'-0", TYPICAL


ELEVATION

NOT TO SCALE

WIND GUARD DETAIL

AND FULLY ROOTED.

UNTIL TREE IS ESTABLISHED

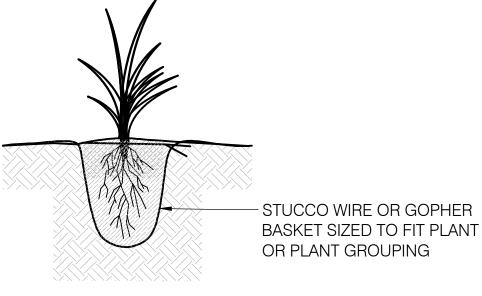

RODENT PROTECTION FOR SHRUBS

SHRUB PLANTING DETAIL NOT TO SCALE

- NATIVE OR IMPORTED SOIL. PIT 2 TIMES SEE NOTE #2 ABOVE. ROOTBALL WIDTH

TREE PLANTING DETAIL NOT TO SCALE

PREVAILING WIND

10'-0" X 2" DIAMETER LODGE POLE — STAKES. DO NOT PUT STAKES THROUGH ROOTBALL. SET INTO GRADE OR UNDISTURBED SUBGRADE BELOW ROOTBALL MINIMUM 12-INCHES -SECTION 32 93 00 FINISH GRADE -

SET TOP OF ROOT COLLAR 2-INCHES ABOVE FINISH GRADE

SECTION 32 93 00

3-INCH LAYER OF MULCH, HOLD 3-INCHES CLEAR OF TRUNK 6-INCH HIGH TEMPORARY WATERING

BASIN AT EDGE OF ROOTBALL FERTILIZER TABLET -SECTION 32 91 13 BACKFILL MIX -

SECTION 32 91 13 SCARIFY AND TAMP NATIVE SOIL UNDER ROOTBALL

NATIVE OR IMPORTED SOIL, SEE NOTE #10 ABOVE.

OAKLAND, CA 94612

www.pyatok.com

MIDPEN HOUSING

Foster City, CA 94404

510.465.7010 p | 510.465.8575 f

303 Vintage Park Drive, Suite 250

JONI L. JANECKI

515 SWIFT ST. SANTA CRUZ CA 95060

PHONE 831.423.6040 | WWW.JLJA.COM

California Landscape Architect License 3163

LINOMWO

C

POIN

& ASSOCIATES

STAMP:

IRRIGATION NOTES

1. THE IRRIGATION SYSTEM, IN COMPLIANCE WITH STATE AND LOCAL WATER EFFICIENT LANDSCAPE ORDINANCES, WILL BE DESIGNED TO APPLY THE MINIMUM AMOUNT OF WATER REQUIRED TO MAINTAIN GOOD PLANT HEALTH. TO ACCOMPLISH THIS, THE SYSTEM WILL INCLUDE AN AUTOMATIC WEATHER-BASED CONTROLLER, RAIN SHUT-OFF DEVICE, MASTER CONTROL VALVE, FLOW SENSOR, MATCHED PRECIPITATION RATE SPRINKLER HEADS, ROTORS, BUBBLERS, OR DRIP EMITTERS, A PROPER SETBACK FROM NON-PERMEABLE SURFACES, AND SEPARATE SOLENOID CONTROL VALVES FOR DIFFERENT HYDROZONES (PLANT WATER USE LEVELS); IT WILL BE DESIGNED TO PREVENT RUNOFF AND OVERSPRAY. THE IRRIGATION SYSTEM WILL INCLUDE WATERING SCHEDULES BASED ON LOCAL EVAPOTRANSPIRATION DATA TAKEN FROM CIMIS AND WILL BE REGULATED BY THE AUTOMATIC IRRIGATION CONTROLLER.

PLANTING NOTES

- 1. CONTRACTOR SHALL PROCURE PLANT SPECIES WITHIN THIRTY (30) DAYS OF AWARD OF THE CONTRACT. CONTRACTOR SHALL BE RESPONSIBLE FOR PLACING REQUIRED DEPOSITS TO ENSURE TIMELY PROCUREMENT OF THE SPECIFIED PLANTS. CONTRACTOR SHALL PROVIDE OWNER'S REPRESENTATIVE WITH WRITTEN VERIFICATION (RECEIPTS) SHOWING PROCUREMENT TO MEET THE PLANTING REQUIREMENTS. CONTRACTOR TO SUBMIT PHOTOGRAPHS OF ALL PLANTS FOR REVIEW AND APPROVAL BY OWNER'S REPRESENTATIVE. PLANTS MAY NEED TO BE CONTRACT GROWN TO ENSURE PLANT AVAILABILITY.
- 2. ALL EXISTING TREES TO REMAIN SHALL BE PROTECTED IN PLACE UNLESS NOTED OTHERWISE. CONTRACTOR SHALL BE RESPONSIBLE FOR DAMAGE OF ANY KIND TO EXISTING TREES DURING THE COURSE OF CONSTRUCTION.
- 3. HOLD FINISHED GRADES FOR SHRUB AREAS 1 1/2 INCHES BELOW TOP OF ADJACENT PAVEMENT OR WALLS, UNLESS OTHERWISE NOTED ON THE DRAWINGS.
- 4. GRADUALLY ROUND OFF TOPS AND TOES OF ALL PLANTED SLOPES TO PRODUCE A SMOOTH AND NATURAL TRANSITION BETWEEN EXISTING PLANTING, FINISH GRADES, AND NEW PLANTING.
- 5. CONTRACTOR SHALL NOTIFY OWNER'S REPRESENTATIVE A MINIMUM OF FIVE (5) DAYS IN ADVANCE TO SCHEDULE PLANT DELIVERY DATES. OWNER'S REPRESENTATIVE SHALL INSPECT PLANTS UPON ARRIVAL AND RESERVES THE RIGHT TO REJECT PLANTS.
- 6. CONTRACTOR SHALL PLACE PLANTS AS SHOWN ON PLAN AND VERIFY LOCATION WITH OWNER'S REPRESENTATIVE. OWNER'S REPRESENTATIVE MAY REQUEST THAT CONTRACTOR ADJUST OR RELOCATE PLANTS ON-SITE AS NEEDED TO PROPERLY COMPLETE DESIGN.
- 7. CONTRACTOR TO PROTECT ALL NEW PLANTS FROM GOPHERS, RODENTS, DEER, AND OTHER ANIMALS. TYPE AND EXTENT OF PROTECTION MEASURES SHALL BE DETERMINED BY CONTRACTOR AND SUBMITTED TO OWNER'S REPRESENTATIVE FOR REVIEW AND APPROVAL PRIOR TO INSTALLATION.
- 8. TYPICAL OF ALL TREES KEEP ALL SHRUBS, GRASSES, PERENNIALS, GROUNDCOVER, VINES, OR SUCCULENTS PLANTINGS 18 INCHES CLEAR FROM ANY EXISTING OR NEW TREE TRUNK.
- 9. IF SOIL IS LIME TREATED, PLANTING AREAS TO BE EXCAVATED WITHIN 3 INCHES OF THE EDGE OF PAVING/CURB TO A DEPTH OF MINIMUM 18 INCHES AND DISPOSED OF OFF-SITE. PLANTING AREAS TO BE FILLED WITH IMPORTED TOPSOIL AMENDED PER SOILS REPORT. PLANTING AREAS TO BE TESTED FOR PROPER DRAINAGE PRIOR TO PLANTING.
- 10. COMPACTED SOILS MUST BE TRANSFORMED TO A FRIABLE CONDITION TO MAXIMIZE WATER RETENTION.
- 11. INCORPORATE COMPOST INTO THE SOIL TO A MINIMUM OF 8 INCHES AT A MINIMUM RATE OF 6 CUBIC YARDS PER 1000 SQUARE FEET. SOILS WITH GREATER THAN 6% ORGANIC MATTER IN THE TOP 6 INCHES OF SOIL ARE EXEMPT FROM ADDING COMPOST AND TILLING.
- 12. PROVIDE A MINIMUM OF 3 INCHES OF WOOD CHIP MULCH TO SOIL SURFACE AFTER PLANTING, AROUND EXISTING TREES AND SHRUBS TO REMAIN. MULCH SHALL NOT BE PLACED WITHIN A 12-INCH DIAMETER OF TREE TRUNKS AND SHOULD BE KEPT FREE FROM THE CROWN OF ALL SHRUBS, GRASSES, AND PERENNIALS. DO NOT MULCH SEEDED AREAS. MULCH FOR RAIN GARDENS SHALL BE NON-FLOATING, AS ACCEPTED BY LANDSCAPE ARCHITECT. MULCH FOR ALL OTHER PLANTING AREAS SHALL BE 1/2-INCH TO 1-INCH DIAMETER COMPOSTED REDWOOD, FREE OF STICKS, DIRT, AND OTHER DEBRIS, AS ACCEPTED BY LANDSCAPE ARCHITECT.
- 13. SOIL AMENDMENTS MUST BE INCORPORATED ACCORDING TO RECOMMENDATIONS OF THE SOIL ANALYSIS REPORT AND WHAT IS APPROPRIATE FOR THE PLANTS SELECTED.
- 14. CONTRACTOR TO REVIEW ALL PLANS AND SPECIFICATIONS FOR SUBMITTALS, TESTING, AND OTHER REQUIREMENTS. CONTRACTOR TO IMMEDIATELY NOTIFY OWNER'S REPRESENTATIVE OF ANY DISCREPANCIES BETWEEN SITE CONDITIONS AND INTENT OF THESE DRAWINGS. ANY CONFLICTS WILL BE RESOLVED PRIOR TO COMPLETING WORK.

PLANT LIST

ENTRY TREE - 15 GALLON

- LAGUNARIA PATERSONIA (PYRAMID TREE)
- LOPHOSTEMON CONFERTUS (BRISBANE BOX) MAGNOLIA 'LITTLE GEM' (DWARF SOUTHERN MAGNOLIA)
- PISTACIA CHINENSIS (CHINESE PISTACHE)
- QUERCUS RUBRA (NORTHERN RED OAK)
- PARKING LOT SHADE TREE 15 GALLON LOPHOSTEMON CONFERTUS (BRISBANE BOX)

- BUILDING ENTRY TREE 15 GALLON
- CERCIS CANADENSIS 'FOREST PANSY'
- GEIJERA PARVIFLORA (AUSTRALIAN WILLOW) LAGERSTROEMIA INDICA 'NATCHEZ' (CRAPE MYRTLE)
- LAURUS 'SARATOGA' (SARATOGA LAUREL)

NATIVE TREE - 15 GALLON QUERCUS AGRIFOLIA (COAST LIVE OAK)

ACCENT TREE - 15 GALLON

• CERCIS CANADENSIS 'FOREST PANSY' (EASTERN REDBUD)

- EVERGREEN SCREENING MIX OF 15, 5, AND 1 GALLONS
- CEANOTHUS THYRSIFLORUS (BLUE BLOSSOM)
- GARRYA ELLIPTICA (COAST SILKTASSEL) HESPEROCYPARIS MACROCARPA (MONTEREY CYPRESS)
- HETEROMELES ARBUTIFOLIA (TOYON)
- RHUS INTEGRIFOLIA (LEMONADE BERRY)

GROUNDCOVER AND SHRUBS - MIX OF 1 AND 5 GALLONS

- ACHILLEA MILLEFOLIUM (YARROW)
- ARCTOSTAPHYLOS PAJAROENSIS (PAJARO MANZANITA)
- ARTEMISIA PYCNOCEPHALA 'DAVID'S CHOICE' (COASTAL SAGEWORT) BACCHARIS PILULARIS (COYOTE BRUSH)
- CALAMAGROSTIS NUTKAENSIS (PACIFIC REED GRASS)
- CEANOTHUS THYRSIFLORUS (BLUE BLOSSOM) ERIGERON GLAUCUS (BEACH DAISY)
- ERIOPHYLLUM STAECHADIFOLIUM (LIZARD-TAIL)
- GARRYA ELLIPTICA (COAST SILKTASSEL)
- GRINDELIA STRICTA VAR. PLATYPHYLLA 'RAY'S CARPET' (COASTAL GUM PLANT) HETEROMELES ARBUTIFOLIA (TOYON)
- RHUS INTEGRIFOLIA (LEMONADE BERRY)
- RIBES SANGUINEUM (RED FLOWERING CURRANT)
- SATUREJA DOUGLASII (YERBA BUENA)

DETENTION BASINS - MIX OF 1 AND 5 GALLONS

- CAREX PANSA (SANDDUNE SEDGE) CORNUS STOLONIFERA (RED STEM DOGWOOD)
- ELYMUS CONDENSATUS (GIANT WILD RYE)
- ELYMUS GLAUCUS (BLUE WILDRYE)
- IRIS DOUGLASIANA (DOUGLAS IRIS)

SLOPE PLANTING - SEED

 FESTUCA RUBRA (RED FESCUE) 95% • ESCHSCHOLZIA CALIFORNICA (CALIFORNIA POPPY) 5% OAKLAND, CA 94612

510.465.7010 p | 510.465.8575 f www.pyatok.com

MIDPEN HOUSING

303 Vintage Park Drive, Suite 250 Foster City, CA 94404

JONI L. JANECKI

& ASSOCIATES

515 SWIFT ST. SANTA CRUZ CA 95060 PHONE 831.423.6040 | WWW.JLJA.COM California Landscape Architect License 3163

LINOMMO

 \geq


STAMP:

REVISION SCHEDULE

Tree Removal Updates 05/03/23
Reduce Site Scope 01/24/24

JOB NUMBER:

PLANT LIST, IRRIGATION AND PLANTING NOTES

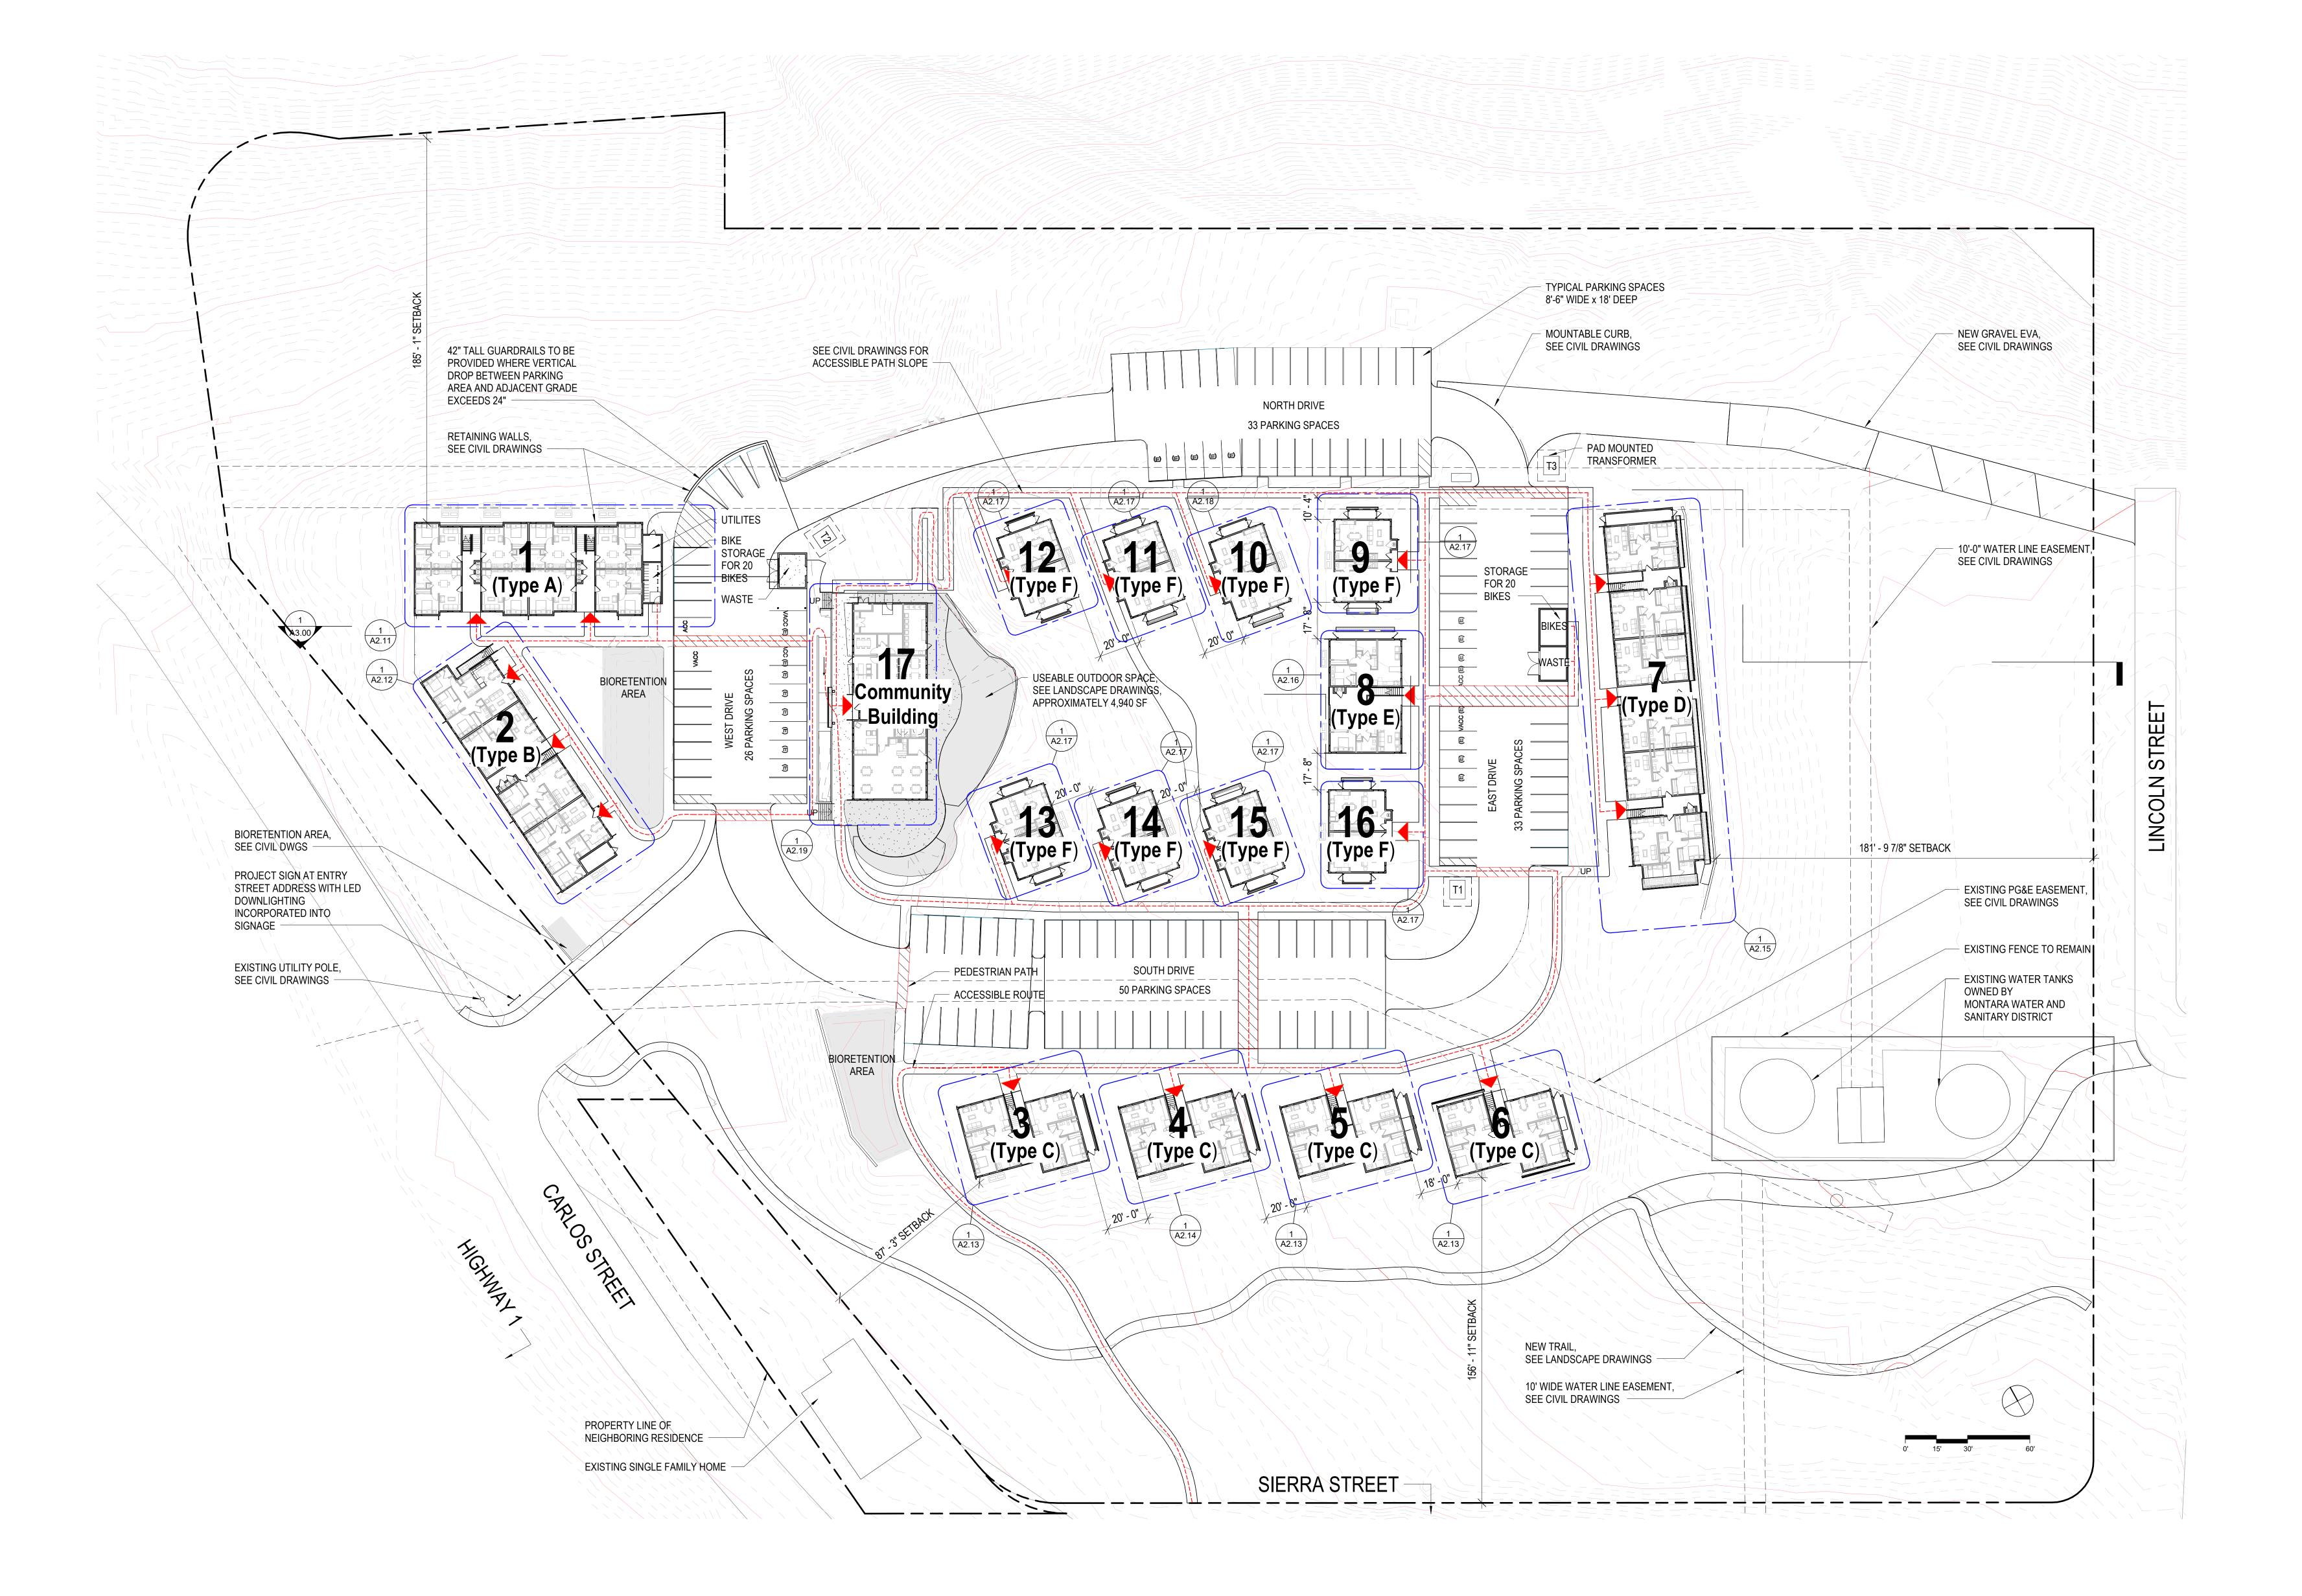

OVERALL SITE PLAN
1" = 30'-0"

PYATOK

1611 TELEGRAPH AVE. SUITE 200
OAKLAND, CA 94612

510.465.7010 p | 510.465.8575 f www.pyatok.com

MidPen Housing

MIDPEN HOUSING 303 Vintage Park Drive Suite 250 Foster City, CA 94404

ESS POINT FAMILY COMMUNITY

STAMP:

0

REVISION SCHEDULE


NO. ISSUE

1 Planning Resubmittal 03/25/19
2 Adjusted Heights 07/10/20
3 Coastal Development Permit 06/21/22
4 CDP Resubmittal 12/01/23

JOB NUMBER: 1603
DRAWN BY: GP/SC
CHECKED BY: PW
DATE: January 24, 2024
SCALE: 1" = 30'-0"
TITLE:

OVERALL SITE PLAN

A1.00

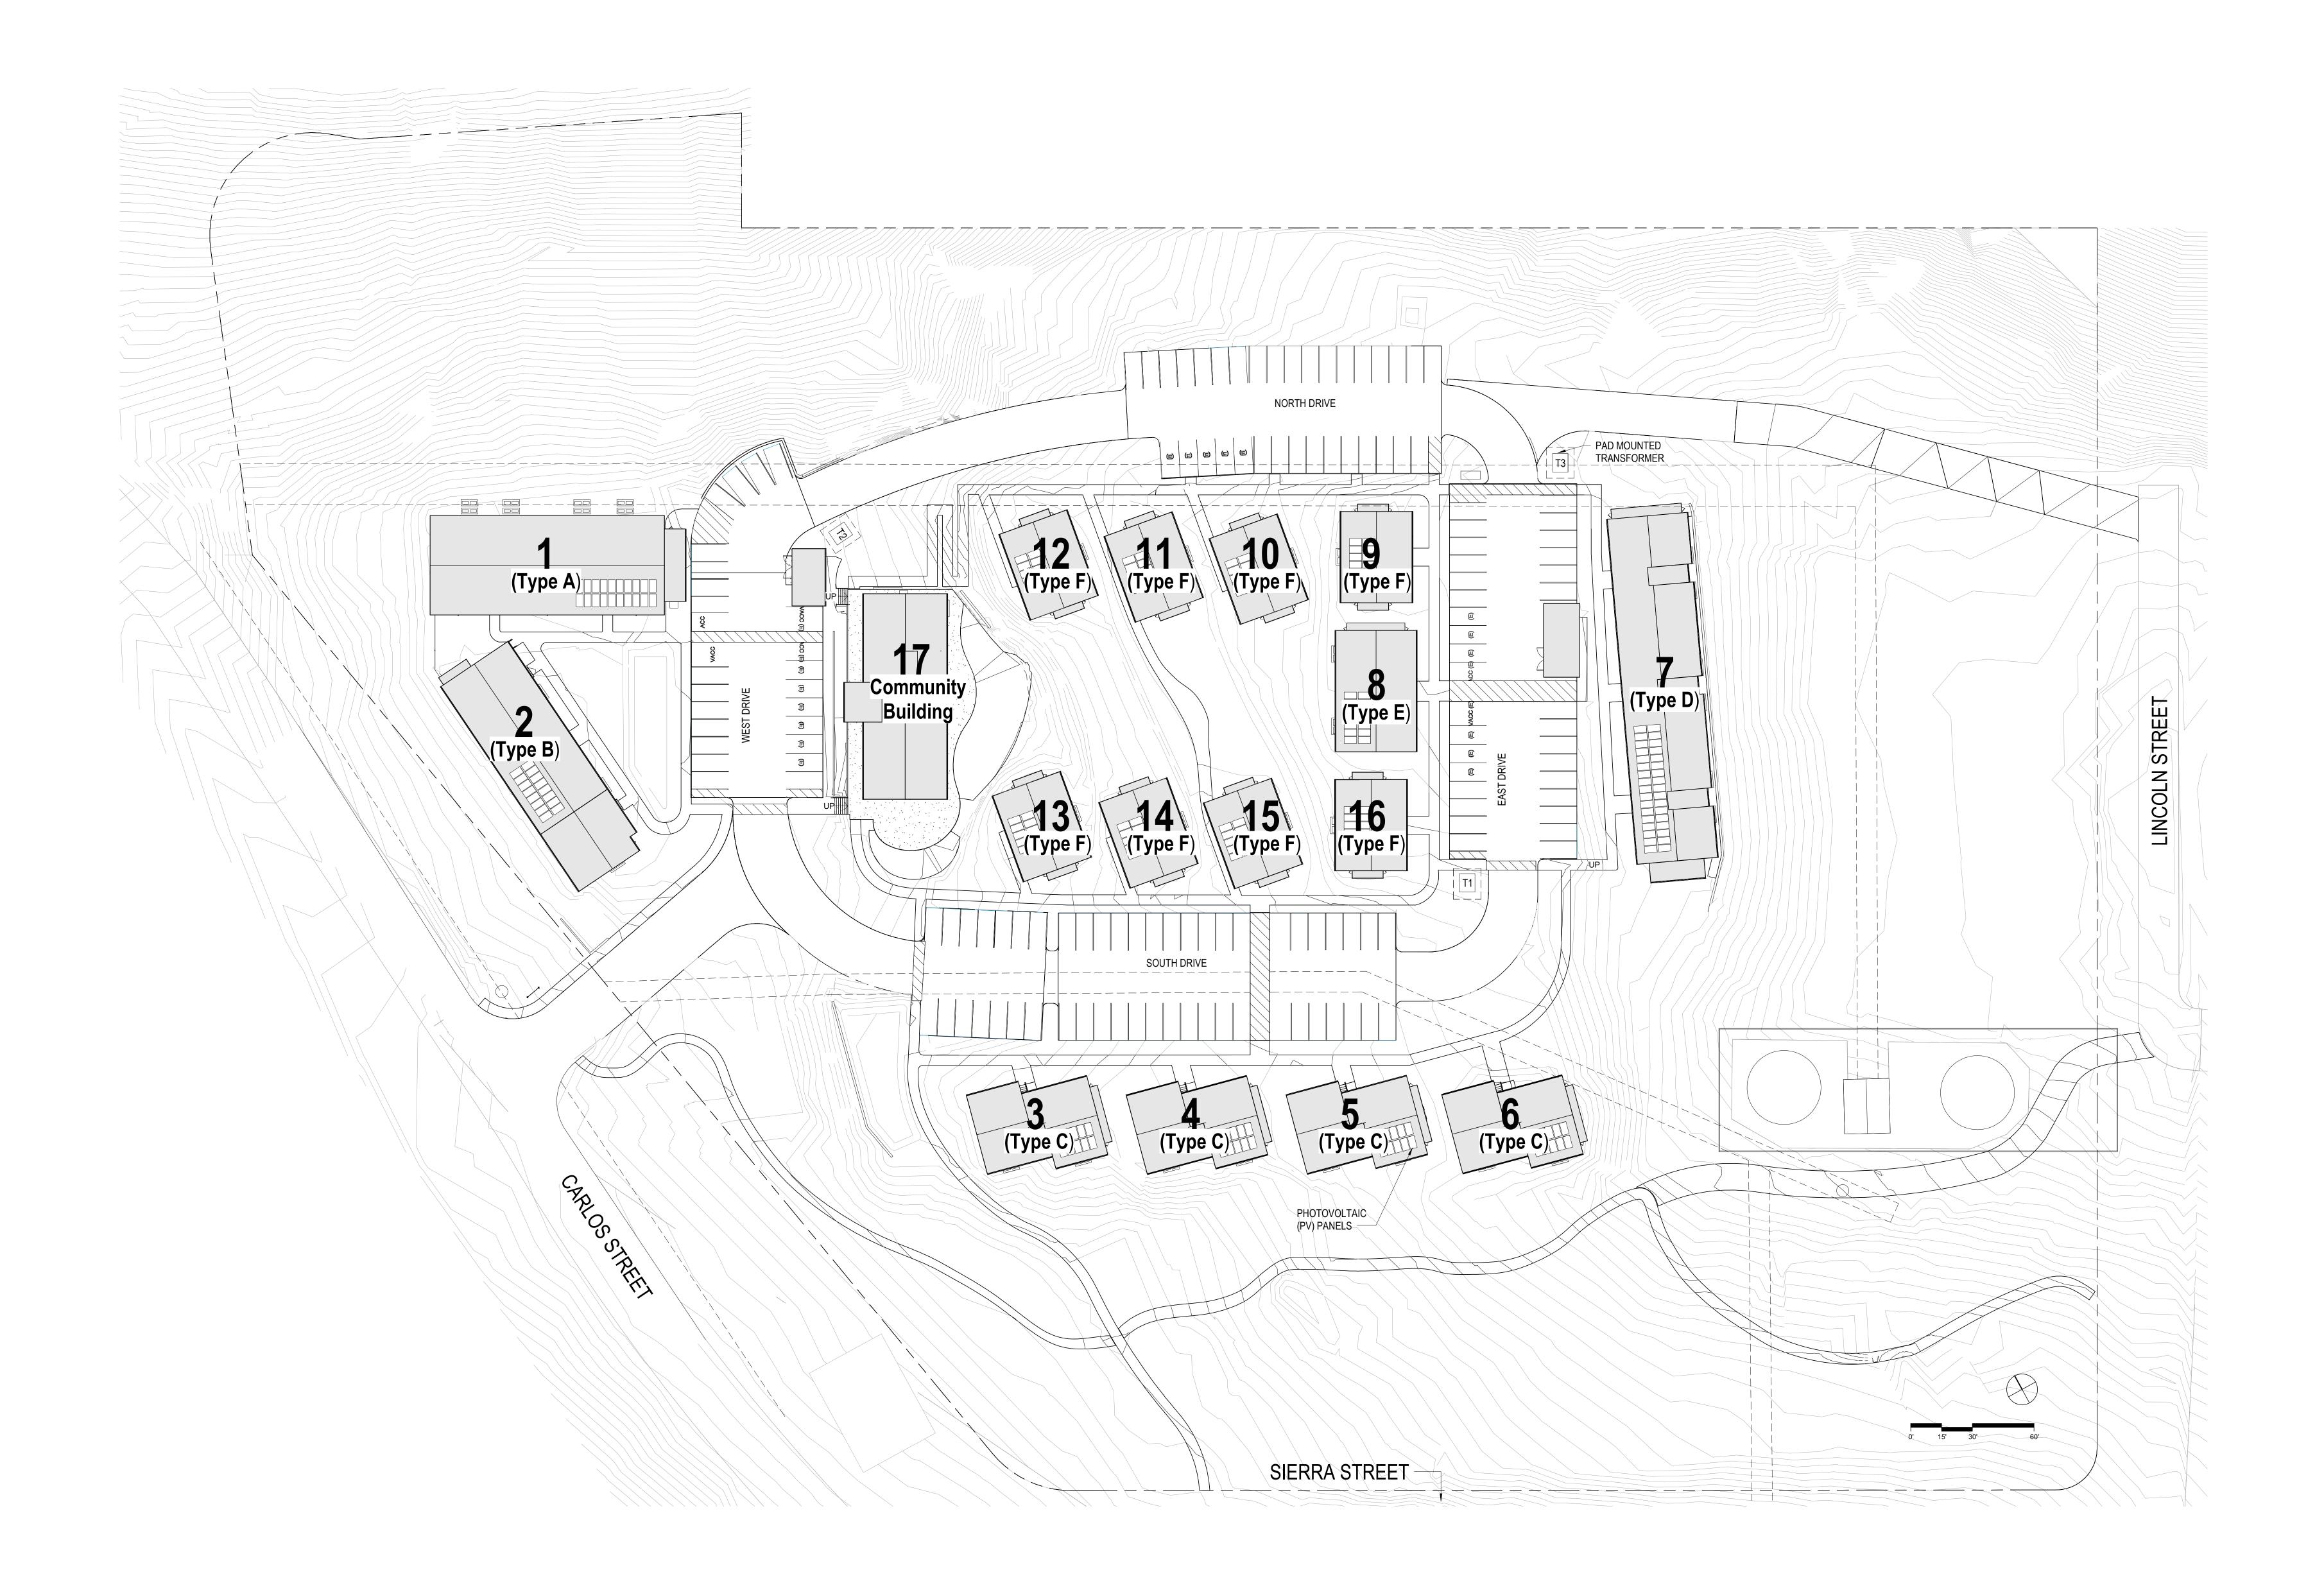

ROOF PLAN 1" = 30'-0" PYATOK

1611 TELEGRAPH AVE. SUITE 200
OAKLAND, CA 94612

OAKLAND, CA 94612 510.465.7010 p | 510.465.8575 f www.pyatok.com

MidPen Housing

MIDPEN HOUSING 303 Vintage Park Drive Suite 250 Foster City, CA 94404

CYPRESS POINT FAMILY COMMUNITY

STAMP:

REVISION SCHEDULE


NO. ISSUE

1 Planning Resubmittal 03/25/19
2 Adjusted Heights 07/10/20
3 Coastal Development Permit 06/21/22
4 CDP Resubmittal 12/01/23

JOB NUMBER: 1603
DRAWN BY: GP/SC
CHECKED BY: PW
DATE: January 24, 2024
SCALE: 1" = 30'-0"

OVERALL SITE ROOF PLANS

SHEET: **A1.01**

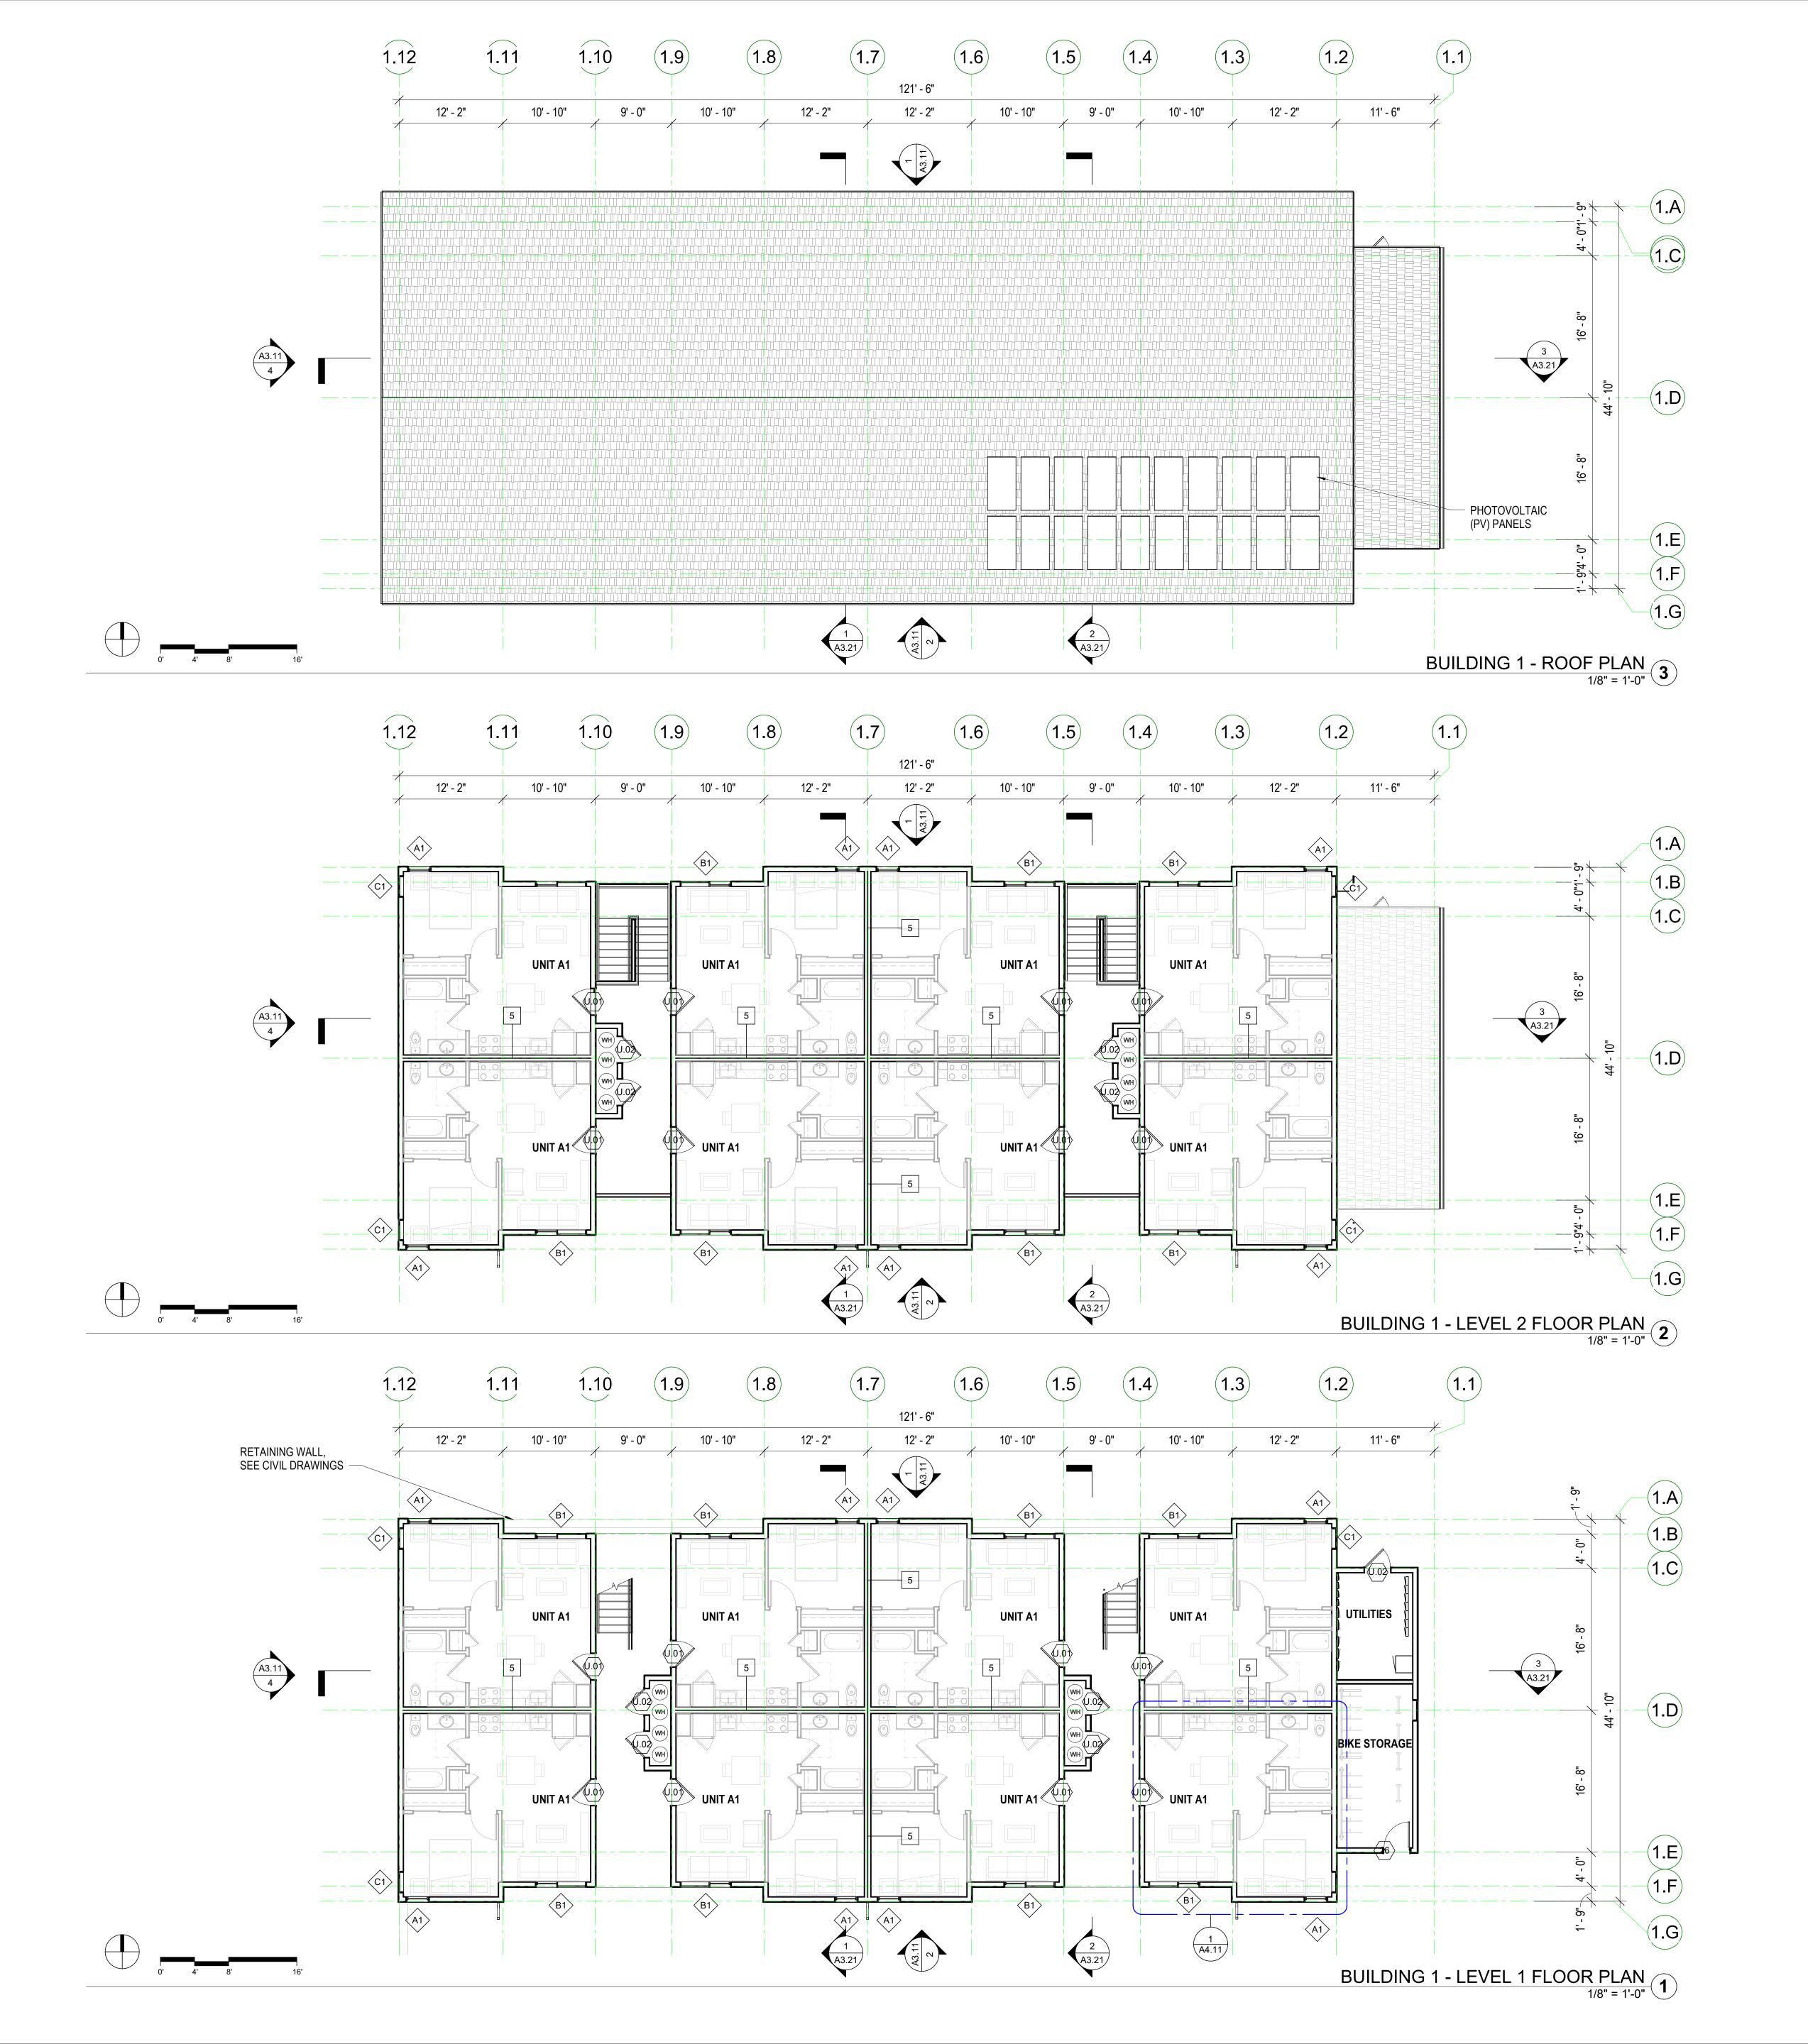

FLOOR PLAN GEN. NOTES

- SEE SHEET G0.00 FOR SYMBOLS & ABBREVIATIONS
 THESE PLANS SHOW UNIQUE INFORMATION ONLY. SEE
- 2. THESE PLANS SHOW UNIQUE INFORMATION ONLY. SEE ENLARGED PLANS FOR INFORMATION NOT SHOWN.
 3. REFERENCE ACCESSIBILITY CODE SHEETS GO.XX FOR ALL ACCESSIBILITY STANDARDS, REQUIREMENTS AND
- DIAGRAMS

 4. SEE CIVIL PLANS FOR THE BUILDING LOCATION ON SITE AND
- FOR PARKING TABULATION REFER TO SHEET G0.XX.
 ALL DIMENSIONS ARE TO FACE OF MASONRY, CONCRETE, STUD, OR CENTERLINE OF COLUMN OR DEMISING WALL (C.L.). U.O.N. ALL "CLEAR" DIMENSIONS ARE TO FACE OF

PRECISE GRADING PLANS.

- 7. ALL CONSTRUCTION TO BE FIRE-RATED PER THE PROJECT DATA ON THE **G0.XX** SHEETS AND ASSEMBLIES, SHEETS **A9.X.** UNIT DEMISING WALLS ARE 1-HR RATED, TYPICAL. FOR DETAILED LOCATION OF WALL ASSEMBLY TYPES, SEE ENLARGED PLANS.
- 8. ALL STAIR, ELEVATOR, TRASH CHUTE, AND VENTILATION SHAFTS TO BE 2-HR FIRE RATED BARRIERS IF CONNECTING MORE THAN 3 STORIES. IF LESS THAN 3 STORIES, THESE MUST BE 1-HR FIRE-RATED CONSTRUCTION.


 9. FOR DETAIL LOCATION OF WALL ASSEMBLY TYPES, SEE
- BUILDING AND UNIT FLOOR PLANS, SHEETS A2.X, A4.X, & A8X. FOR WALL, FLOOR, FLOOR/CEILING, AND ROOF/CEILING ASSEMBLY TYPES, SEE SHEETS A9.X.

 10. WHERE PROVIDED, CMU PARTITION WALLS TO RECEIVE REINFORCING PER STRUCTURAL DRAWINGS AND
- REINFORCING PER STRUCTURAL DRAWINGS AND
 TERMINATE AT STRUCTURE ABOVE, U.O.N.
 11. ALL INTERIOR EXPOSED CONCRETE WITHIN PUBLIC SPACES
- IS ARCHITECTURAL FINISH, U.O.N.


 12. STUD SIZES TYPICALLY USED THROUGHOUT PROJECT ARE SHOWN REFER TO STUD SIZE ON WALL ASSEMBLIES, SHEET A9.X, FOR REQUIRED SIZES, GAUGES AND SPACING REQUIRED. COORDINATE BLOCKING AND BRACING REQURIEMENTS FOR ALL WALL-HUNT ITEMS AND VERIFY LOCATIONS PRIOR TO INSTALLATION OF FINISHES.
- 13. THIS BUILDING TO BE FIRE SPRINKLERED PER APPLICABLE SECTIONS OF CBC CHAPTER 9 AND NFPA 13.14. CLASS 1 STANDPIPES TO BE INTERCONNECTED.
- 15. PROVIDE ALL NECESSARY WALL ACCESS PANELS AS REQUIRED FOR MECHANICAL, PLUMBING, FIRE SPRINKLER AND ELECTRICAL SYSTEMS. IN FIRE RATED ASSEMBLIES PROVIDE RATED ACCESS PANELS WITH SELF CLOSING DEVICES.
- 16. SEE INDIVIDUAL UNIT FLOOR PLANS OR ENLARGED BUILDING PLANS FOR DETAILED INFORMATION ON DIMENSIONS, CONSTRUCTION, DOORS, WINDOWS, AND OTHER ELEMENTS,
- 17. INTERIOR FINISHES SHALL COMPLY WITH <u>CBC 803.1</u> FLAME SPREAD PROVISION, SEE INTERIOR DRAWINGS.
 18. FOR DOOR & WINDOW SCHEDULES SEE SHEET A9.X & A9.X.
- 19. RAMP SLOPES ARE MEASURED FROM CENTERLINE OF RAMP.
 20. ALL <u>EXIT</u> STAIRS TO COMPLY WITH **CBC CHAPTERS 10, 11A AND/OR 11B**. EXIT STAIRS AND LANDINGS TO BE 44 INCHES MINIMUM IN WIDTH, STAIR RISERS TO BE MAXIMUM 7 INCHES HIGH, AND TREADS TO BE 11 INCHES MINIMUM DEEP.
- 21. SEE ROOF PLAN GENERAL NOTES FOR DRAINAGE, VENTILATION, AND ROOF ACCESS NOTES.
- 22. ALL RESIDENTIAL UNITS THAT FACE ROADS ARE EQUIPPED WITH EITHER MECHANICAL VENTILATION OR PASSIVE FRESH-AIR INLETS, SEE MECHANICAL DRAWINGS FOR MORE INFORMATION.
- 23. SEE SIGNAGE PLANS AND DETAILS ON **A10.X** FOR ADDITIONAL INFORMATION REGARDING SIGNS AT UNIT ENTRIES, ELEVATORS, STAIRS, EGRESS COMPONENTS, COMMON AREA DOORS.

FLOOR PLAN KEY

SEE GRAPHIC SYMBOLS LEGEND ON COVER SHEET FOR

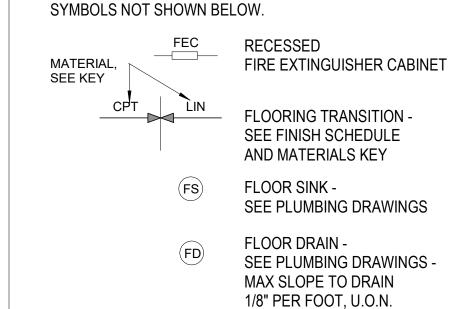


2 HOUR RATED WALLS

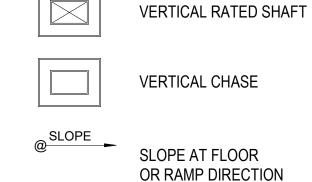

KEYNOTE LEGEND

NUMBER KEYNOTE

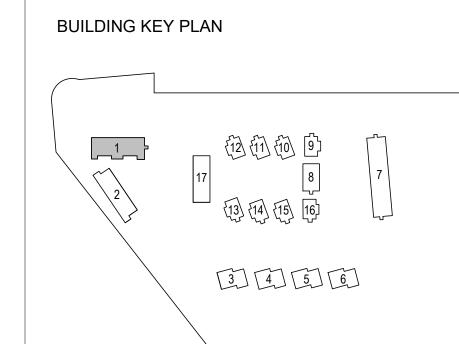

JOB NUMBER: 1603
DRAWN BY: GP/SC
CHECKED BY: PW
DATE: January 24, 2024
SCALE: As indicated

FLOOR & ROOF PLANS -BUILDING TYPE A (BUILDING 1)

A2.11

© 2023 PYATOK ARCHITECTURE & URBAN DESIGN

PYATO

OAKLAND, CA 94612

www.pyatok.com

Suite 250

510.465.7010 p | 510.465.8575 f

MidPen H O U S I N G

303 Vintage Park Drive

Foster City, CA 94404

IDMMO

STAMP:

REVISION SCHEDULE

D. ISSUE DATE


Planning Resubmittal 03/25/19

Adjusted Heights 07/10/20

Coastal Development Permit 06/21/22

CDP Resubmittal 12/01/23

MIDPEN HOUSING

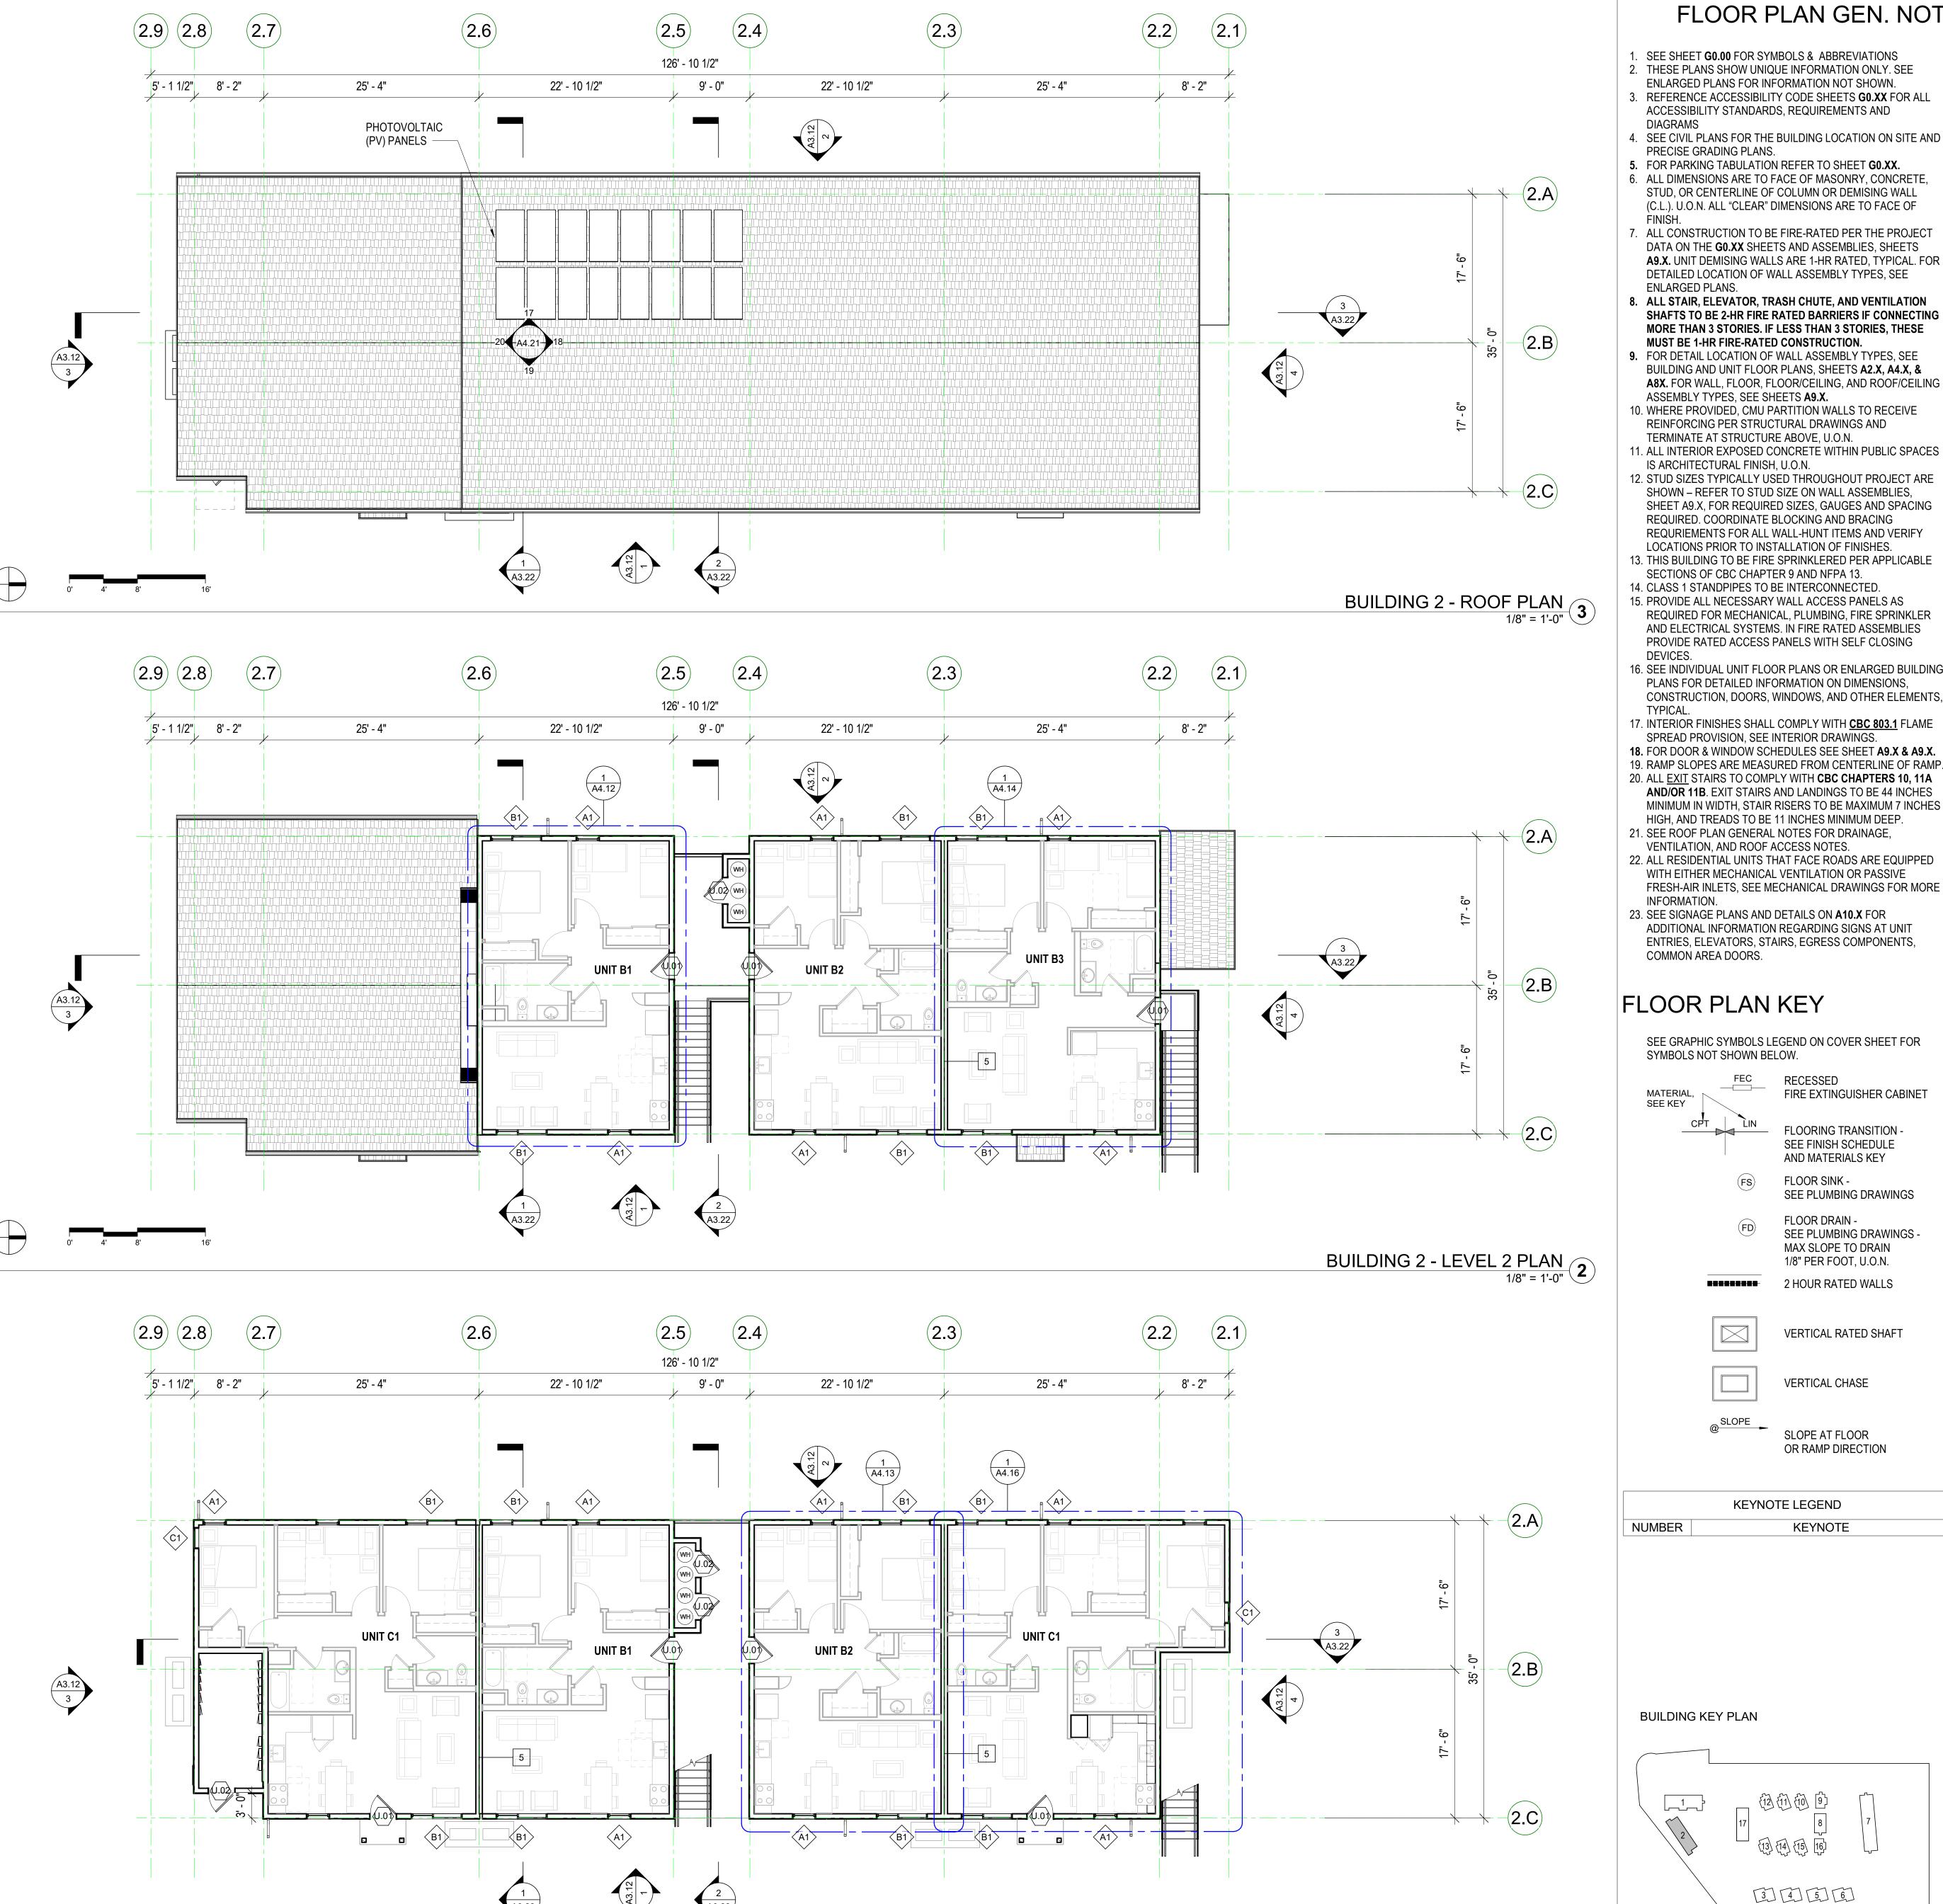

FLOOR PLAN GEN. NOTE PYATOK

OAKLAND, CA 94612

www.pyatok.com

Suite 250

510.465.7010 p | 510.465.8575 f

MidPen H O U S I N G

MIDPEN HOUSING

303 Vintage Park Drive

Foster City, CA 94404

INOMMO

<

Щ

REVISION SCHEDULE

 D. ISSUE
 DATE

 Planning Resubmittal
 03/25/19

 Adjusted Heights
 07/10/20

 Coastal Development Permit
 06/21/22

 CDP Resubmittal
 12/01/23

STAMP:

1. SEE SHEET G0.00 FOR SYMBOLS & ABBREVIATIONS 2. THESE PLANS SHOW UNIQUE INFORMATION ONLY. SEE ENLARGED PLANS FOR INFORMATION NOT SHOWN.

3. REFERENCE ACCESSIBILITY CODE SHEETS **G0.XX** FOR ALL ACCESSIBILITY STANDARDS, REQUIREMENTS AND

4. SEE CIVIL PLANS FOR THE BUILDING LOCATION ON SITE AND PRECISE GRADING PLANS.

5. FOR PARKING TABULATION REFER TO SHEET **G0.XX**. 6. ALL DIMENSIONS ARE TO FACE OF MASONRY, CONCRETE STUD, OR CENTERLINE OF COLUMN OR DEMISING WALL (C.L.). U.O.N. ALL "CLEAR" DIMENSIONS ARE TO FACE OF 7. ALL CONSTRUCTION TO BE FIRE-RATED PER THE PROJECT

DATA ON THE **G0.XX** SHEETS AND ASSEMBLIES, SHEETS A9.X. UNIT DEMISING WALLS ARE 1-HR RATED, TYPICAL. FOR DETAILED LOCATION OF WALL ASSEMBLY TYPES, SEE ENLARGED PLANS. 8. ALL STAIR, ELEVATOR, TRASH CHUTE, AND VENTILATION

SHAFTS TO BE 2-HR FIRE RATED BARRIERS IF CONNECTING MORE THAN 3 STORIES. IF LESS THAN 3 STORIES, THESE MUST BE 1-HR FIRE-RATED CONSTRUCTION. 9. FOR DETAIL LOCATION OF WALL ASSEMBLY TYPES, SEE BUILDING AND UNIT FLOOR PLANS, SHEETS A2.X, A4.X, &

A8X. FOR WALL, FLOOR, FLOOR/CEILING, AND ROOF/CEILING ASSEMBLY TYPES, SEE SHEETS A9.X. 10. WHERE PROVIDED, CMU PARTITION WALLS TO RECEIVE REINFORCING PER STRUCTURAL DRAWINGS AND

TERMINATE AT STRUCTURE ABOVE, U.O.N. 11. ALL INTERIOR EXPOSED CONCRETE WITHIN PUBLIC SPACES IS ARCHITECTURAL FINISH, U.O.N.

SHOWN - REFER TO STUD SIZE ON WALL ASSEMBLIES, SHEET A9.X, FOR REQUIRED SIZES, GAUGES AND SPACING REQUIRED. COORDINATE BLOCKING AND BRACING REQURIEMENTS FOR ALL WALL-HUNT ITEMS AND VERIFY

LOCATIONS PRIOR TO INSTALLATION OF FINISHES. 13. THIS BUILDING TO BE FIRE SPRINKLERED PER APPLICABLE SECTIONS OF CBC CHAPTER 9 AND NFPA 13. 14. CLASS 1 STANDPIPES TO BE INTERCONNECTED.

AND ELECTRICAL SYSTEMS. IN FIRE RATED ASSEMBLIES PROVIDE RATED ACCESS PANELS WITH SELF CLOSING 16. SEE INDIVIDUAL UNIT FLOOR PLANS OR ENLARGED BUILDING PLANS FOR DETAILED INFORMATION ON DIMENSIONS,

CONSTRUCTION, DOORS, WINDOWS, AND OTHER ELEMENTS, 17. INTERIOR FINISHES SHALL COMPLY WITH **CBC 803.1** FLAME

18. FOR DOOR & WINDOW SCHEDULES SEE SHEET A9.X & A9.X. 19. RAMP SLOPES ARE MEASURED FROM CENTERLINE OF RAMP. 20. ALL EXIT STAIRS TO COMPLY WITH CBC CHAPTERS 10, 11A AND/OR 11B. EXIT STAIRS AND LANDINGS TO BE 44 INCHES MINIMUM IN WIDTH, STAIR RISERS TO BE MAXIMUM 7 INCHES

HIGH, AND TREADS TO BE 11 INCHES MINIMUM DEEP. 21. SEE ROOF PLAN GENERAL NOTES FOR DRAINAGE, VENTILATION, AND ROOF ACCESS NOTES. 22. ALL RESIDENTIAL UNITS THAT FACE ROADS ARE EQUIPPED

23. SEE SIGNAGE PLANS AND DETAILS ON A10.X FOR ADDITIONAL INFORMATION REGARDING SIGNS AT UNIT ENTRIES, ELEVATORS, STAIRS, EGRESS COMPONENTS,

FLOOR PLAN KEY

SEE GRAPHIC SYMBOLS LEGEND ON COVER SHEET FOR

SYMBOLS NOT SHOWN BELOW. RECESSED FIRE EXTINGUISHER CABINET FLOORING TRANSITION -SEE FINISH SCHEDULE AND MATERIALS KEY

FLOOR SINK -SEE PLUMBING DRAWINGS

FLOOR DRAIN -SEE PLUMBING DRAWINGS -MAX SLOPE TO DRAIN 1/8" PER FOOT, U.O.N. 2 HOUR RATED WALLS

VERTICAL RATED SHAFT


VERTICAL CHASE

SLOPE AT FLOOR OR RAMP DIRECTION

KEYNOTE LEGEND KEYNOTE


BUILDING KEY PLAN

BUILDING 2 - LEVEL 1 FLOOR PLAN
1/8" = 1'-0"

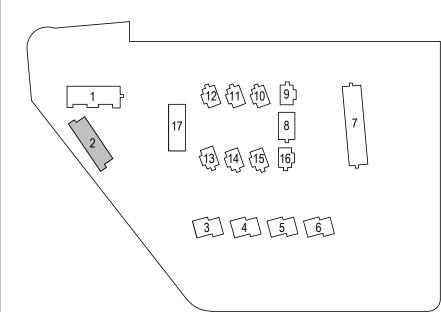

JOB NUMBER: DRAWN BY: CHECKED BY SCALE:


FLOOR & ROOF PLANS -BUILDING TYPE B (BUILDING 2)

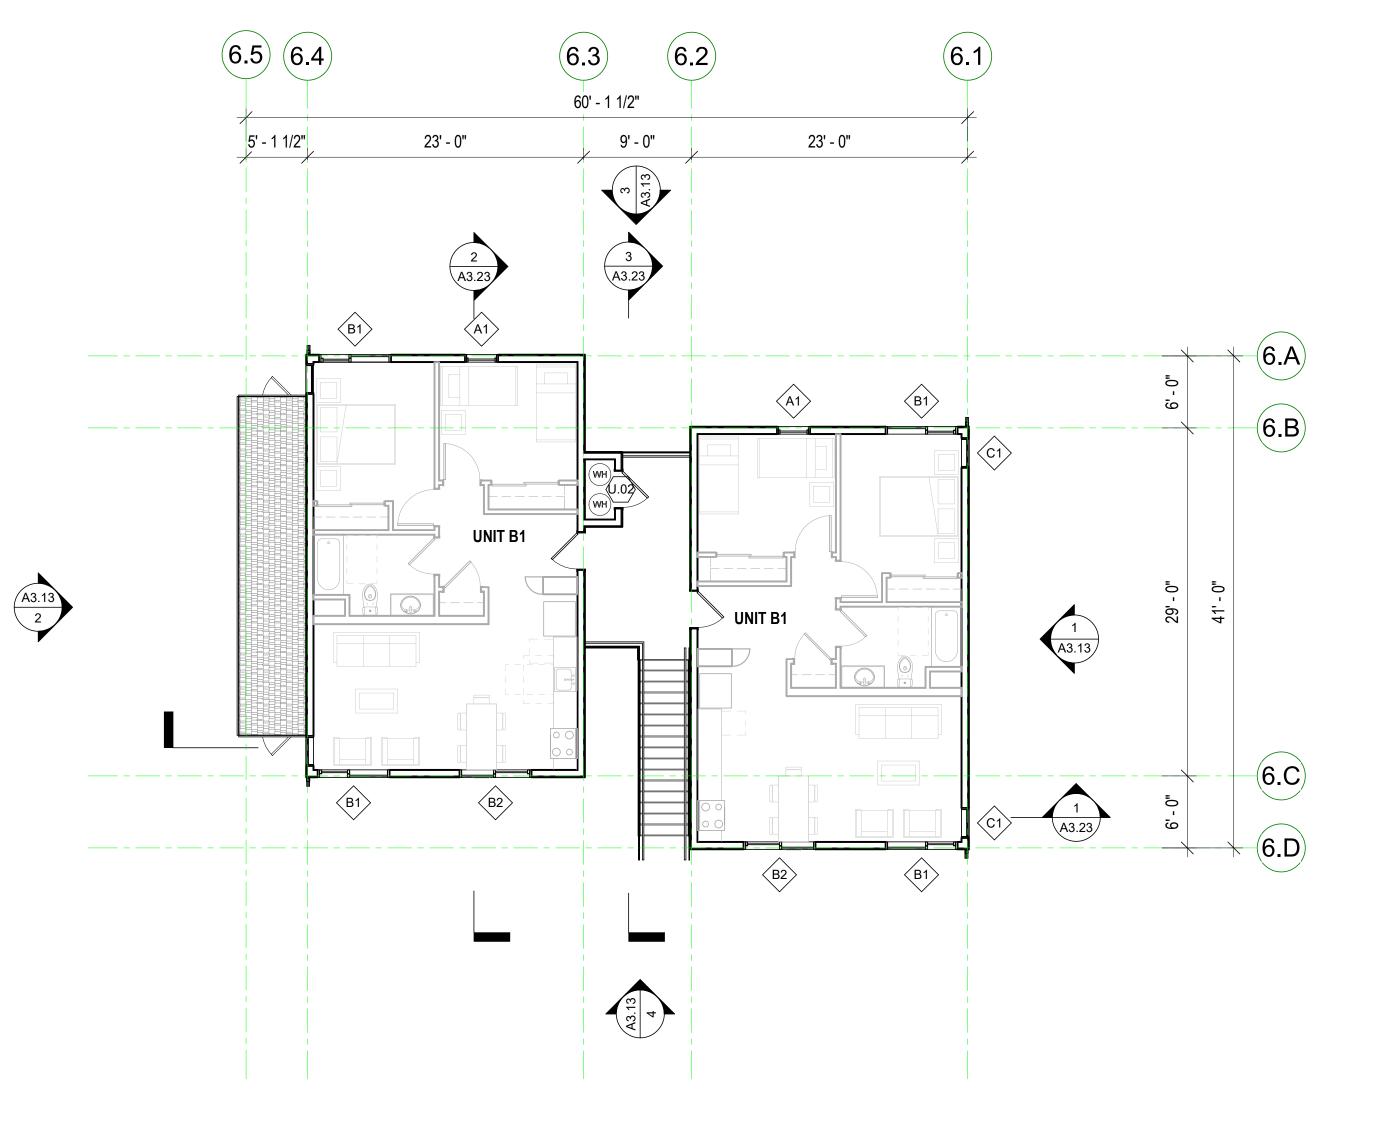


BUILDING 6 - LEVEL 2 FLOOR PLAN (BLDG. 3 & 5 SIM.)

1/8" = 1'-0"

2

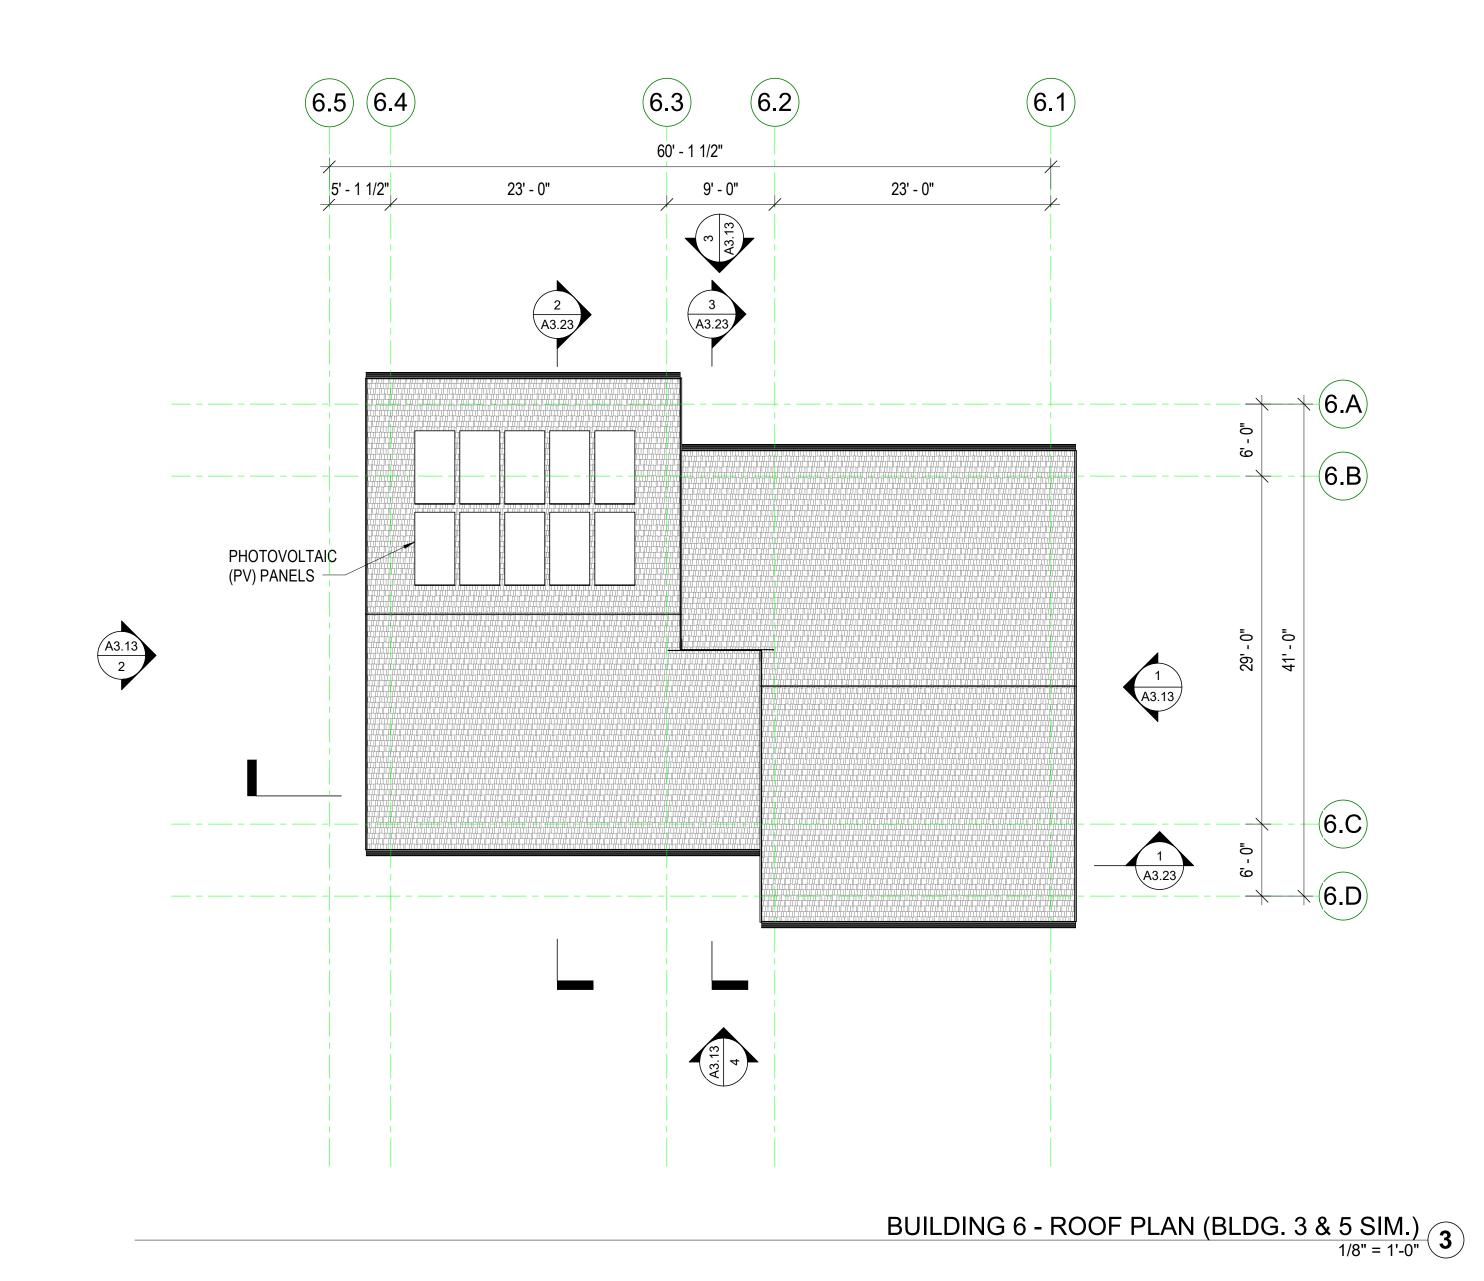

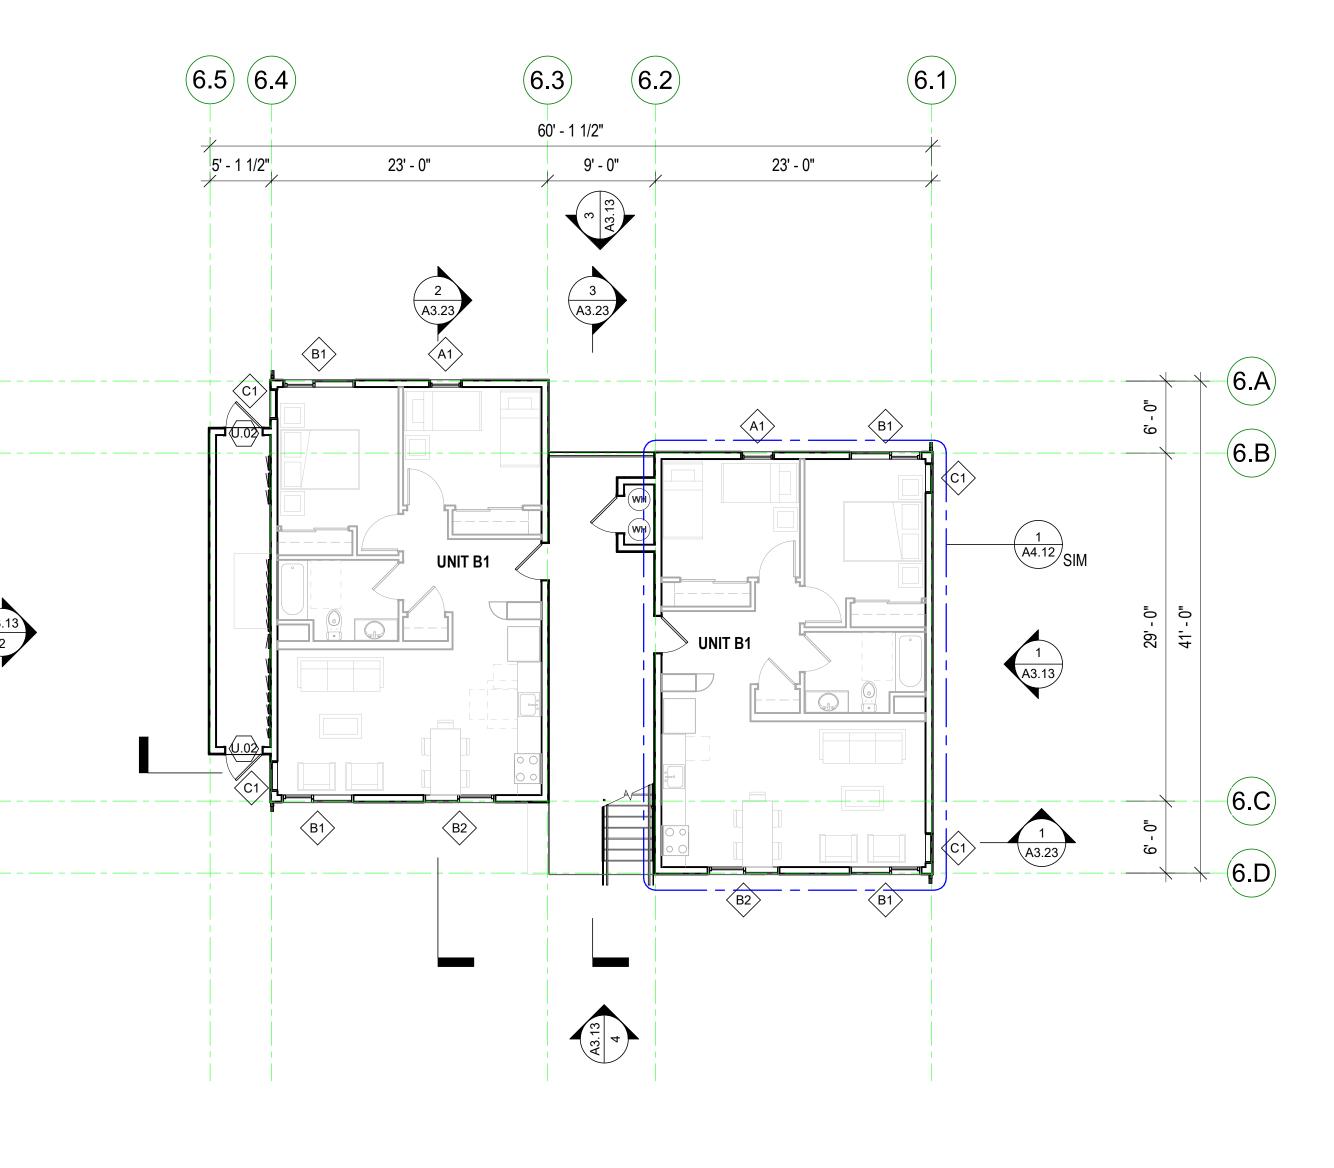

BUILDING 6 - LEVEL 1 FLOOR PLAN (BLDG. 3 & 5 SIM.)
1/8" = 1'-0"

FLOOR PLAN GEN. NOTES


- 1. SEE SHEET **G0.00** FOR SYMBOLS & ABBREVIATIONS 2. THESE PLANS SHOW UNIQUE INFORMATION ONLY. SEE ENLARGED PLANS FOR INFORMATION NOT SHOWN.
- 3. REFERENCE ACCESSIBILITY CODE SHEETS **G0.XX** FOR ALL ACCESSIBILITY STANDARDS, REQUIREMENTS AND
- DIAGRAMS 4. SEE CIVIL PLANS FOR THE BUILDING LOCATION ON SITE AND PRECISE GRADING PLANS. 5. FOR PARKING TABULATION REFER TO SHEET GO.XX.
- 6. ALL DIMENSIONS ARE TO FACE OF MASONRY, CONCRETE, STUD, OR CENTERLINE OF COLUMN OR DEMISING WALL (C.L.). U.O.N. ALL "CLEAR" DIMENSIONS ARE TO FACE OF
- 7. ALL CONSTRUCTION TO BE FIRE-RATED PER THE PROJECT DATA ON THE **G0.XX** SHEETS AND ASSEMBLIES, SHEETS A9.X. UNIT DEMISING WALLS ARE 1-HR RATED, TYPICAL. FOR DETAILED LOCATION OF WALL ASSEMBLY TYPES, SEE ENLARGED PLANS.
- 8. ALL STAIR, ELEVATOR, TRASH CHUTE, AND VENTILATION SHAFTS TO BE 2-HR FIRE RATED BARRIERS IF CONNECTING MORE THAN 3 STORIES. IF LESS THAN 3 STORIES, THESE MUST BE 1-HR FIRE-RATED CONSTRUCTION. 9. FOR DETAIL LOCATION OF WALL ASSEMBLY TYPES, SEE
- BUILDING AND UNIT FLOOR PLANS, SHEETS A2.X, A4.X, & **A8X.** FOR WALL, FLOOR, FLOOR/CEILING, AND ROOF/CEILING ASSEMBLY TYPES, SEE SHEETS A9.X.
- 10. WHERE PROVIDED, CMU PARTITION WALLS TO RECEIVE REINFORCING PER STRUCTURAL DRAWINGS AND
- TERMINATE AT STRUCTURE ABOVE, U.O.N. 11. ALL INTERIOR EXPOSED CONCRETE WITHIN PUBLIC SPACES IS ARCHITECTURAL FINISH, U.O.N.
- 12. STUD SIZES TYPICALLY USED THROUGHOUT PROJECT ARE SHOWN - REFER TO STUD SIZE ON WALL ASSEMBLIES. SHEET A9.X, FOR REQUIRED SIZES, GAUGES AND SPACING REQUIRED. COORDINATE BLOCKING AND BRACING REQURIEMENTS FOR ALL WALL-HUNT ITEMS AND VERIFY
- LOCATIONS PRIOR TO INSTALLATION OF FINISHES. 13. THIS BUILDING TO BE FIRE SPRINKLERED PER APPLICABLE SECTIONS OF CBC CHAPTER 9 AND NFPA 13.

14. CLASS 1 STANDPIPES TO BE INTERCONNECTED.

- 15. PROVIDE ALL NECESSARY WALL ACCESS PANELS AS REQUIRED FOR MECHANICAL, PLUMBING, FIRE SPRINKLER AND ELECTRICAL SYSTEMS. IN FIRE RATED ASSEMBLIES PROVIDE RATED ACCESS PANELS WITH SELF CLOSING DEVICES.
- 16. SEE INDIVIDUAL UNIT FLOOR PLANS OR ENLARGED BUILDING PLANS FOR DETAILED INFORMATION ON DIMENSIONS, CONSTRUCTION, DOORS, WINDOWS, AND OTHER ELEMENTS,
- 17. INTERIOR FINISHES SHALL COMPLY WITH **CBC 803.1** FLAME SPREAD PROVISION, SEE INTERIOR DRAWINGS. 18. FOR DOOR & WINDOW SCHEDULES SEE SHEET A9.X & A9.X.
- 19. RAMP SLOPES ARE MEASURED FROM CENTERLINE OF RAMP. 20. ALL <u>EXIT</u> STAIRS TO COMPLY WITH **CBC CHAPTERS 10, 11A** AND/OR 11B. EXIT STAIRS AND LANDINGS TO BE 44 INCHES MINIMUM IN WIDTH, STAIR RISERS TO BE MAXIMUM 7 INCHES HIGH, AND TREADS TO BE 11 INCHES MINIMUM DEEP.
- 21. SEE ROOF PLAN GENERAL NOTES FOR DRAINAGE, VENTILATION, AND ROOF ACCESS NOTES.
- 22. ALL RESIDENTIAL UNITS THAT FACE ROADS ARE EQUIPPED WITH EITHER MECHANICAL VENTILATION OR PASSIVE FRESH-AIR INLETS, SEE MECHANICAL DRAWINGS FOR MORE INFORMATION.
- 23. SEE SIGNAGE PLANS AND DETAILS ON A10.X FOR ADDITIONAL INFORMATION REGARDING SIGNS AT UNIT ENTRIES, ELEVATORS, STAIRS, EGRESS COMPONENTS, COMMON AREA DOORS.

FLOOR PLAN KEY

SEE GRAPHIC SYMBOLS LEGEND ON COVER SHEET FOR

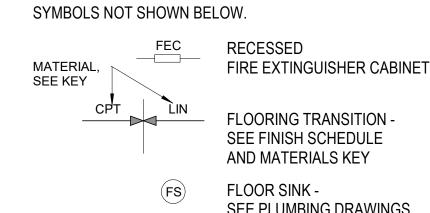

FLOOR SINK -SEE PLUMBING DRAWINGS

FLOOR DRAIN -SEE PLUMBING DRAWINGS -MAX SLOPE TO DRAIN 1/8" PER FOOT, U.O.N. 2 HOUR RATED WALLS


VERTICAL CHASE

VERTICAL RATED SHAFT

SLOPE AT FLOOR OR RAMP DIRECTION

KEYNOTE LEGEND KEYNOTE NUMBER

BUILDING KEY PLAN

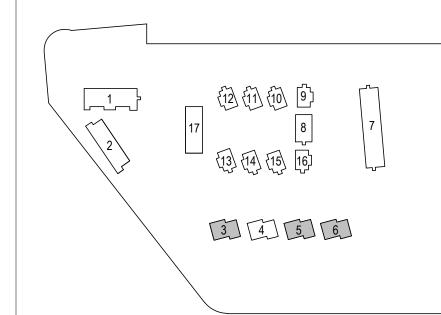

DMMO

OAKLAND, CA 94612

www.pyatok.com

Suite 250

510.465.7010 p | 510.465.8575 f

MidPen H O U S I N G

303 Vintage Park Drive

Foster City, CA 94404

MIDPEN HOUSING

Σ < Щ


STAMP:

REVISION SCHEDULE | Planning Resubmittal | 03/25/19 |
Adjusted Heights	07/10/20
Coastal Development Permit	06/21/22
CDP Resubmittal	12/01/23

JOB NUMBER: DRAWN BY: CHECKED BY SCALE:

FLOOR & ROOF PLANS -**BUILDING TYPE C (BUILDINGS** 3,5,& 6)

A2.13

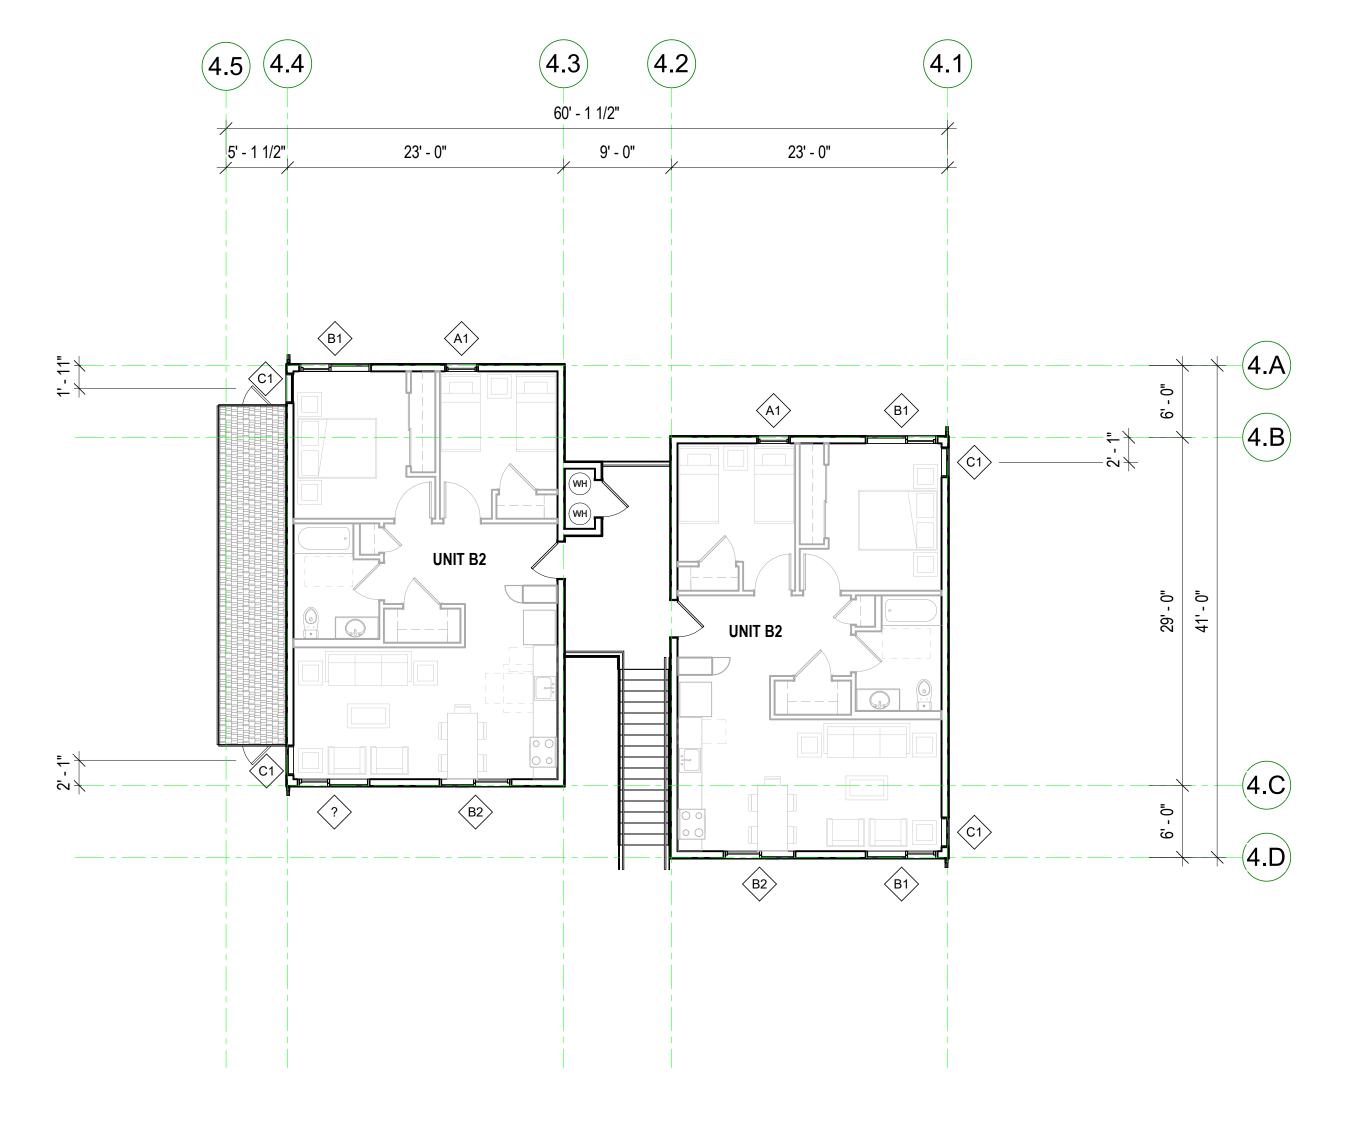


BUILDING 4 - LEVEL 2

1/8" = 1'-0"


2

BUILDING 4 - LEVEL 1

1/8" = 1'-0"

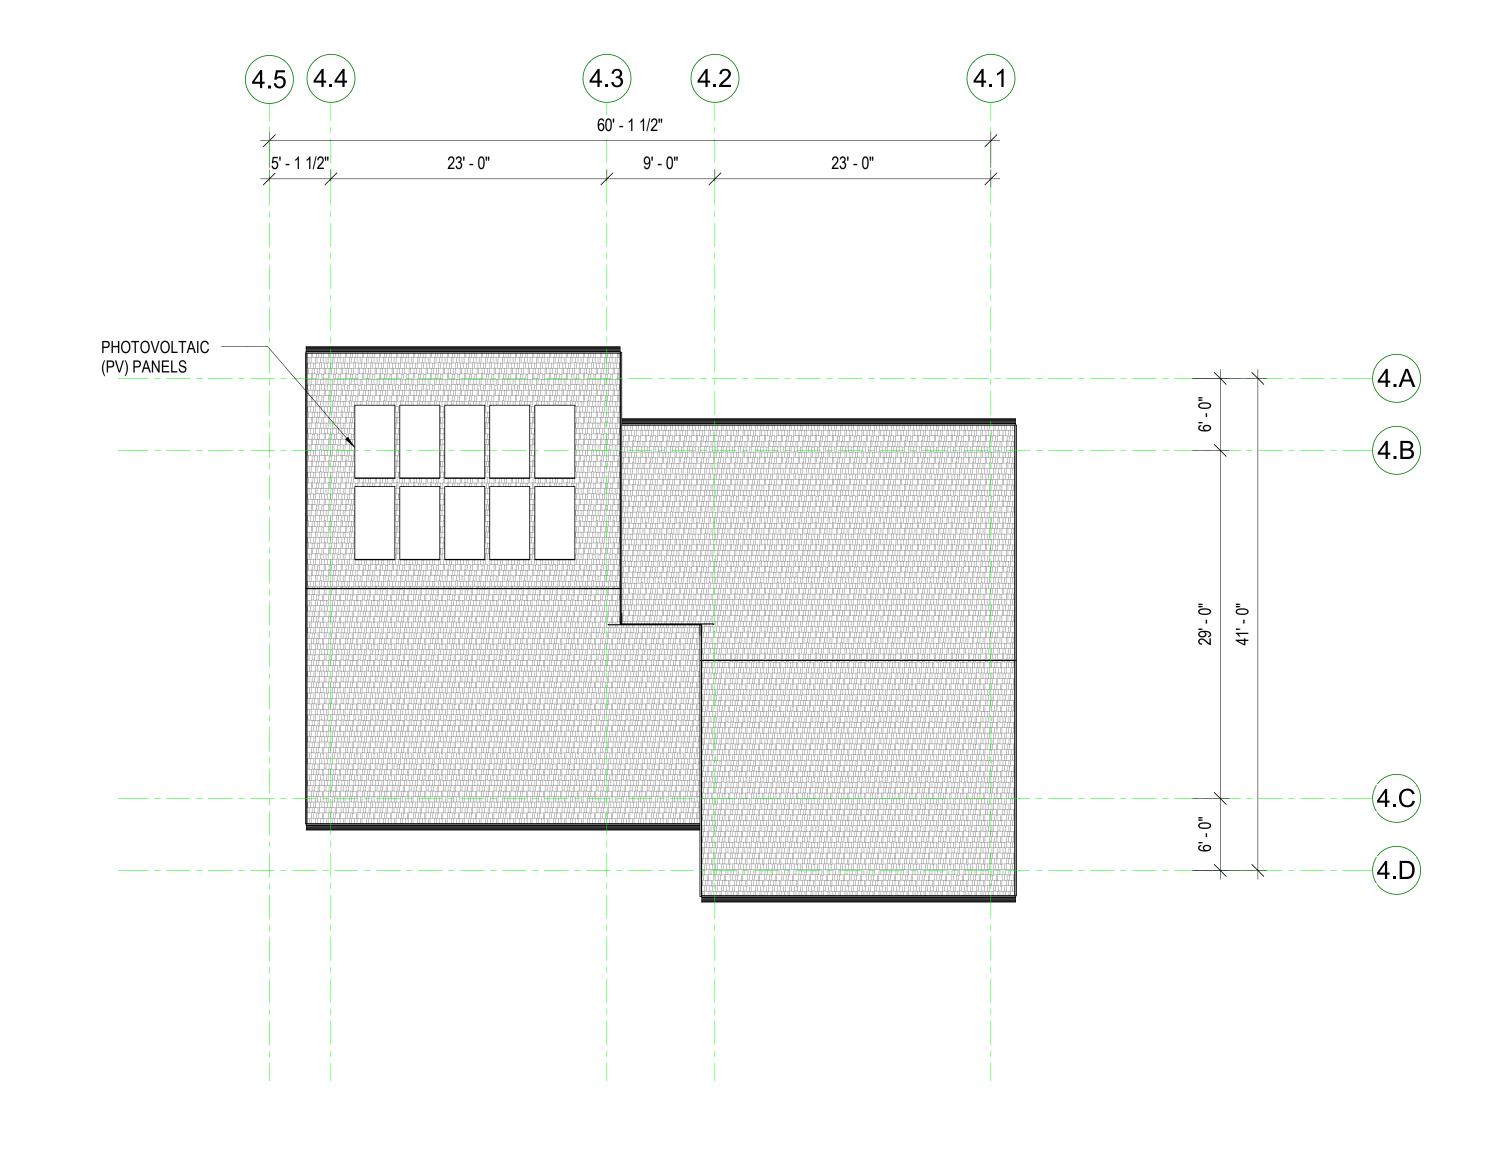

BUILDING 4 - ROOF PLAN
1/8" = 1'-0"

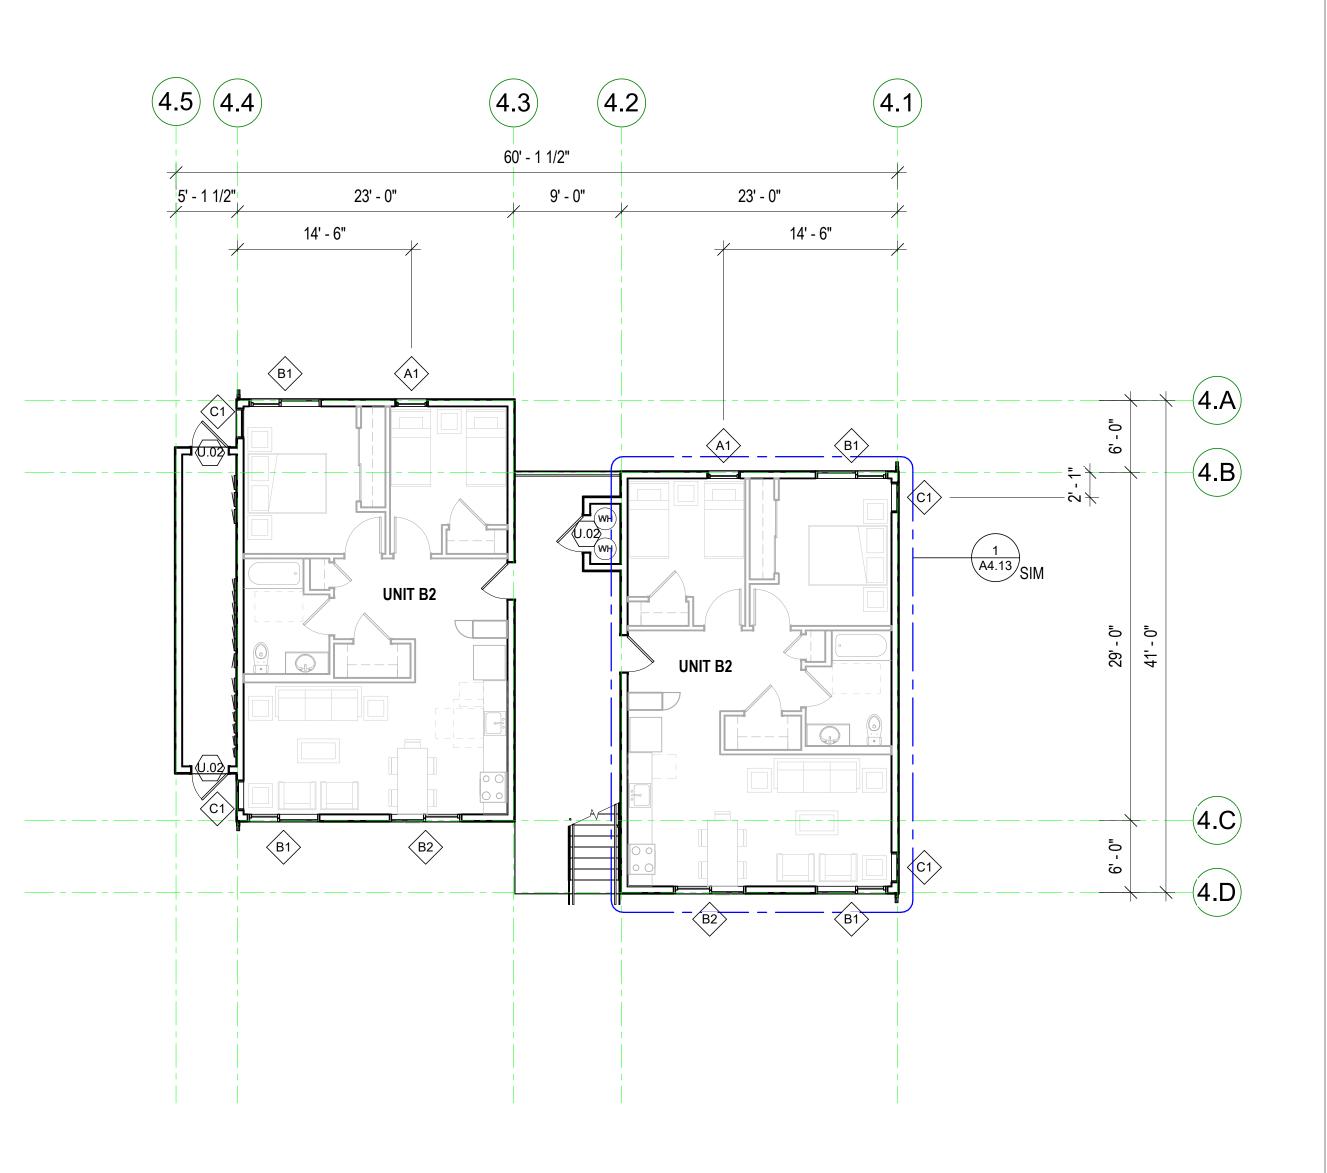



FLOOR PLAN GEN. NOTES

- 1. SEE SHEET **G0.00** FOR SYMBOLS & ABBREVIATIONS 2. THESE PLANS SHOW UNIQUE INFORMATION ONLY. SEE
- ENLARGED PLANS FOR INFORMATION NOT SHOWN. 3. REFERENCE ACCESSIBILITY CODE SHEETS **G0.XX** FOR ALL ACCESSIBILITY STANDARDS, REQUIREMENTS AND
- DIAGRAMS 4. SEE CIVIL PLANS FOR THE BUILDING LOCATION ON SITE AND PRECISE GRADING PLANS.
- 5. FOR PARKING TABULATION REFER TO SHEET **G0.XX**. 6. ALL DIMENSIONS ARE TO FACE OF MASONRY, CONCRETE, STUD, OR CENTERLINE OF COLUMN OR DEMISING WALL (C.L.). U.O.N. ALL "CLEAR" DIMENSIONS ARE TO FACE OF
- 7. ALL CONSTRUCTION TO BE FIRE-RATED PER THE PROJECT DATA ON THE **G0.XX** SHEETS AND ASSEMBLIES, SHEETS A9.X. UNIT DEMISING WALLS ARE 1-HR RATED, TYPICAL. FOR DETAILED LOCATION OF WALL ASSEMBLY TYPES, SEE ENLARGED PLANS.
- 8. ALL STAIR, ELEVATOR, TRASH CHUTE, AND VENTILATION SHAFTS TO BE 2-HR FIRE RATED BARRIERS IF CONNECTING MORE THAN 3 STORIES. IF LESS THAN 3 STORIES, THESE MUST BE 1-HR FIRE-RATED CONSTRUCTION. 9. FOR DETAIL LOCATION OF WALL ASSEMBLY TYPES, SEE
- BUILDING AND UNIT FLOOR PLANS, SHEETS A2.X, A4.X, & **A8X.** FOR WALL, FLOOR, FLOOR/CEILING, AND ROOF/CEILING ASSEMBLY TYPES, SEE SHEETS A9.X. 10. WHERE PROVIDED, CMU PARTITION WALLS TO RECEIVE
- REINFORCING PER STRUCTURAL DRAWINGS AND TERMINATE AT STRUCTURE ABOVE, U.O.N. 11. ALL INTERIOR EXPOSED CONCRETE WITHIN PUBLIC SPACES
- IS ARCHITECTURAL FINISH, U.O.N. 12. STUD SIZES TYPICALLY USED THROUGHOUT PROJECT ARE SHOWN - REFER TO STUD SIZE ON WALL ASSEMBLIES, SHEET A9.X, FOR REQUIRED SIZES, GAUGES AND SPACING REQUIRED. COORDINATE BLOCKING AND BRACING REQURIEMENTS FOR ALL WALL-HUNT ITEMS AND VERIFY
- LOCATIONS PRIOR TO INSTALLATION OF FINISHES. 13. THIS BUILDING TO BE FIRE SPRINKLERED PER APPLICABLE SECTIONS OF CBC CHAPTER 9 AND NFPA 13. 14. CLASS 1 STANDPIPES TO BE INTERCONNECTED.
- 15. PROVIDE ALL NECESSARY WALL ACCESS PANELS AS REQUIRED FOR MECHANICAL, PLUMBING, FIRE SPRINKLER AND ELECTRICAL SYSTEMS. IN FIRE RATED ASSEMBLIES PROVIDE RATED ACCESS PANELS WITH SELF CLOSING DEVICES.
- 16. SEE INDIVIDUAL UNIT FLOOR PLANS OR ENLARGED BUILDING PLANS FOR DETAILED INFORMATION ON DIMENSIONS, CONSTRUCTION, DOORS, WINDOWS, AND OTHER ELEMENTS,
- 17. INTERIOR FINISHES SHALL COMPLY WITH **CBC 803.1** FLAME SPREAD PROVISION, SEE INTERIOR DRAWINGS. 18. FOR DOOR & WINDOW SCHEDULES SEE SHEET A9.X & A9.X. 19. RAMP SLOPES ARE MEASURED FROM CENTERLINE OF RAMP.
- 20. ALL EXIT STAIRS TO COMPLY WITH CBC CHAPTERS 10, 11A AND/OR 11B. EXIT STAIRS AND LANDINGS TO BE 44 INCHES MINIMUM IN WIDTH, STAIR RISERS TO BE MAXIMUM 7 INCHES HIGH, AND TREADS TO BE 11 INCHES MINIMUM DEEP. 21. SEE ROOF PLAN GENERAL NOTES FOR DRAINAGE,
- VENTILATION, AND ROOF ACCESS NOTES. 22. ALL RESIDENTIAL UNITS THAT FACE ROADS ARE EQUIPPED WITH EITHER MECHANICAL VENTILATION OR PASSIVE FRESH-AIR INLETS, SEE MECHANICAL DRAWINGS FOR MORE INFORMATION.
- 23. SEE SIGNAGE PLANS AND DETAILS ON A10.X FOR ADDITIONAL INFORMATION REGARDING SIGNS AT UNIT ENTRIES, ELEVATORS, STAIRS, EGRESS COMPONENTS, COMMON AREA DOORS.

FLOOR PLAN KEY

SEE GRAPHIC SYMBOLS LEGEND ON COVER SHEET FOR

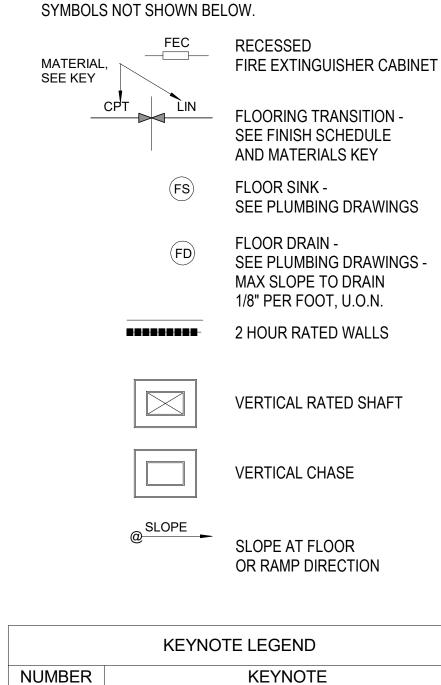

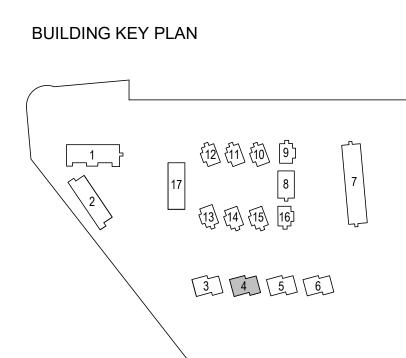

© 2023 PYATOK ARCHITECTURE & URBAN DESIGN

1611 TELEGRAPH AVE. SUITE 200 OAKLAND, CA 94612 510.465.7010 p | 510.465.8575 f www.pyatok.com

MidPen H O U S I N G MIDPEN HOUSING

303 Vintage Park Drive

Suite 250 Foster City, CA 94404

DMMO E 4

STAMP:

JOB NUMBER: DRAWN BY:

CHECKED BY

FLOOR & ROOF PLANS -


L1 MOBILITY UNITS)

BUILDING TYPE C (BUILDING 4,

SCALE:

REVISION SCHEDULE

NO. ISSUE DATE
4 CDP Resubmittal 12/01/23

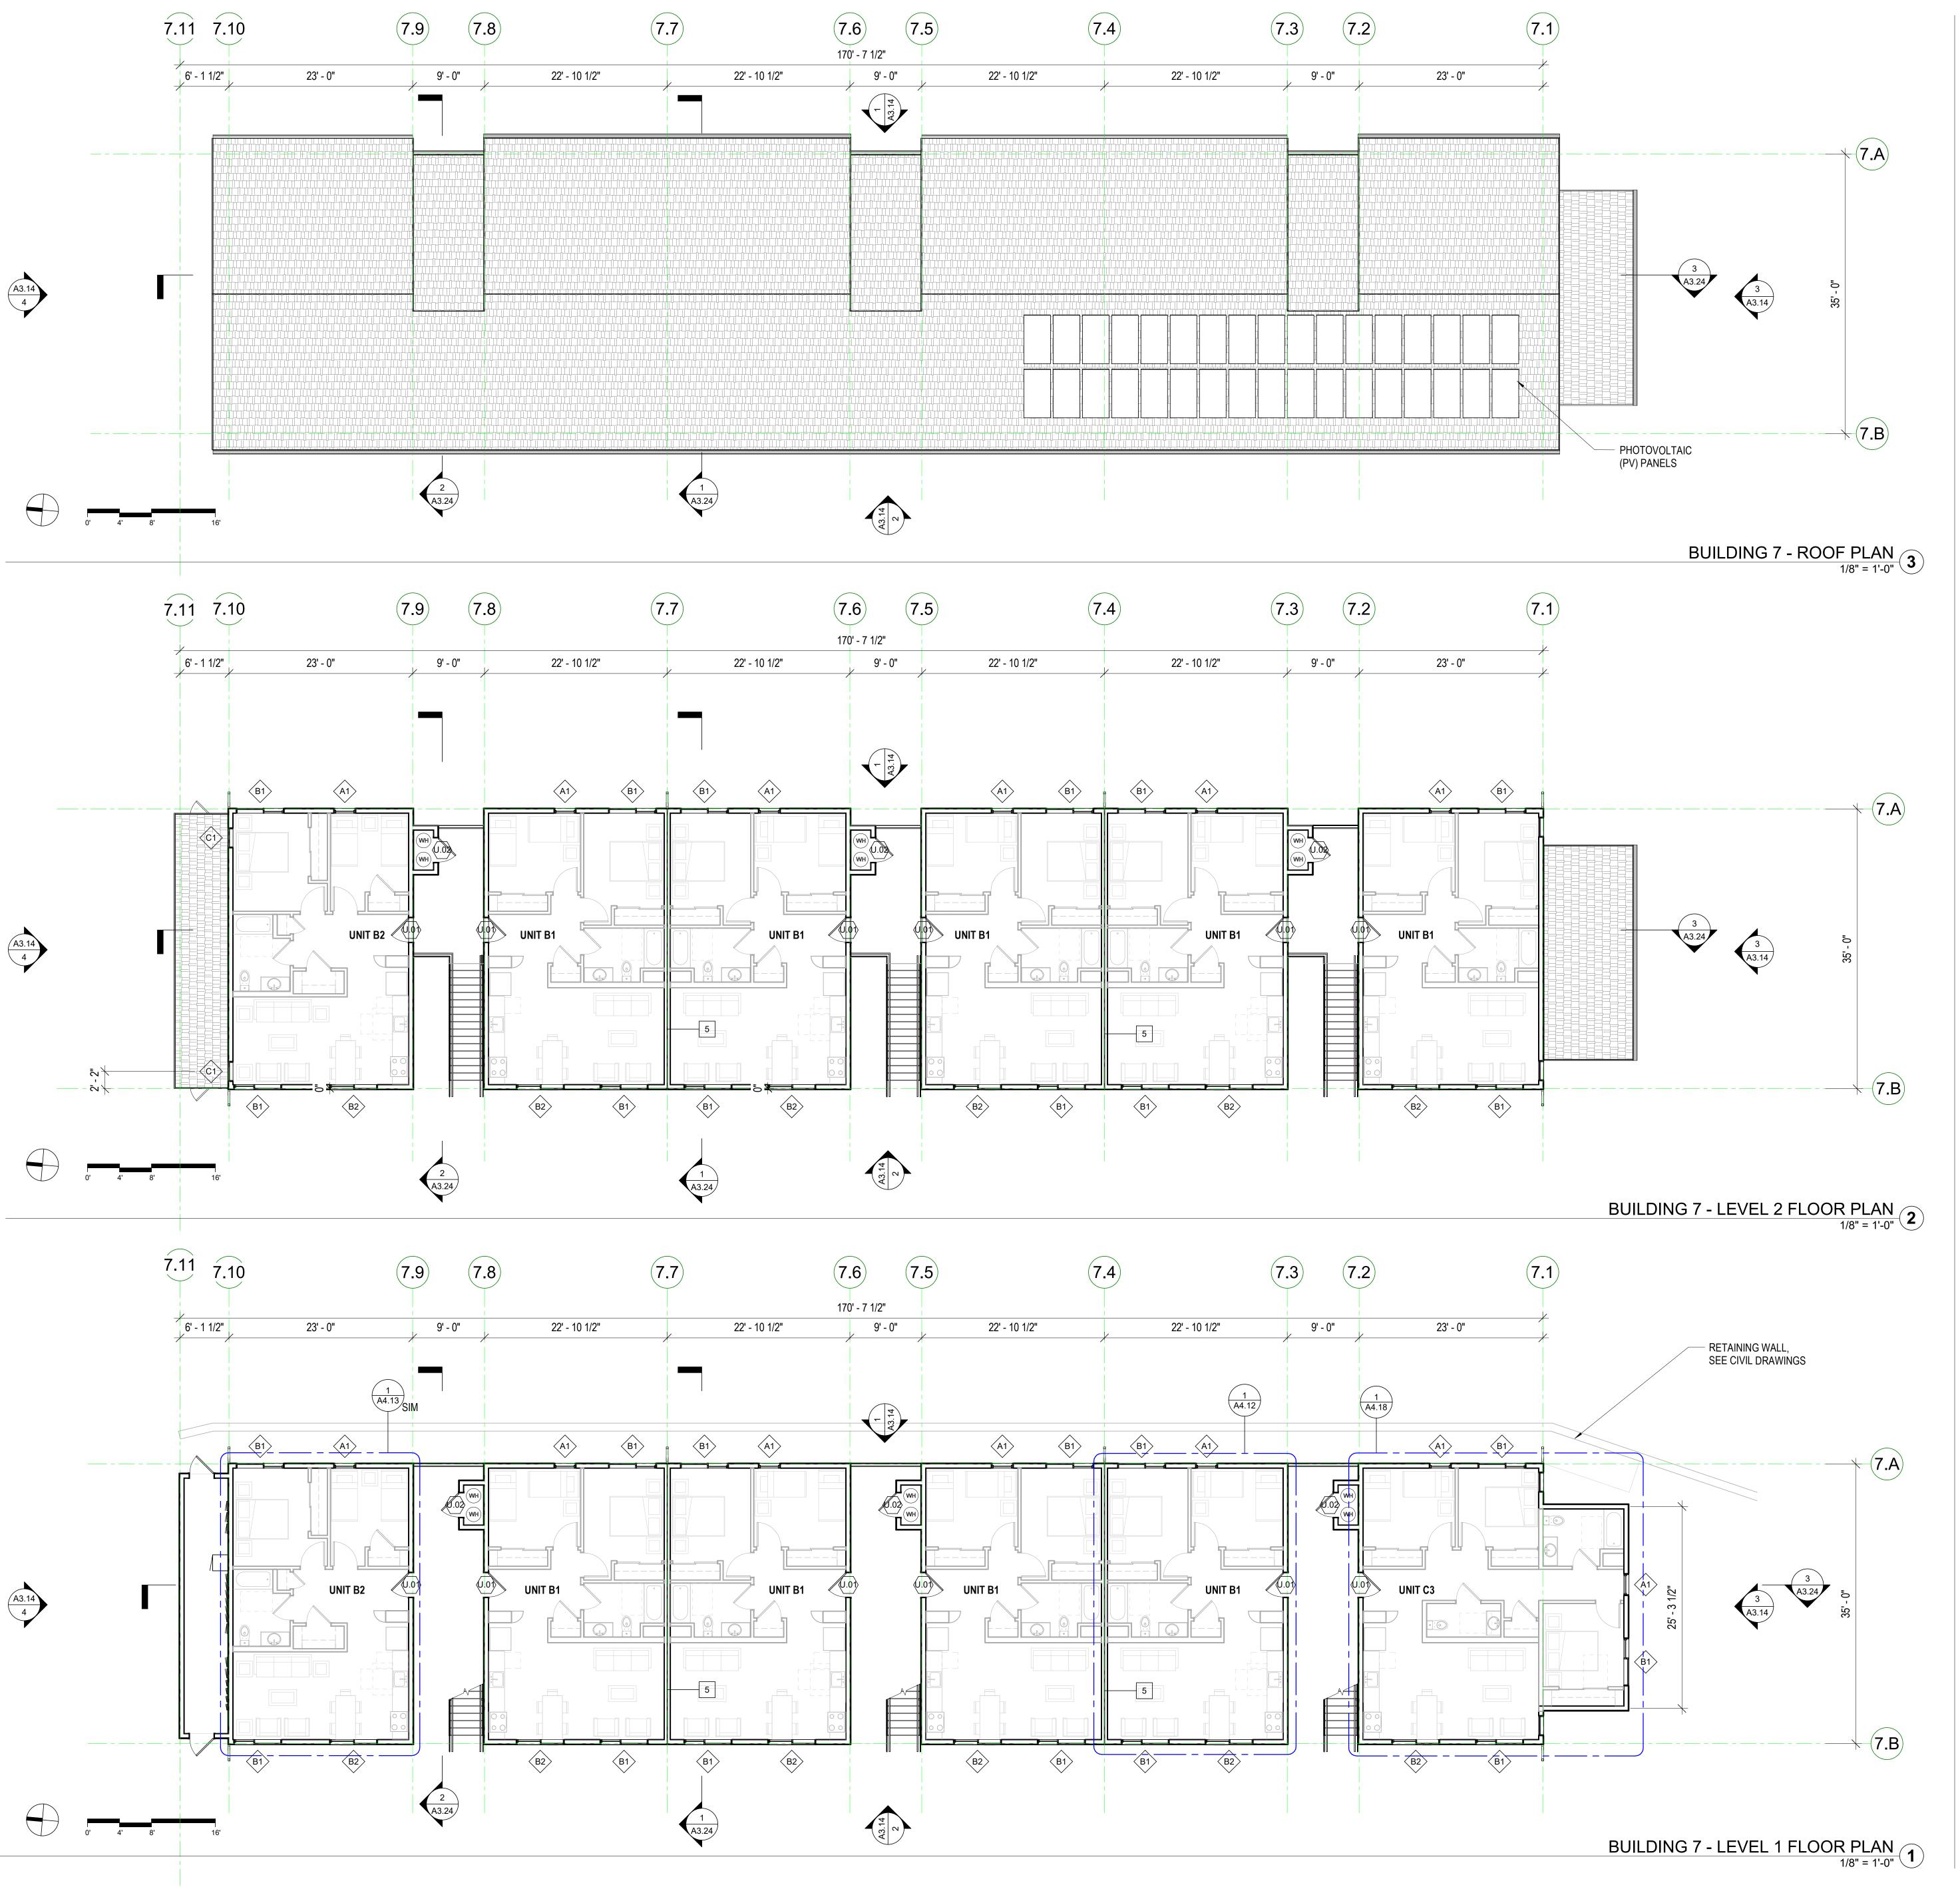

FLOOR PLAN GEN. NOTES

- 1. SEE SHEET **G0.00** FOR SYMBOLS & ABBREVIATIONS
- THESE PLANS SHOW UNIQUE INFORMATION ONLY. SEE ENLARGED PLANS FOR INFORMATION NOT SHOWN.
 REFERENCE ACCESSIBILITY CODE SHEETS GO.XX FOR ALL
- ACCESSIBILITY STANDARDS, REQUIREMENTS AND DIAGRAMS

 4. SEE CIVIL PLANS FOR THE BUILDING LOCATION ON SITE AND
- PRECISE GRADING PLANS.

 5. FOR PARKING TABULATION REFER TO SHEET GO.XX.

 6. ALL DIMENSIONS ARE TO FACE OF MASONRY CONCR
- 6. ALL DIMENSIONS ARE TO FACE OF MASONRY, CONCRETE, STUD, OR CENTERLINE OF COLUMN OR DEMISING WALL (C.L.). U.O.N. ALL "CLEAR" DIMENSIONS ARE TO FACE OF FINISH.

 7. ALL CONSTRUCTION TO BE FIRE PATED DEPITHE DROJECT
- 7. ALL CONSTRUCTION TO BE FIRE-RATED PER THE PROJECT DATA ON THE **G0.XX** SHEETS AND ASSEMBLIES, SHEETS **A9.X.** UNIT DEMISING WALLS ARE 1-HR RATED, TYPICAL. FOR DETAILED LOCATION OF WALL ASSEMBLY TYPES, SEE ENLARGED PLANS.
- ALL STAIR, ELEVATOR, TRASH CHUTE, AND VENTILATION SHAFTS TO BE 2-HR FIRE RATED BARRIERS IF CONNECTING MORE THAN 3 STORIES. IF LESS THAN 3 STORIES, THESE MUST BE 1-HR FIRE-RATED CONSTRUCTION.
 FOR DETAIL LOCATION OF WALL ASSEMBLY TYPES, SEE
- BUILDING AND UNIT FLOOR PLANS, SHEETS A2.X, A4.X, & A8X. FOR WALL, FLOOR, FLOOR/CEILING, AND ROOF/CEILING ASSEMBLY TYPES, SEE SHEETS A9.X.

 10. WHERE PROVIDED, CMU PARTITION WALLS TO RECEIVE
- REINFORCING PER STRUCTURAL DRAWINGS AND TERMINATE AT STRUCTURE ABOVE, U.O.N.

 11. ALL INTERIOR EXPOSED CONCRETE WITHIN PUBLIC SPACES IS ARCHITECTURAL FINISH, U.O.N.
- 12. STUD SIZES TYPICALLY USED THROUGHOUT PROJECT ARE SHOWN REFER TO STUD SIZE ON WALL ASSEMBLIES, SHEET A9.X, FOR REQUIRED SIZES, GAUGES AND SPACING REQUIRED. COORDINATE BLOCKING AND BRACING REQURIEMENTS FOR ALL WALL-HUNT ITEMS AND VERIFY
- LOCATIONS PRIOR TO INSTALLATION OF FINISHES.

 13. THIS BUILDING TO BE FIRE SPRINKLERED PER APPLICABLE SECTIONS OF CBC CHAPTER 9 AND NFPA 13.


 14. CLASS 1 STANDPIPES TO BE INTERCONNECTED.
- 15. PROVIDE ALL NECESSARY WALL ACCESS PANELS AS REQUIRED FOR MECHANICAL, PLUMBING, FIRE SPRINKLER AND ELECTRICAL SYSTEMS. IN FIRE RATED ASSEMBLIES PROVIDE RATED ACCESS PANELS WITH SELF CLOSING DEVICES.
- 16. SEE INDIVIDUAL UNIT FLOOR PLANS OR ENLARGED BUILDING PLANS FOR DETAILED INFORMATION ON DIMENSIONS, CONSTRUCTION, DOORS, WINDOWS, AND OTHER ELEMENTS, TYPICAL
- 17. INTERIOR FINISHES SHALL COMPLY WITH <u>CBC 803.1</u> FLAME SPREAD PROVISION, SEE INTERIOR DRAWINGS.
- VENTILATION, AND ROOF ACCESS NOTES.

 22. ALL RESIDENTIAL UNITS THAT FACE ROADS ARE EQUIPPED WITH EITHER MECHANICAL VENTILATION OR PASSIVE FRESH-AIR INLETS, SEE MECHANICAL DRAWINGS FOR MORE
- INFORMATION.
 23. SEE SIGNAGE PLANS AND DETAILS ON **A10.X** FOR ADDITIONAL INFORMATION REGARDING SIGNS AT UNIT ENTRIES, ELEVATORS, STAIRS, EGRESS COMPONENTS, COMMON AREA DOORS.

FLOOR PLAN KEY

NUMBER

SEE GRAPHIC SYMBOLS LEGEND ON COVER SHEET FOR SYMBOLS NOT SHOWN BELOW.

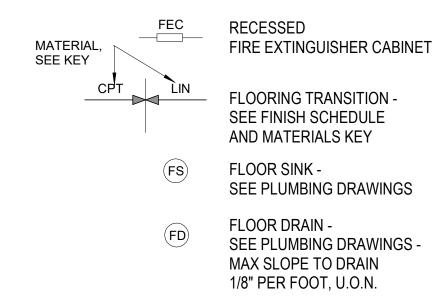

2 HOUR RATED WALLS

VERTICAL RATED SHAFT

VERTICAL CHASE

KEYNOTE LEGEND

KEYNOTE

SLOPE AT FLOOR OR RAMP DIRECTION

BUILDING KEY PLAN

17

17

18

17

13

14

15

16

3

4

5

6

JOB NUMBER: 1600
DRAWN BY: GP/SC
CHECKED BY: PW
DATE: January 24, 2020
SCALE: As indicated

FLOOR & ROOF PLANS BUILDING TYPE D (BUILDING 7)

A2.15

© 2023 PYATOK ARCHITECTURE & URBAN DESIGN

MIDPEN HOUSING
303 Vintage Park Drive
Suite 250
Foster City, CA 94404

DMMO

OAKLAND, CA 94612

www.pyatok.com


510.465.7010 p | 510.465.8575 f

MidPen Housing

YPRESS POINT FA

STAMP:

BUILDING 8 - LEVEL 2 FLOOR PLAN 1/8" = 1'-0"

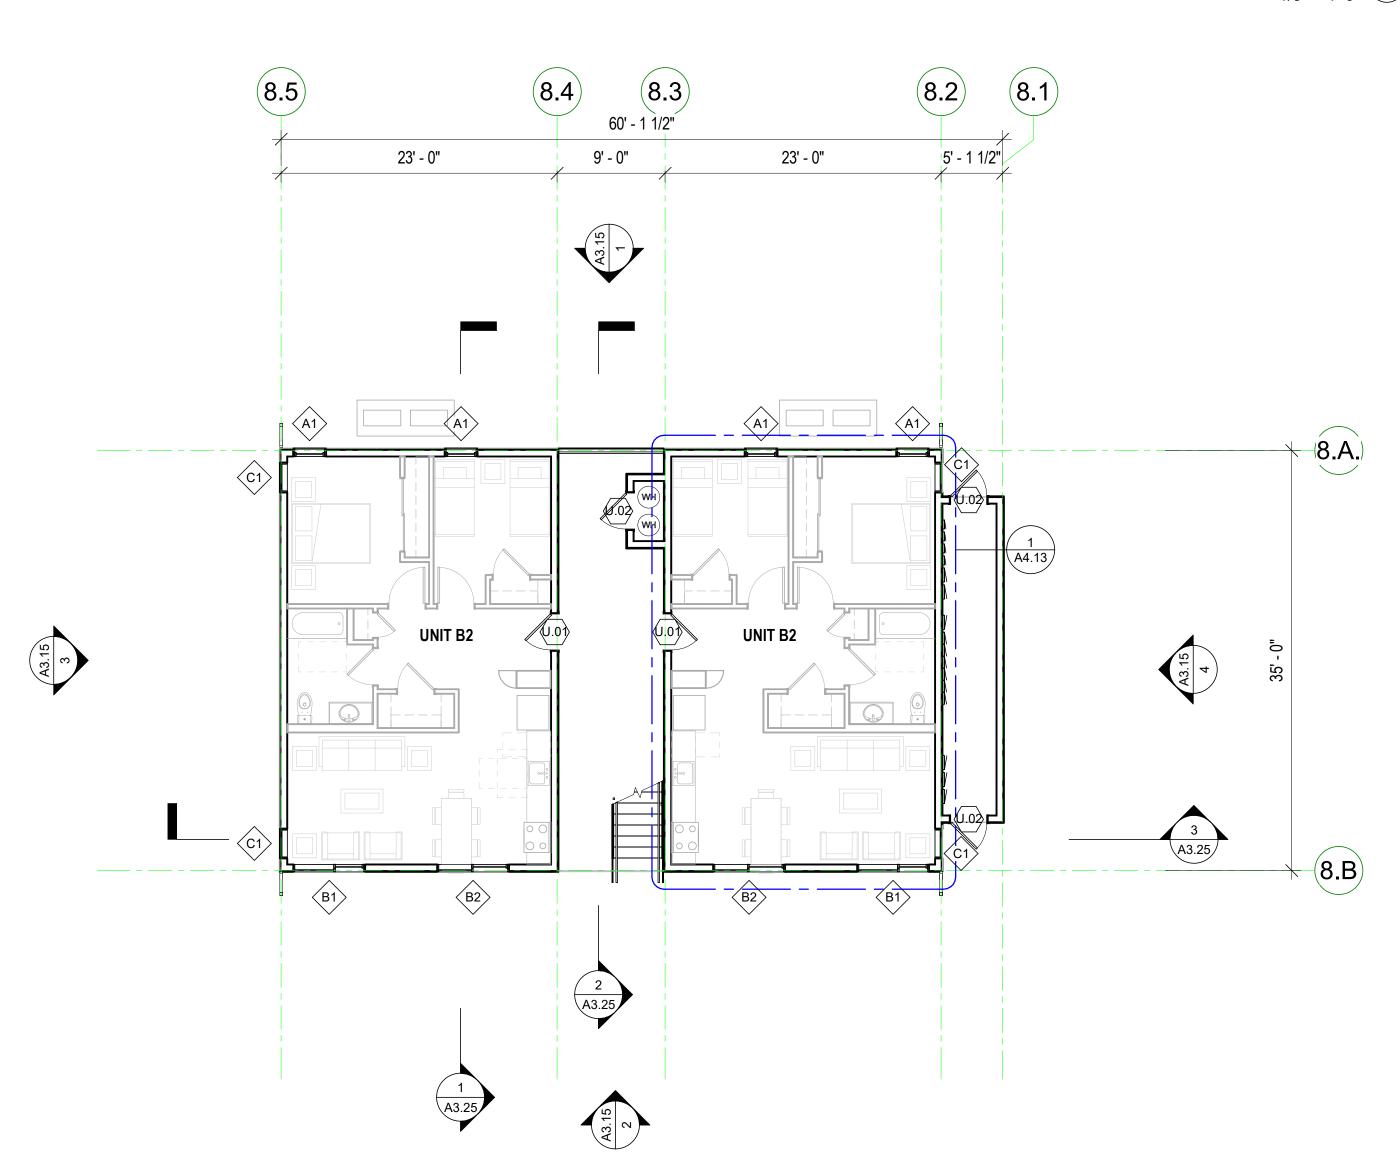

FLOOR PLAN GEN. NOTES

- 1. SEE SHEET **G0.00** FOR SYMBOLS & ABBREVIATIONS 2. THESE PLANS SHOW UNIQUE INFORMATION ONLY. SEE
- ENLARGED PLANS FOR INFORMATION NOT SHOWN. 3. REFERENCE ACCESSIBILITY CODE SHEETS **G0.XX** FOR ALL ACCESSIBILITY STANDARDS, REQUIREMENTS AND
- 4. SEE CIVIL PLANS FOR THE BUILDING LOCATION ON SITE AND PRECISE GRADING PLANS.
- 5. FOR PARKING TABULATION REFER TO SHEET **G0.XX**. 6. ALL DIMENSIONS ARE TO FACE OF MASONRY, CONCRETE, STUD, OR CENTERLINE OF COLUMN OR DEMISING WALL (C.L.). U.O.N. ALL "CLEAR" DIMENSIONS ARE TO FACE OF
- 7. ALL CONSTRUCTION TO BE FIRE-RATED PER THE PROJECT DATA ON THE **G0.XX** SHEETS AND ASSEMBLIES, SHEETS A9.X. UNIT DEMISING WALLS ARE 1-HR RATED, TYPICAL. FOR DETAILED LOCATION OF WALL ASSEMBLY TYPES, SEE ENLARGED PLANS.
- 8. ALL STAIR, ELEVATOR, TRASH CHUTE, AND VENTILATION SHAFTS TO BE 2-HR FIRE RATED BARRIERS IF CONNECTING MORE THAN 3 STORIES. IF LESS THAN 3 STORIES, THESE MUST BE 1-HR FIRE-RATED CONSTRUCTION. 9. FOR DETAIL LOCATION OF WALL ASSEMBLY TYPES, SEE
- BUILDING AND UNIT FLOOR PLANS, SHEETS A2.X, A4.X, & **A8X.** FOR WALL, FLOOR, FLOOR/CEILING, AND ROOF/CEILING ASSEMBLY TYPES, SEE SHEETS A9.X. 10. WHERE PROVIDED, CMU PARTITION WALLS TO RECEIVE
- REINFORCING PER STRUCTURAL DRAWINGS AND TERMINATE AT STRUCTURE ABOVE, U.O.N. 11. ALL INTERIOR EXPOSED CONCRETE WITHIN PUBLIC SPACES
- IS ARCHITECTURAL FINISH, U.O.N. 12. STUD SIZES TYPICALLY USED THROUGHOUT PROJECT ARE SHOWN - REFER TO STUD SIZE ON WALL ASSEMBLIES, SHEET A9.X, FOR REQUIRED SIZES, GAUGES AND SPACING REQUIRED. COORDINATE BLOCKING AND BRACING
- REQURIEMENTS FOR ALL WALL-HUNT ITEMS AND VERIFY LOCATIONS PRIOR TO INSTALLATION OF FINISHES. 13. THIS BUILDING TO BE FIRE SPRINKLERED PER APPLICABLE SECTIONS OF CBC CHAPTER 9 AND NFPA 13.

14. CLASS 1 STANDPIPES TO BE INTERCONNECTED.


- 15. PROVIDE ALL NECESSARY WALL ACCESS PANELS AS REQUIRED FOR MECHANICAL, PLUMBING, FIRE SPRINKLER AND ELECTRICAL SYSTEMS. IN FIRE RATED ASSEMBLIES PROVIDE RATED ACCESS PANELS WITH SELF CLOSING DEVICES. 16. SEE INDIVIDUAL UNIT FLOOR PLANS OR ENLARGED BUILDING
- PLANS FOR DETAILED INFORMATION ON DIMENSIONS, CONSTRUCTION, DOORS, WINDOWS, AND OTHER ELEMENTS, 17. INTERIOR FINISHES SHALL COMPLY WITH **CBC 803.1** FLAME

SPREAD PROVISION, SEE INTERIOR DRAWINGS.


- 18. FOR DOOR & WINDOW SCHEDULES SEE SHEET A9.X & A9.X. 19. RAMP SLOPES ARE MEASURED FROM CENTERLINE OF RAMP. 20. ALL EXIT STAIRS TO COMPLY WITH CBC CHAPTERS 10, 11A AND/OR 11B. EXIT STAIRS AND LANDINGS TO BE 44 INCHES MINIMUM IN WIDTH, STAIR RISERS TO BE MAXIMUM 7 INCHES HIGH, AND TREADS TO BE 11 INCHES MINIMUM DEEP. 21. SEE ROOF PLAN GENERAL NOTES FOR DRAINAGE,
- VENTILATION, AND ROOF ACCESS NOTES. 22. ALL RESIDENTIAL UNITS THAT FACE ROADS ARE EQUIPPED WITH EITHER MECHANICAL VENTILATION OR PASSIVE FRESH-AIR INLETS, SEE MECHANICAL DRAWINGS FOR MORE
- INFORMATION. 23. SEE SIGNAGE PLANS AND DETAILS ON A10.X FOR ADDITIONAL INFORMATION REGARDING SIGNS AT UNIT ENTRIES, ELEVATORS, STAIRS, EGRESS COMPONENTS, COMMON AREA DOORS.

FLOOR PLAN KEY

SEE GRAPHIC SYMBOLS LEGEND ON COVER SHEET FOR

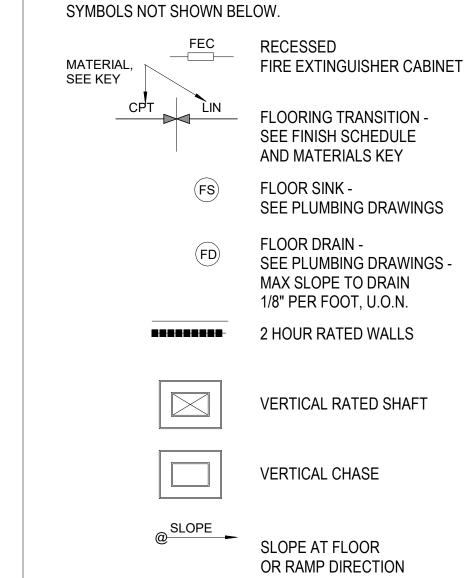

KEYNOTE LEGEND KEYNOTE NUMBER

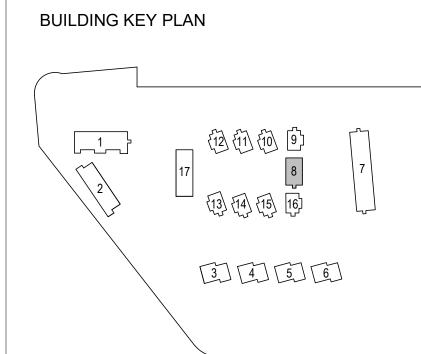

BUILDING 8 ROOF PLAN 3

(8.2) (8.1)

23' - 0"

23' - 0"

— -2 + ·

PHOTOVOLTAIC

(PV) PANELS -

9' - 0"

BUILDING 8 - LEVEL 1 FLOOR PLAN

1/8" = 1'-0"

MidPen H O U S I N G MIDPEN HOUSING 303 Vintage Park Drive Suite 250

Foster City, CA 94404

1611 TELEGRAPH AVE. SUITE 200

510.465.7010 p | 510.465.8575 f

OAKLAND, CA 94612

www.pyatok.com

DMMO

Ξ


<

STAMP:

REVISION SCHEDULE | Planning Resubmittal | 03/25/19 |
Adjusted Heights	07/10/20
Coastal Development Permit	06/21/22
CDP Resubmittal	12/01/23

JOB NUMBER: DRAWN BY: CHECKED BY

SCALE: FLOOR & ROOF PLANS -BUILDING TYPE E (BUILDING 8)

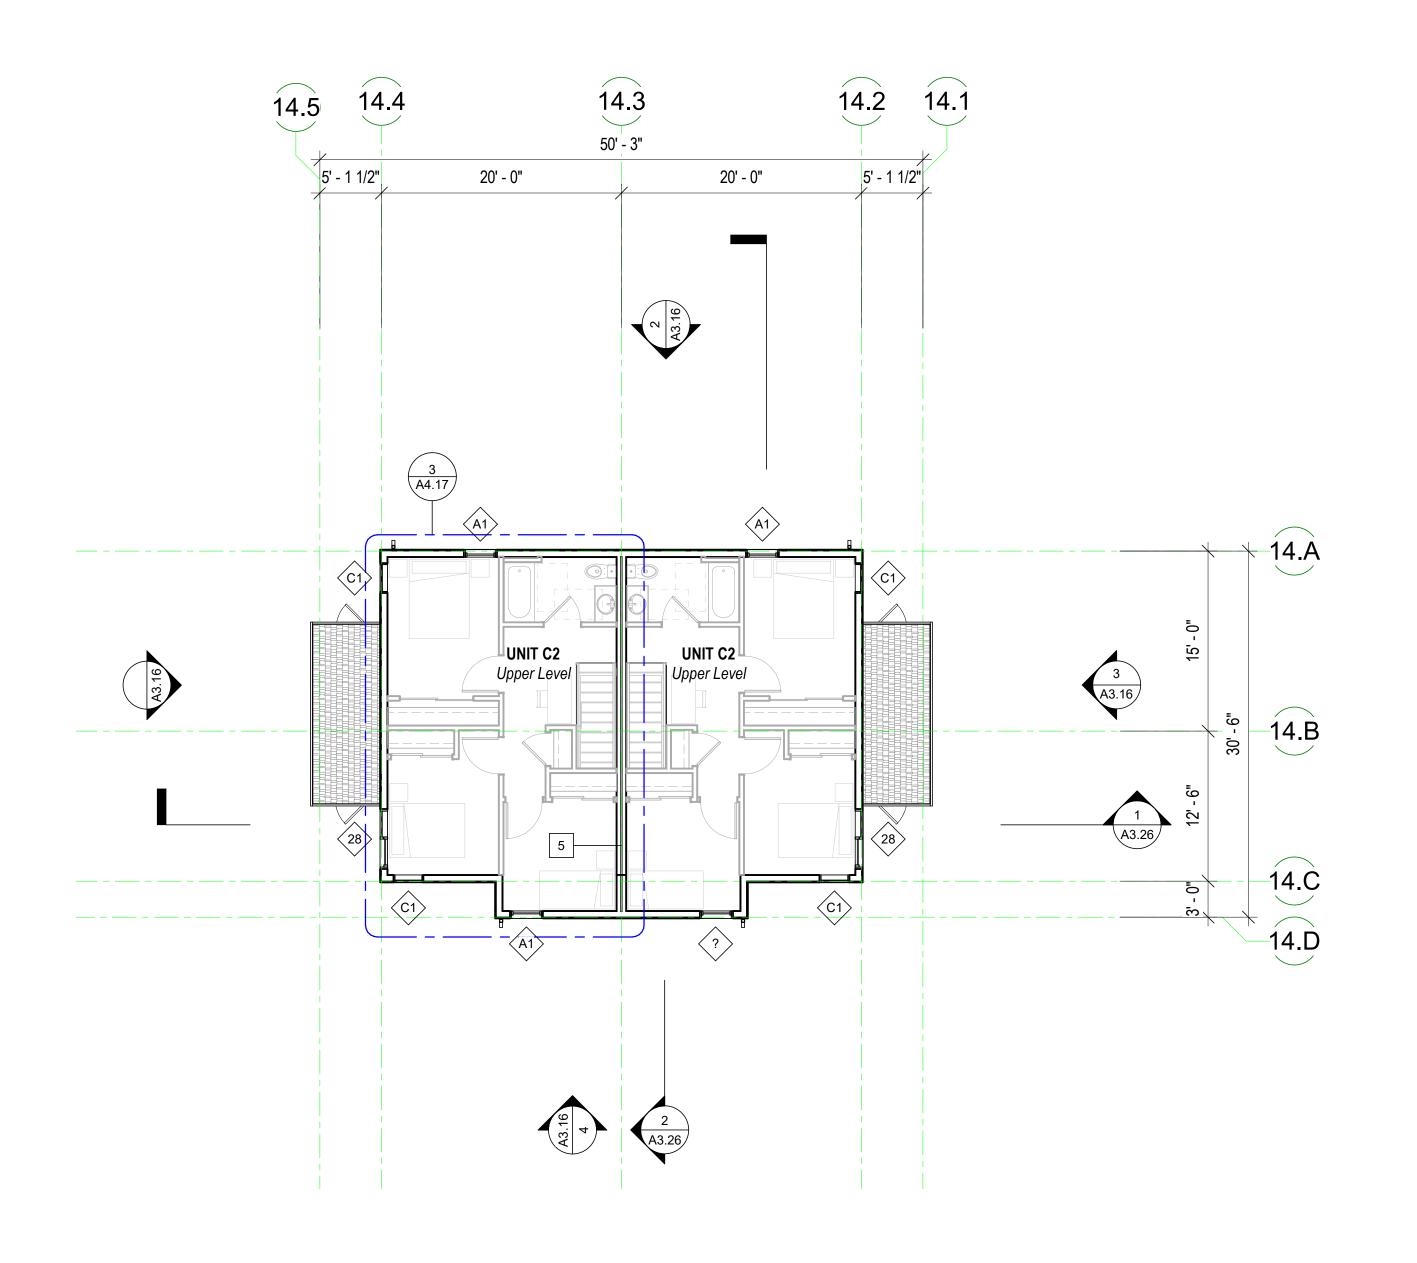

14.3

50' - 3"

20' - 0"

14.5

14.4

20' - 0"


5' - 1 1/2"


BUILDING 14 - LEVEL 2 FLOOR PLAN (BLDG. 9,11-16 SIM.)

1/8" = 1'-0"

14.2

14.1

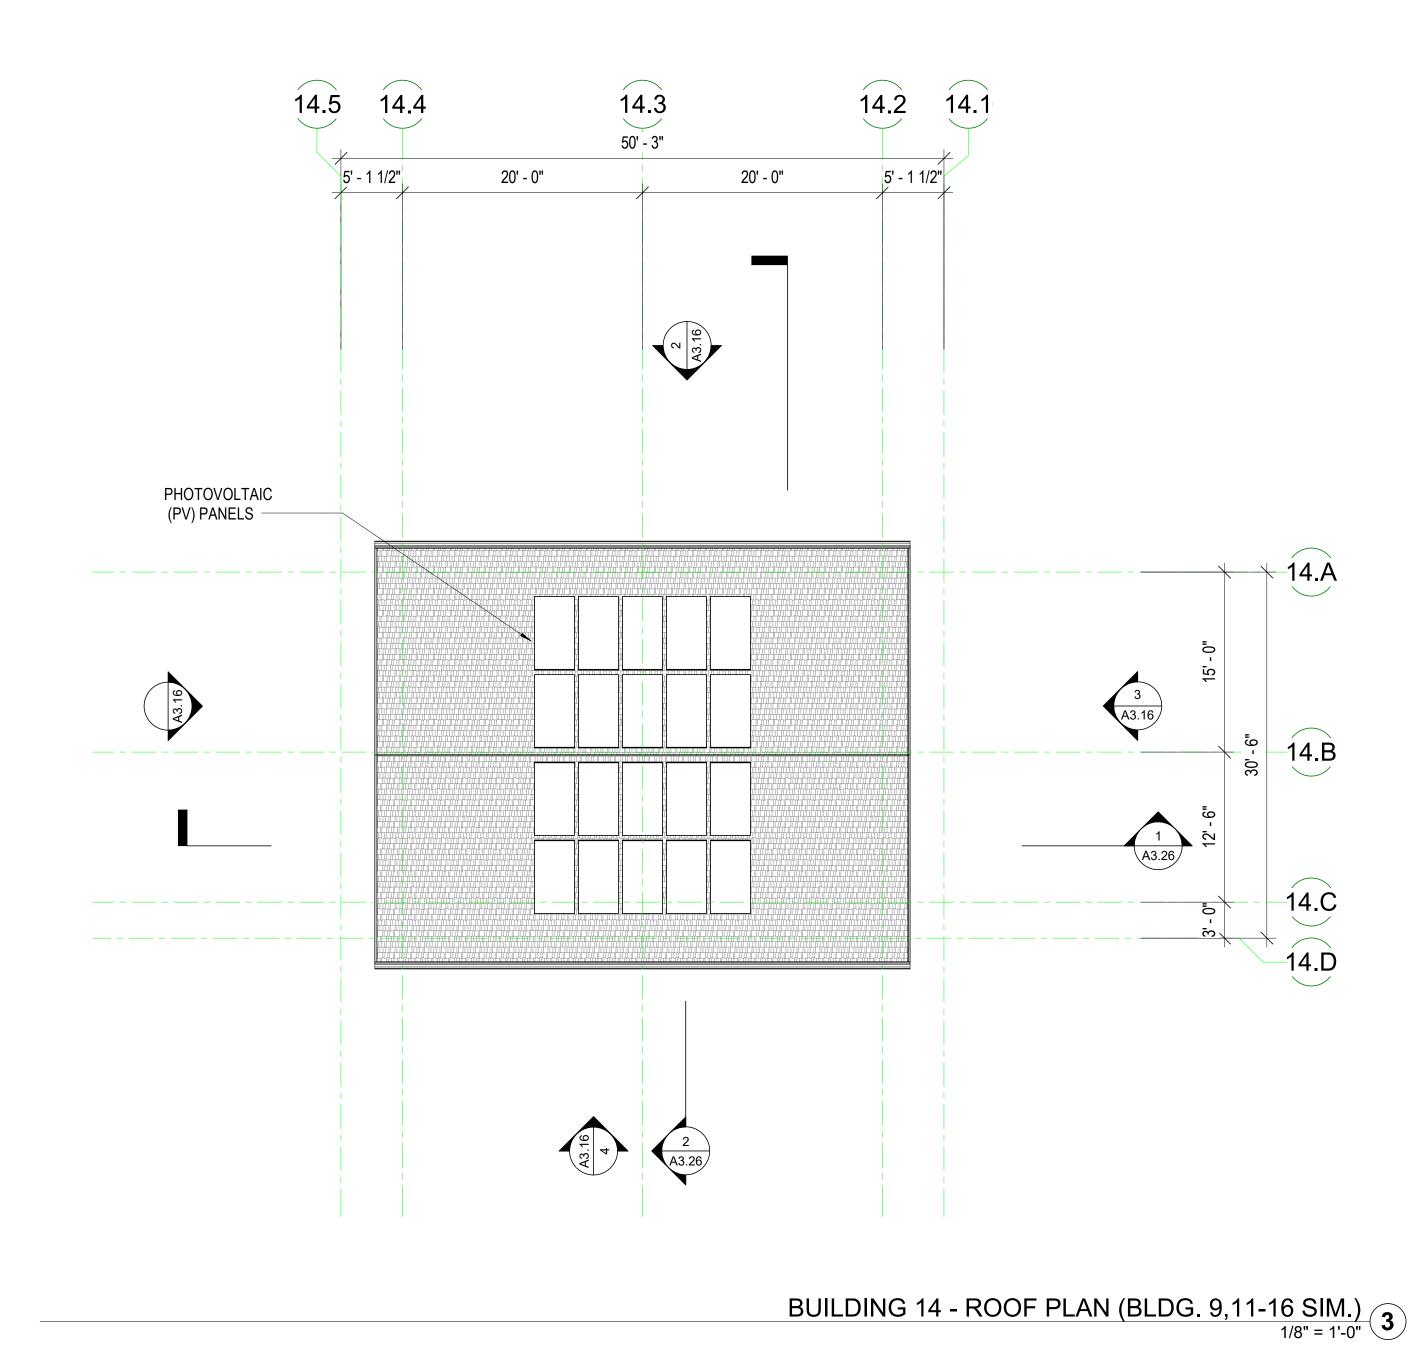

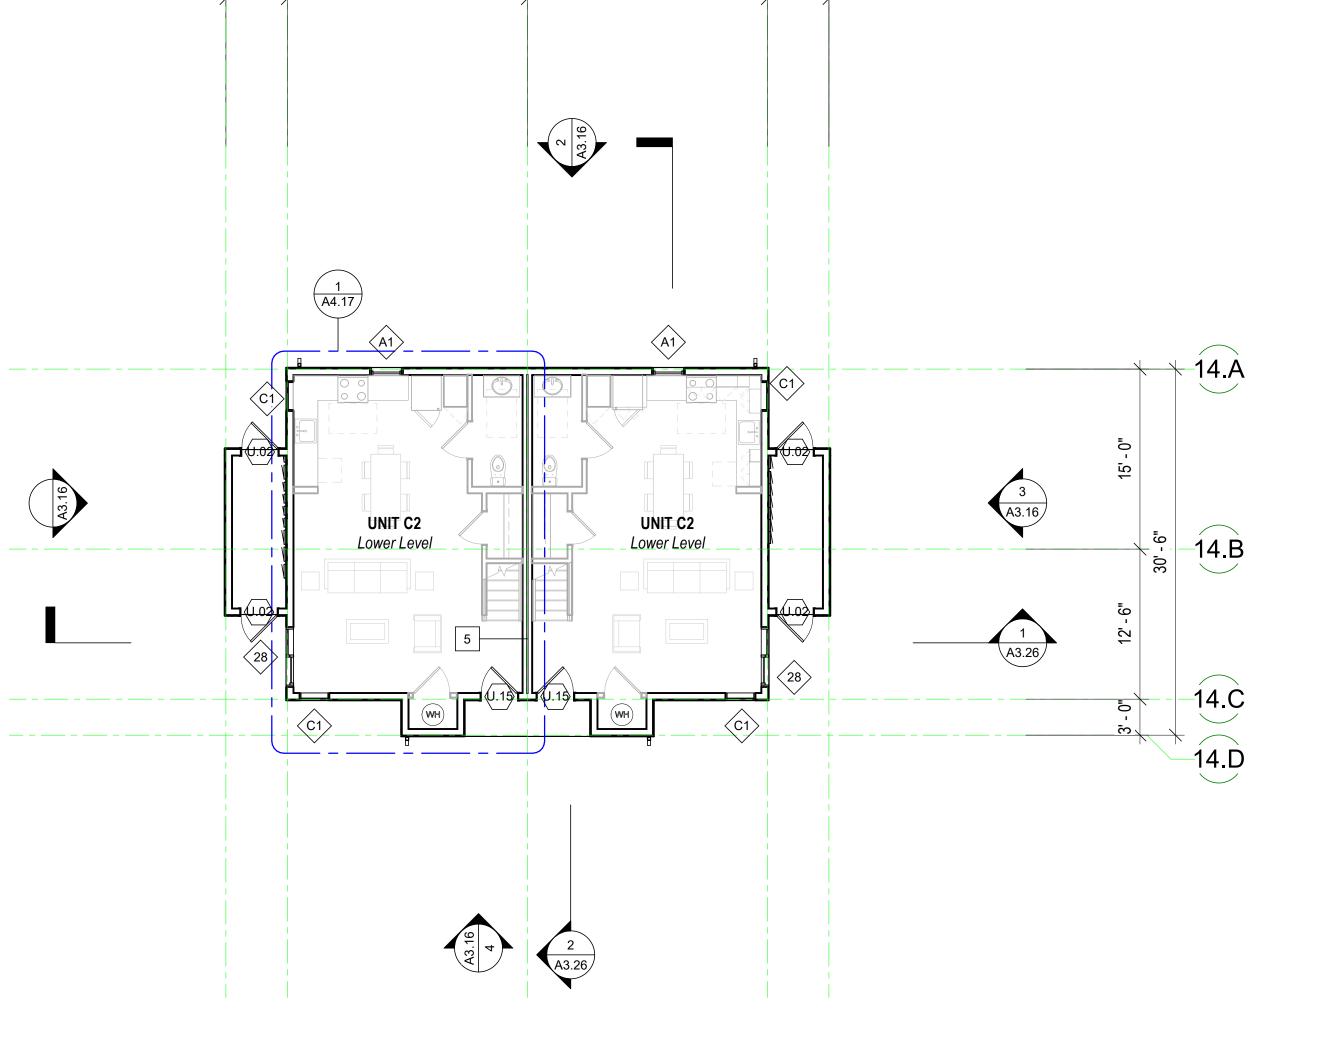

BUILDING 14 - LEVEL 1 FLOOR PLAN (BLDG. 9,11-16 SIM.)
1/8" = 1'-0"

FLOOR PLAN GEN. NOTES

- SEE SHEET G0.00 FOR SYMBOLS & ABBREVIATIONS
 THESE PLANS SHOW UNIQUE INFORMATION ONLY. SEE
- ENLARGED PLANS FOR INFORMATION NOT SHOWN.

 3. REFERENCE ACCESSIBILITY CODE SHEETS **G0.XX** FOR ALL ACCESSIBILITY STANDARDS, REQUIREMENTS AND
- 4. SEE CIVIL PLANS FOR THE BUILDING LOCATION ON SITE AND PRECISE GRADING PLANS.
- FOR PARKING TABULATION REFER TO SHEET GO.XX.
 ALL DIMENSIONS ARE TO FACE OF MASONRY, CONCRETE, STUD, OR CENTERLINE OF COLUMN OR DEMISING WALL (C.L.). U.O.N. ALL "CLEAR" DIMENSIONS ARE TO FACE OF
- 7. ALL CONSTRUCTION TO BE FIRE-RATED PER THE PROJECT DATA ON THE **G0.XX** SHEETS AND ASSEMBLIES, SHEETS **A9.X**. UNIT DEMISING WALLS ARE 1-HR RATED, TYPICAL. FOR DETAILED LOCATION OF WALL ASSEMBLY TYPES, SEE ENLARGED PLANS.
- ALL STAIR, ELEVATOR, TRASH CHUTE, AND VENTILATION SHAFTS TO BE 2-HR FIRE RATED BARRIERS IF CONNECTING MORE THAN 3 STORIES. IF LESS THAN 3 STORIES, THESE MUST BE 1-HR FIRE-RATED CONSTRUCTION.
 FOR DETAIL LOCATION OF WALL ASSEMBLY TYPES, SEE
- BUILDING AND UNIT FLOOR PLANS, SHEETS A2.X, A4.X, & A8X. FOR WALL, FLOOR, FLOOR/CEILING, AND ROOF/CEILING ASSEMBLY TYPES, SEE SHEETS A9.X.

 10. WHERE PROVIDED, CMU PARTITION WALLS TO RECEIVE
- REINFORCING PER STRUCTURAL DRAWINGS AND TERMINATE AT STRUCTURE ABOVE, U.O.N.

 11. ALL INTERIOR EXPOSED CONCRETE WITHIN PUBLIC SPACES
- IS ARCHITECTURAL FINISH, U.O.N.

 12. STUD SIZES TYPICALLY USED THROUGHOUT PROJECT ARE SHOWN REFER TO STUD SIZE ON WALL ASSEMBLIES, SHEET A9.X, FOR REQUIRED SIZES, GAUGES AND SPACING REQUIRED. COORDINATE BLOCKING AND BRACING REQURIEMENTS FOR ALL WALL-HUNT ITEMS AND VERIFY
- LOCATIONS PRIOR TO INSTALLATION OF FINISHES.

 13. THIS BUILDING TO BE FIRE SPRINKLERED PER APPLICABLE SECTIONS OF CBC CHAPTER 9 AND NFPA 13.

 14. CLASS 1 STANDPIPES TO BE INTERCONNECTED.

 15. PROVIDE ALL NECESSARY WALL ACCESS PANELS AS
- REQUIRED FOR MECHANICAL, PLUMBING, FIRE SPRINKLER
 AND ELECTRICAL SYSTEMS. IN FIRE RATED ASSEMBLIES
 PROVIDE RATED ACCESS PANELS WITH SELF CLOSING
 DEVICES.

 16. SEE INDIVIDUAL UNIT FLOOR PLANS OR ENLARGED BUILDING
 PLANS FOR DETAILED INFORMATION ON DIMENSIONS,
- CONSTRUCTION, DOORS, WINDOWS, AND OTHER ELEMENTS, TYPICAL.


 17. INTERIOR FINISHES SHALL COMPLY WITH CBC 803.1 FLAME SPREAD PROVISION, SEE INTERIOR DRAWINGS.
- FOR DOOR & WINDOW SCHEDULES SEE SHEET A9.X & A9.X.
 RAMP SLOPES ARE MEASURED FROM CENTERLINE OF RAMP.
 ALL EXIT STAIRS TO COMPLY WITH CBC CHAPTERS 10, 11A
 AND/OR 11B. EXIT STAIRS AND LANDINGS TO BE 44 INCHES MINIMUM IN WIDTH, STAIR RISERS TO BE MAXIMUM 7 INCHES HIGH, AND TREADS TO BE 11 INCHES MINIMUM DEEP.

 SEE ROOF PLAN GENERAL NOTES FOR DRAINAGE,
- VENTILATION, AND ROOF ACCESS NOTES.

 22. ALL RESIDENTIAL UNITS THAT FACE ROADS ARE EQUIPPED WITH EITHER MECHANICAL VENTILATION OR PASSIVE FRESH-AIR INLETS, SEE MECHANICAL DRAWINGS FOR MORE INFORMATION.
- 23. SEE SIGNAGE PLANS AND DETAILS ON **A10.X** FOR ADDITIONAL INFORMATION REGARDING SIGNS AT UNIT ENTRIES, ELEVATORS, STAIRS, EGRESS COMPONENTS, COMMON AREA DOORS.

FLOOR PLAN KEY

SEE GRAPHIC SYMBOLS LEGEND ON COVER SHEET FOR

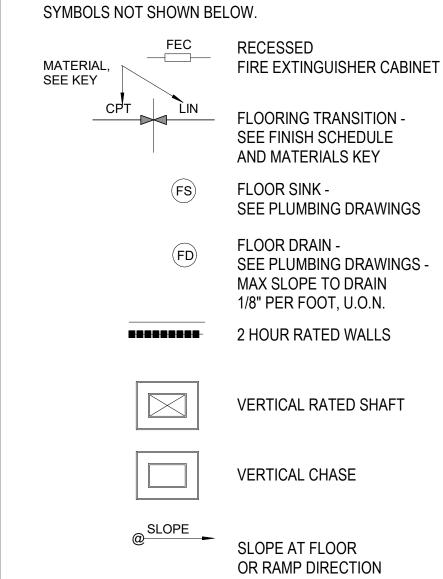


BUILDING KEY PLAN

NUMBER

KEYNOTE LEGEND

KEYNOTE

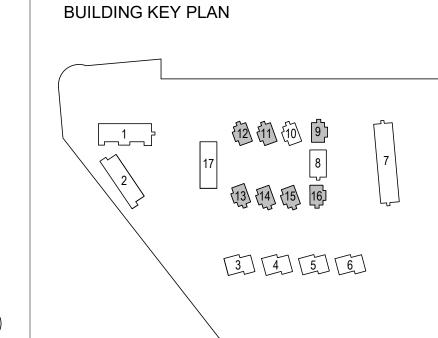

MIDPEN HOUSING
303 Vintage Park Drive

303 Vintage Park Drive Suite 250 Foster City, CA 94404

OAKLAND, CA 94612

www.pyatok.com

510.465.7010 p | 510.465.8575 f

OINT FAMILY COMMUNI

STAMP:


JOB NUMBER: 160
DRAWN BY: GP/S
CHECKED BY: PI
DATE: January 24, 202

SCALE: As indicated

TITLE:

FLOOR & ROOF PLANS BUILDING TYPE F (BUILDINGS 9,
11-16)


A2.17

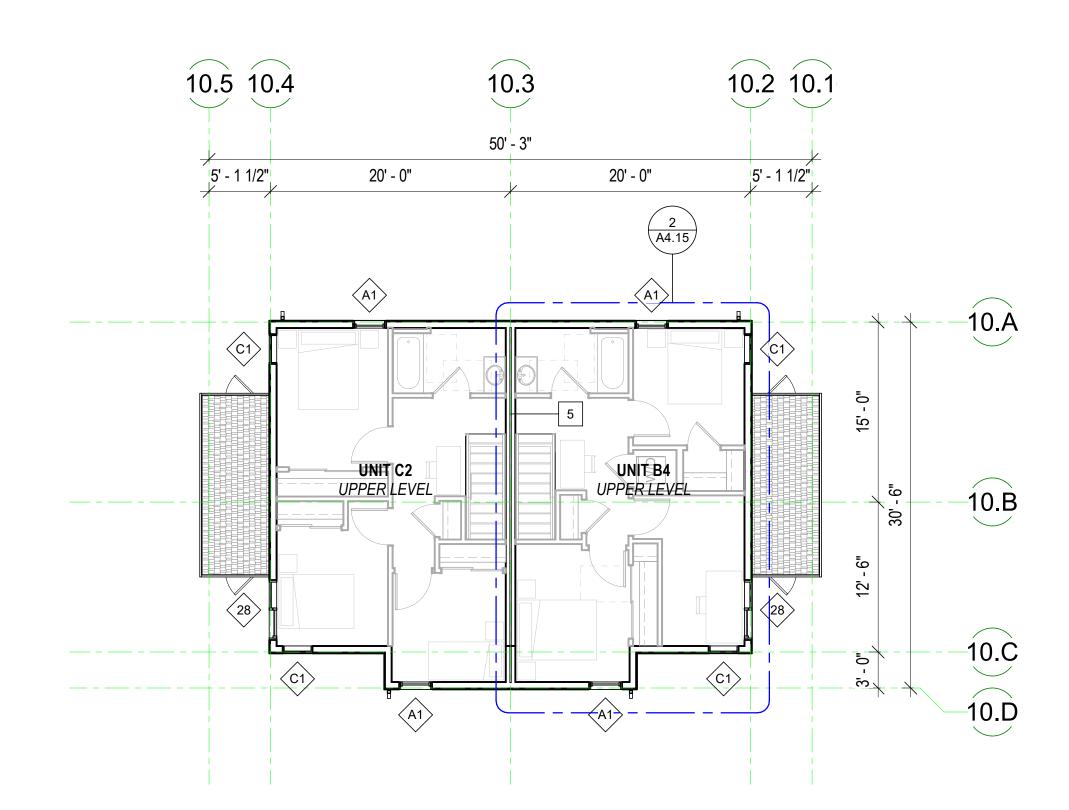

BUILDING 10 - LEVEL 2 FLOOR PLAN

1/8" = 1'-0"

2

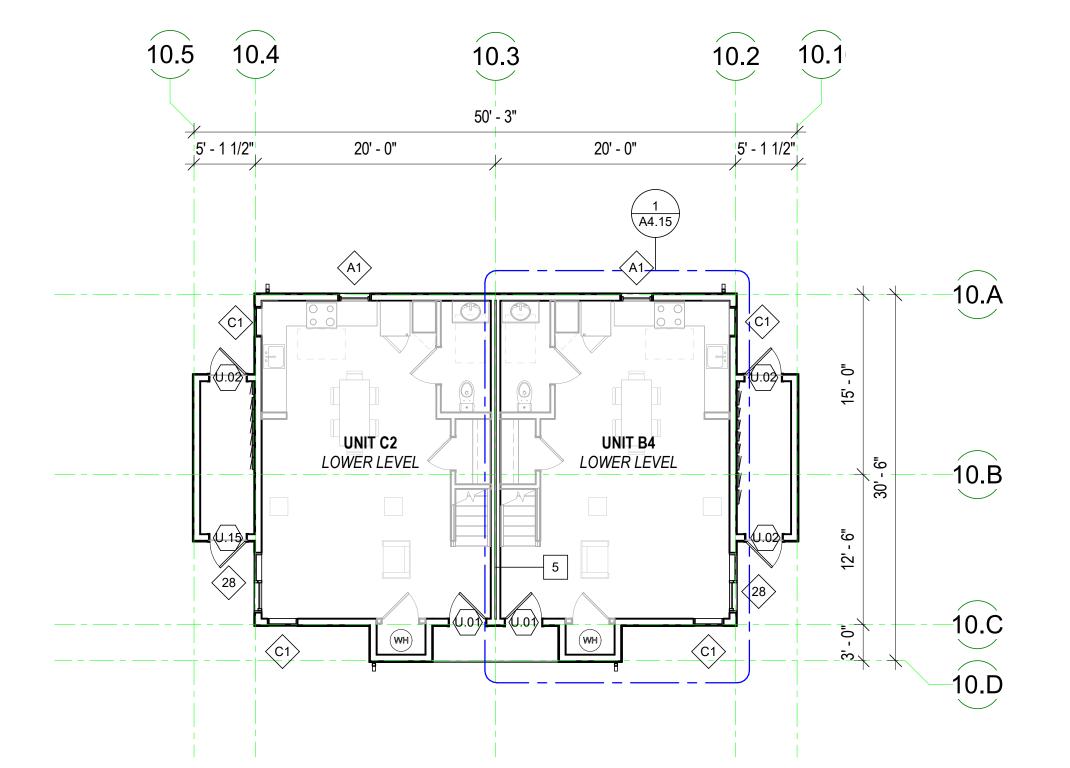

BUILDING 10 - LEVEL 1 FLOOR PLAN
1/8" = 1'-0"

FLOOR PLAN GEN. NOTES


- 1. SEE SHEET **G0.00** FOR SYMBOLS & ABBREVIATIONS 2. THESE PLANS SHOW UNIQUE INFORMATION ONLY. SEE
- ENLARGED PLANS FOR INFORMATION NOT SHOWN. 3. REFERENCE ACCESSIBILITY CODE SHEETS **G0.XX** FOR ALL ACCESSIBILITY STANDARDS, REQUIREMENTS AND DIAGRAMS
- 4. SEE CIVIL PLANS FOR THE BUILDING LOCATION ON SITE AND PRECISE GRADING PLANS.
- 5. FOR PARKING TABULATION REFER TO SHEET **G0.XX**. 6. ALL DIMENSIONS ARE TO FACE OF MASONRY, CONCRETE, STUD, OR CENTERLINE OF COLUMN OR DEMISING WALL (C.L.). U.O.N. ALL "CLEAR" DIMENSIONS ARE TO FACE OF
- 7. ALL CONSTRUCTION TO BE FIRE-RATED PER THE PROJECT DATA ON THE **G0.XX** SHEETS AND ASSEMBLIES, SHEETS A9.X. UNIT DEMISING WALLS ARE 1-HR RATED, TYPICAL. FOR DETAILED LOCATION OF WALL ASSEMBLY TYPES, SEE ENLARGED PLANS.
- 8. ALL STAIR, ELEVATOR, TRASH CHUTE, AND VENTILATION SHAFTS TO BE 2-HR FIRE RATED BARRIERS IF CONNECTING MORE THAN 3 STORIES. IF LESS THAN 3 STORIES, THESE MUST BE 1-HR FIRE-RATED CONSTRUCTION. 9. FOR DETAIL LOCATION OF WALL ASSEMBLY TYPES, SEE
- BUILDING AND UNIT FLOOR PLANS, SHEETS A2.X, A4.X, & A8X. FOR WALL, FLOOR, FLOOR/CEILING, AND ROOF/CEILING ASSEMBLY TYPES, SEE SHEETS A9.X. 10. WHERE PROVIDED, CMU PARTITION WALLS TO RECEIVE
- REINFORCING PER STRUCTURAL DRAWINGS AND TERMINATE AT STRUCTURE ABOVE, U.O.N.
- 11. ALL INTERIOR EXPOSED CONCRETE WITHIN PUBLIC SPACES IS ARCHITECTURAL FINISH, U.O.N. 12. STUD SIZES TYPICALLY USED THROUGHOUT PROJECT ARE SHOWN - REFER TO STUD SIZE ON WALL ASSEMBLIES,

SECTIONS OF CBC CHAPTER 9 AND NFPA 13.

- SHEET A9.X, FOR REQUIRED SIZES, GAUGES AND SPACING REQUIRED. COORDINATE BLOCKING AND BRACING REQURIEMENTS FOR ALL WALL-HUNT ITEMS AND VERIFY LOCATIONS PRIOR TO INSTALLATION OF FINISHES. 13. THIS BUILDING TO BE FIRE SPRINKLERED PER APPLICABLE
- 14. CLASS 1 STANDPIPES TO BE INTERCONNECTED. 15. PROVIDE ALL NECESSARY WALL ACCESS PANELS AS REQUIRED FOR MECHANICAL, PLUMBING, FIRE SPRINKLER AND ELECTRICAL SYSTEMS. IN FIRE RATED ASSEMBLIES PROVIDE RATED ACCESS PANELS WITH SELF CLOSING DEVICES.
- 16. SEE INDIVIDUAL UNIT FLOOR PLANS OR ENLARGED BUILDING PLANS FOR DETAILED INFORMATION ON DIMENSIONS, CONSTRUCTION, DOORS, WINDOWS, AND OTHER ELEMENTS,
- 17. INTERIOR FINISHES SHALL COMPLY WITH **CBC 803.1** FLAME SPREAD PROVISION, SEE INTERIOR DRAWINGS. 18. FOR DOOR & WINDOW SCHEDULES SEE SHEET A9.X & A9.X. 19. RAMP SLOPES ARE MEASURED FROM CENTERLINE OF RAMP. 20. ALL <u>EXIT</u> STAIRS TO COMPLY WITH **CBC CHAPTERS 10, 11A**
- AND/OR 11B. EXIT STAIRS AND LANDINGS TO BE 44 INCHES MINIMUM IN WIDTH, STAIR RISERS TO BE MAXIMUM 7 INCHES HIGH, AND TREADS TO BE 11 INCHES MINIMUM DEEP. 21. SEE ROOF PLAN GENERAL NOTES FOR DRAINAGE,
- VENTILATION, AND ROOF ACCESS NOTES. 22. ALL RESIDENTIAL UNITS THAT FACE ROADS ARE EQUIPPED WITH EITHER MECHANICAL VENTILATION OR PASSIVE FRESH-AIR INLETS, SEE MECHANICAL DRAWINGS FOR MORE INFORMATION.
- 23. SEE SIGNAGE PLANS AND DETAILS ON A10.X FOR ADDITIONAL INFORMATION REGARDING SIGNS AT UNIT ENTRIES, ELEVATORS, STAIRS, EGRESS COMPONENTS, COMMON AREA DOORS.

FLOOR PLAN KEY

SEE GRAPHIC SYMBOLS LEGEND ON COVER SHEET FOR

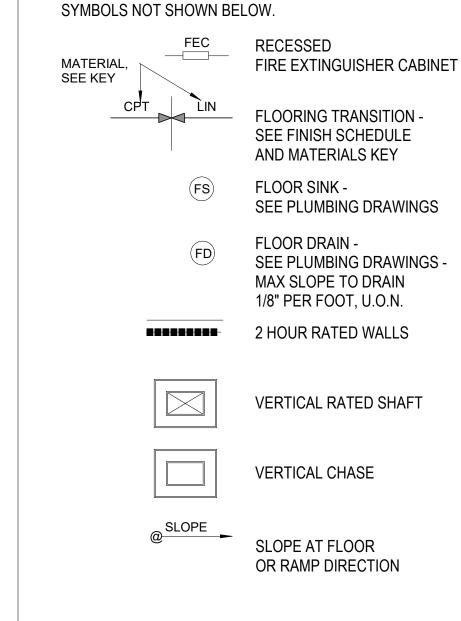

KEYNOTE LEGEND

NUMBER

KEYNOTE

BUILDING KEY PLAN 3 4 5 6 1611 TELEGRAPH AVE. SUITE 200 OAKLAND, CA 94612 510.465.7010 p | 510.465.8575 f www.pyatok.com

MidPen H O U S I N G

MIDPEN HOUSING 303 Vintage Park Drive Suite 250 Foster City, CA 94404

IDMMO

S

Σ

<


REVISION SCHEDULE

STAMP:


NO. ISSUE DATE
4 CDP Resubmittal 12/01/23

JOB NUMBER: DRAWN BY: CHECKED BY

SCALE: FLOOR & ROOF PLANS -**BUILDING TYPE F (BUILDING 10)**

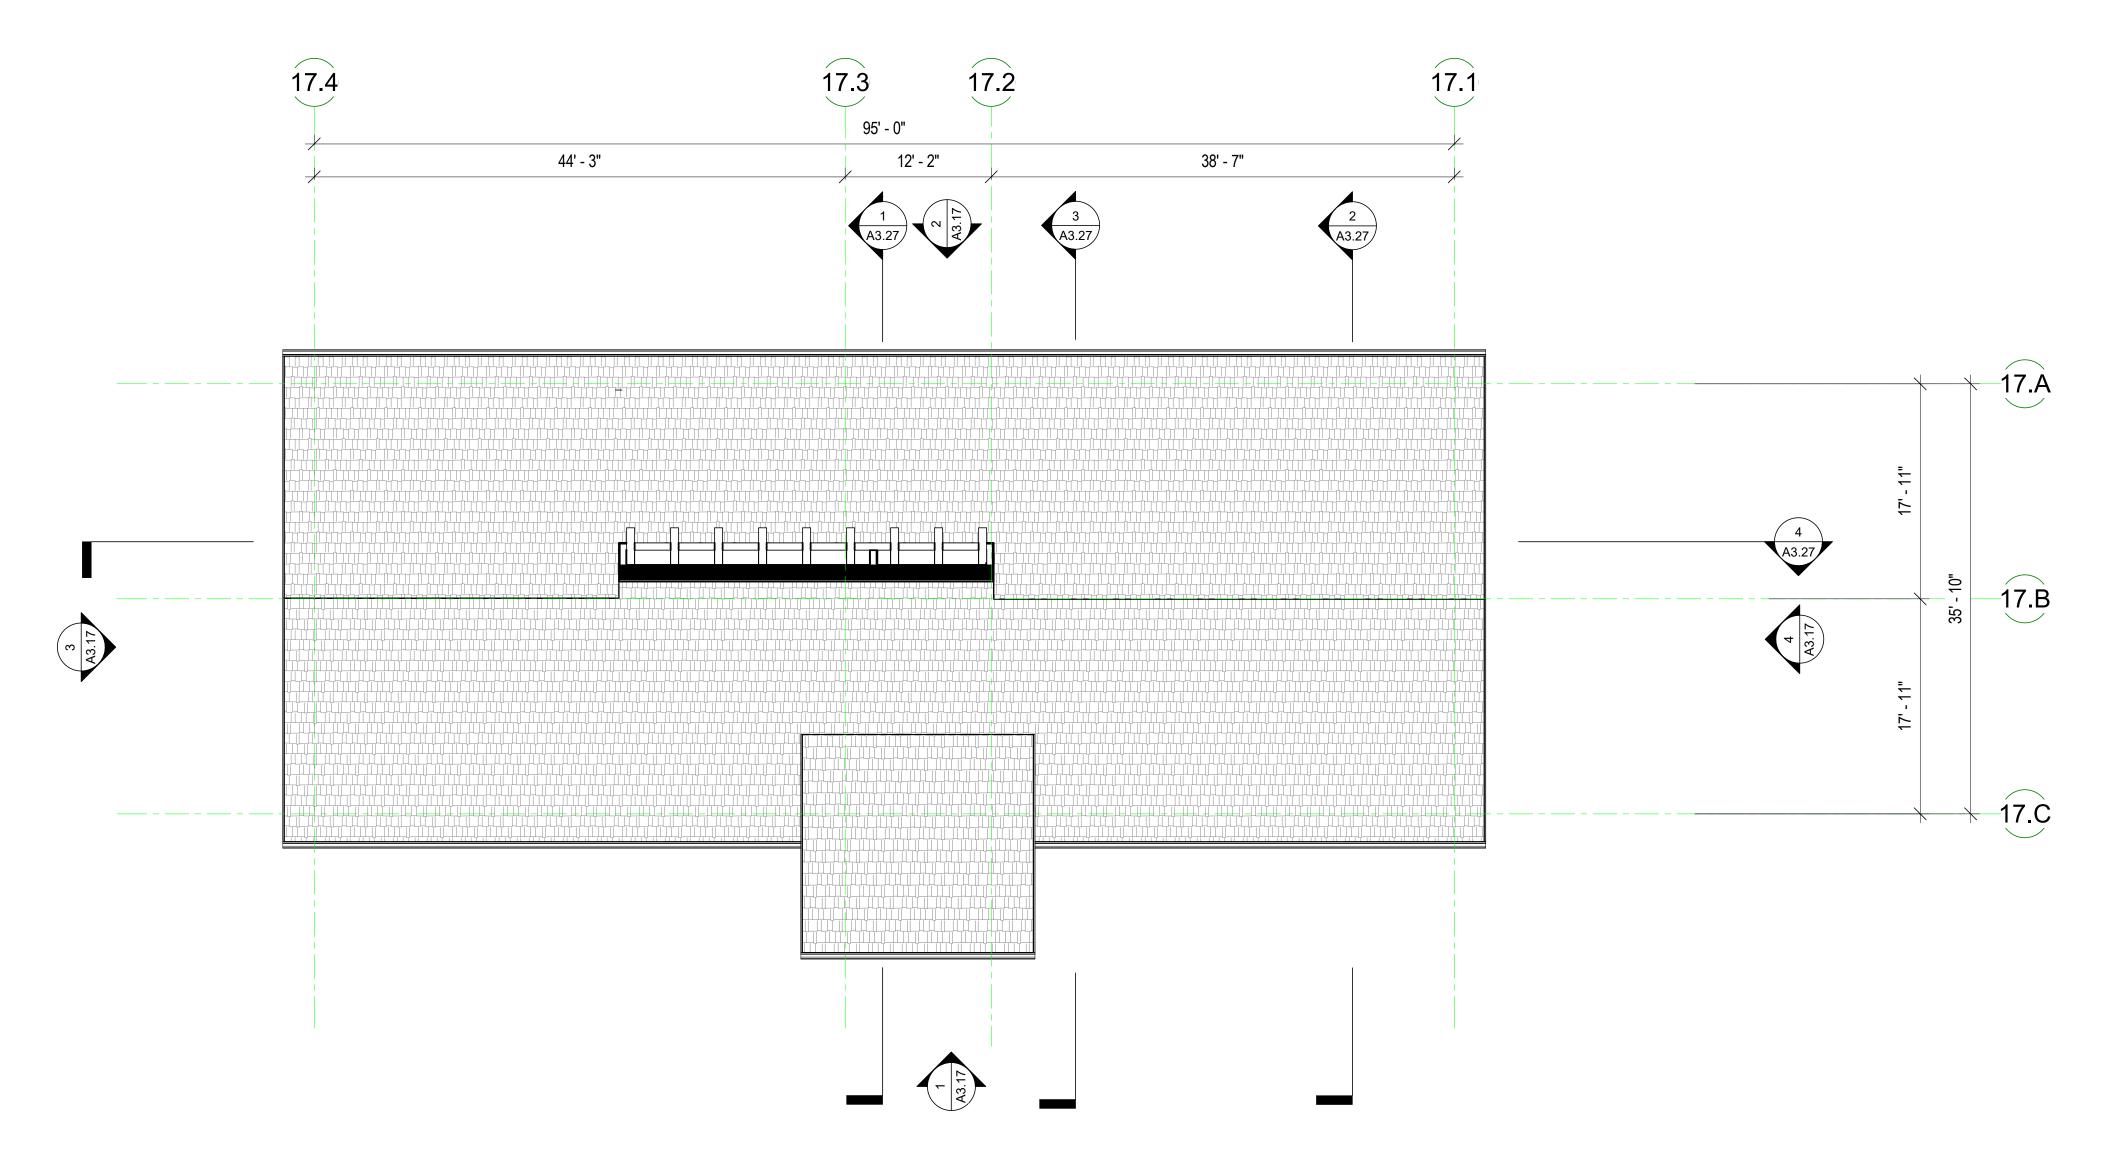

BUILDING 17 - COMMUNITY BLDG - ROOF PLAN
1/8" = 1'-0"
2

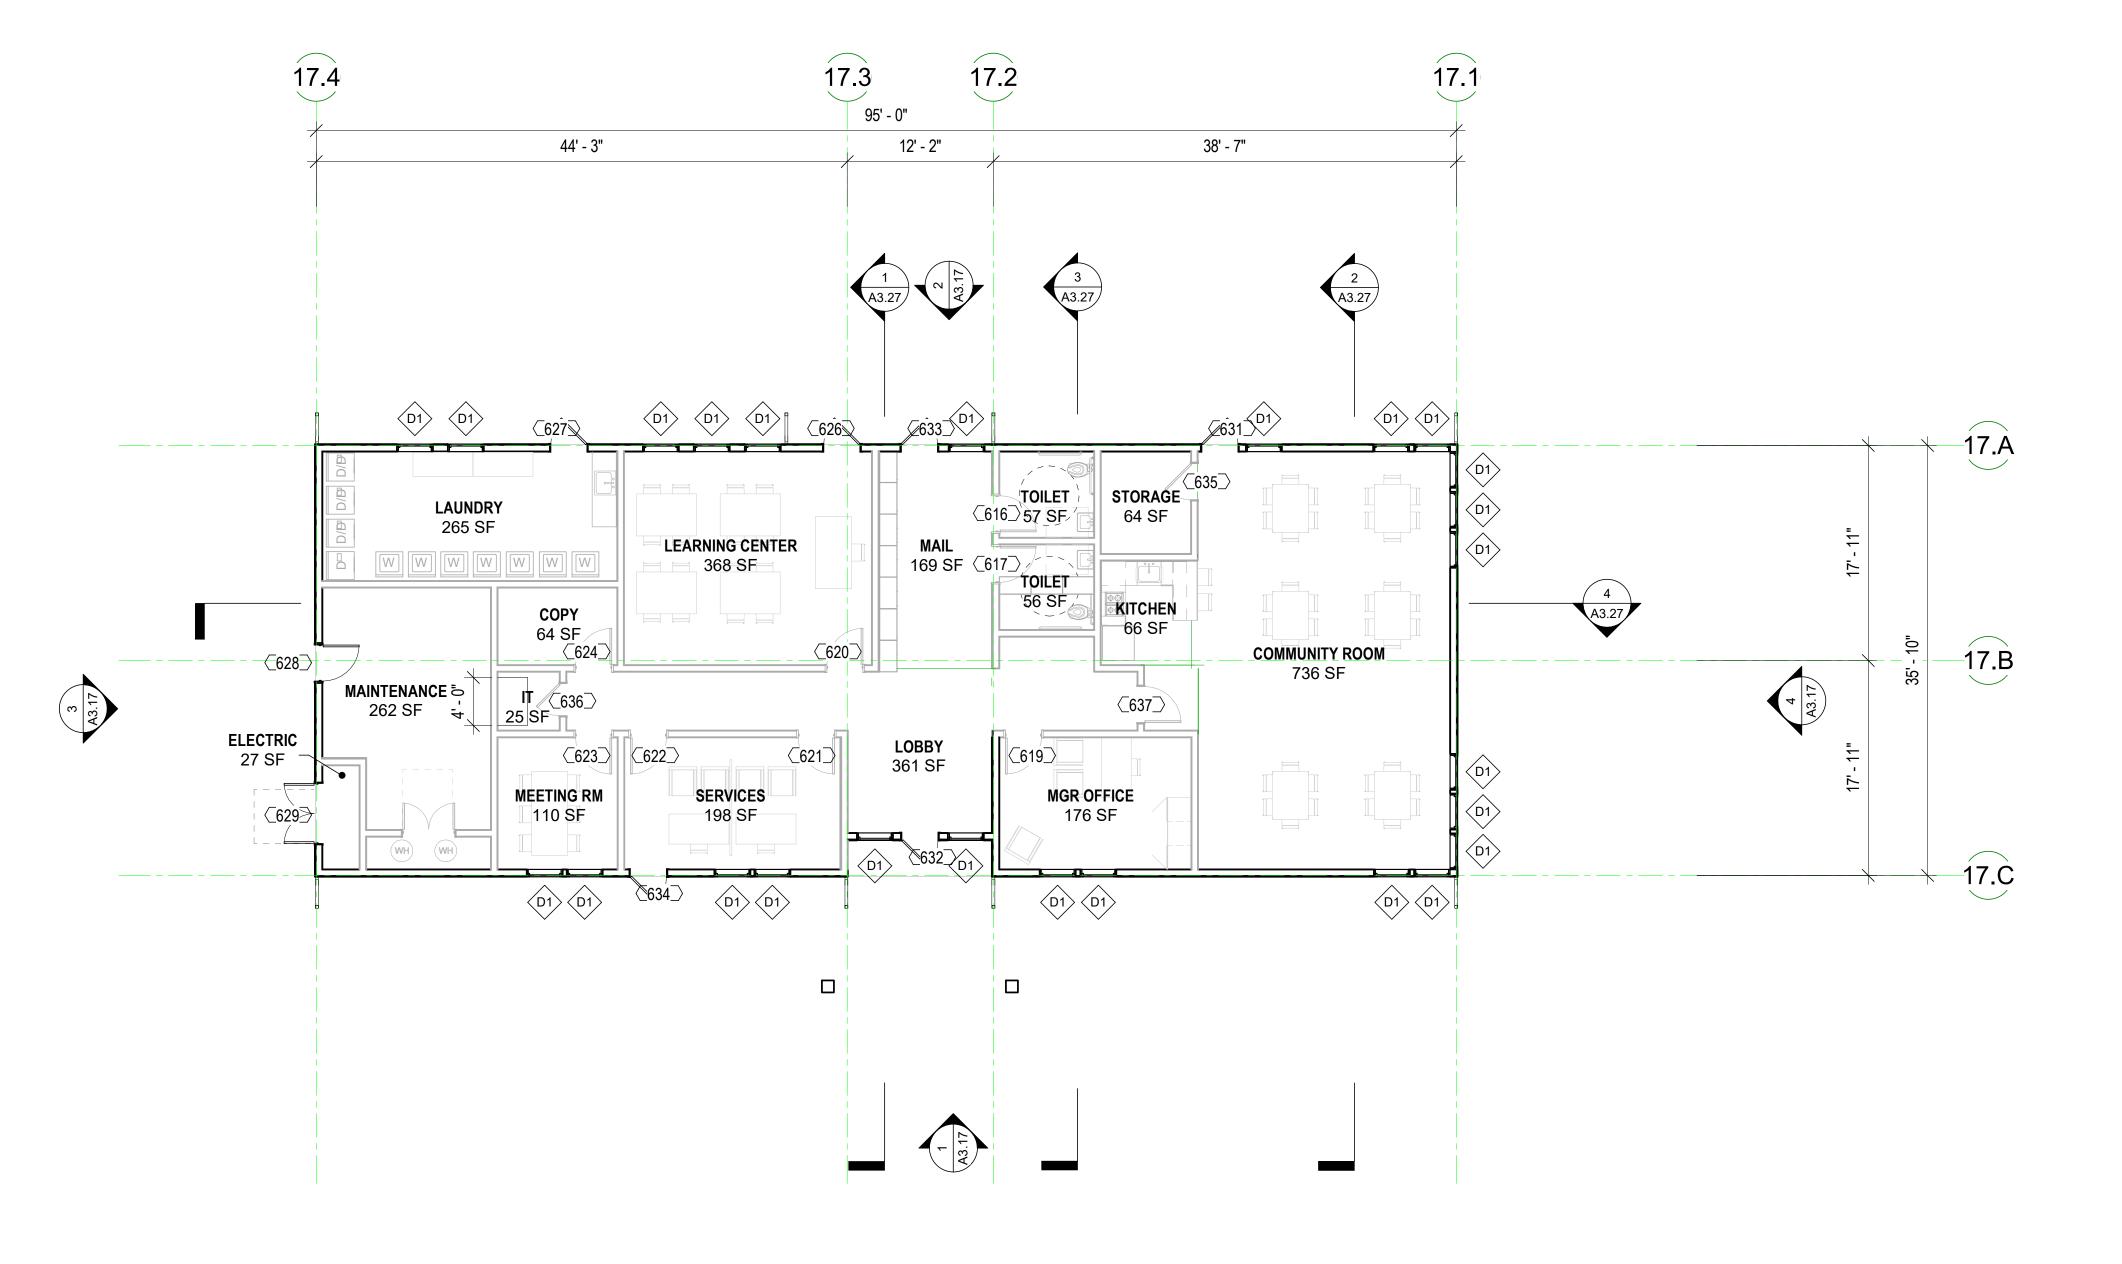

BUILDING 17 - COMMUNITY BLDG - LEVEL 1 FLOOR PLAN
1/8" = 1'-0"

FLOOR PLAN GEN. NOTE PYATOK

1. SEE SHEET **G0.00** FOR SYMBOLS & ABBREVIATIONS 2. THESE PLANS SHOW UNIQUE INFORMATION ONLY. SEE ENLARGED PLANS FOR INFORMATION NOT SHOWN.

3. REFERENCE ACCESSIBILITY CODE SHEETS **G0.XX** FOR ALL ACCESSIBILITY STANDARDS, REQUIREMENTS AND DIAGRAMS

4. SEE CIVIL PLANS FOR THE BUILDING LOCATION ON SITE AND

PRECISE GRADING PLANS. 5. FOR PARKING TABULATION REFER TO SHEET **G0.XX**. 6. ALL DIMENSIONS ARE TO FACE OF MASONRY, CONCRETE, STUD, OR CENTERLINE OF COLUMN OR DEMISING WALL (C.L.). U.O.N. ALL "CLEAR" DIMENSIONS ARE TO FACE OF

7. ALL CONSTRUCTION TO BE FIRE-RATED PER THE PROJECT DATA ON THE **G0.XX** SHEETS AND ASSEMBLIES, SHEETS A9.X. UNIT DEMISING WALLS ARE 1-HR RATED, TYPICAL. FOR DETAILED LOCATION OF WALL ASSEMBLY TYPES, SEE ENLARGED PLANS.

8. ALL STAIR, ELEVATOR, TRASH CHUTE, AND VENTILATION SHAFTS TO BE 2-HR FIRE RATED BARRIERS IF CONNECTING MORE THAN 3 STORIES. IF LESS THAN 3 STORIES, THESE MUST BE 1-HR FIRE-RATED CONSTRUCTION. 9. FOR DETAIL LOCATION OF WALL ASSEMBLY TYPES, SEE

BUILDING AND UNIT FLOOR PLANS, SHEETS A2.X, A4.X, & **A8X.** FOR WALL, FLOOR, FLOOR/CEILING, AND ROOF/CEILING ASSEMBLY TYPES, SEE SHEETS A9.X. 10. WHERE PROVIDED, CMU PARTITION WALLS TO RECEIVE

REINFORCING PER STRUCTURAL DRAWINGS AND TERMINATE AT STRUCTURE ABOVE, U.O.N. 11. ALL INTERIOR EXPOSED CONCRETE WITHIN PUBLIC SPACES

IS ARCHITECTURAL FINISH, U.O.N. 12. STUD SIZES TYPICALLY USED THROUGHOUT PROJECT ARE SHOWN - REFER TO STUD SIZE ON WALL ASSEMBLIES, SHEET A9.X, FOR REQUIRED SIZES, GAUGES AND SPACING REQUIRED. COORDINATE BLOCKING AND BRACING REQURIEMENTS FOR ALL WALL-HUNT ITEMS AND VERIFY

LOCATIONS PRIOR TO INSTALLATION OF FINISHES. 13. THIS BUILDING TO BE FIRE SPRINKLERED PER APPLICABLE SECTIONS OF CBC CHAPTER 9 AND NFPA 13. 14. CLASS 1 STANDPIPES TO BE INTERCONNECTED.

15. PROVIDE ALL NECESSARY WALL ACCESS PANELS AS REQUIRED FOR MECHANICAL, PLUMBING, FIRE SPRINKLER AND ELECTRICAL SYSTEMS. IN FIRE RATED ASSEMBLIES PROVIDE RATED ACCESS PANELS WITH SELF CLOSING DEVICES.

16. SEE INDIVIDUAL UNIT FLOOR PLANS OR ENLARGED BUILDING PLANS FOR DETAILED INFORMATION ON DIMENSIONS, CONSTRUCTION, DOORS, WINDOWS, AND OTHER ELEMENTS, 17. INTERIOR FINISHES SHALL COMPLY WITH **CBC 803.1** FLAME

SPREAD PROVISION, SEE INTERIOR DRAWINGS. 18. FOR DOOR & WINDOW SCHEDULES SEE SHEET A9.X & A9.X. 19. RAMP SLOPES ARE MEASURED FROM CENTERLINE OF RAMP.


20. ALL EXIT STAIRS TO COMPLY WITH CBC CHAPTERS 10, 11A AND/OR 11B. EXIT STAIRS AND LANDINGS TO BE 44 INCHES MINIMUM IN WIDTH, STAIR RISERS TO BE MAXIMUM 7 INCHES HIGH, AND TREADS TO BE 11 INCHES MINIMUM DEEP. 21. SEE ROOF PLAN GENERAL NOTES FOR DRAINAGE, VENTILATION, AND ROOF ACCESS NOTES.

22. ALL RESIDENTIAL UNITS THAT FACE ROADS ARE EQUIPPED WITH EITHER MECHANICAL VENTILATION OR PASSIVE FRESH-AIR INLETS, SEE MECHANICAL DRAWINGS FOR MORE INFORMATION.

23. SEE SIGNAGE PLANS AND DETAILS ON A10.X FOR ADDITIONAL INFORMATION REGARDING SIGNS AT UNIT ENTRIES, ELEVATORS, STAIRS, EGRESS COMPONENTS, COMMON AREA DOORS.

FLOOR PLAN KEY

SEE GRAPHIC SYMBOLS LEGEND ON COVER SHEET FOR

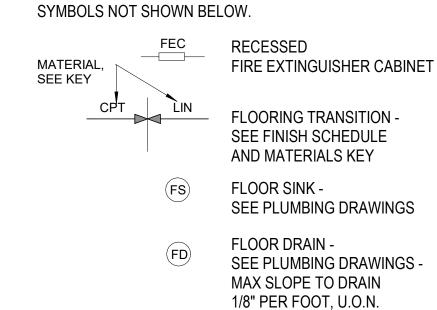


VERTICAL RATED SHAFT

SLOPE AT FLOOR OR RAMP DIRECTION

2 HOUR RATED WALLS

VERTICAL CHASE

KEYNOTE LEGEND KEYNOTE NUMBER

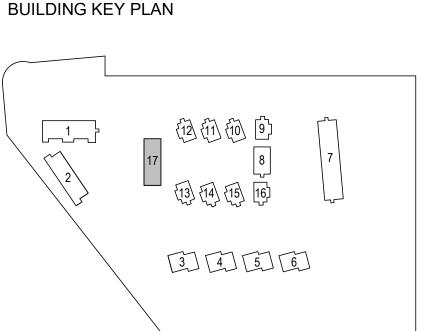

JOB NUMBER: DRAWN BY: **CHECKED BY** SCALE:

FLOOR & ROOF PLANS -COMMUNITY BUILDING (BUILDING 17)

© 2023 PYATOK ARCHITECTURE & URBAN DESIGN

www.pyatok.com

510.465.7010 p | 510.465.8575 f

MidPen H O U S I N G

MIDPEN HOUSING

OAKLAND, CA 94612

303 Vintage Park Drive Suite 250 Foster City, CA 94404

4 S

STAMP:

REVISION SCHEDULE



- 1. SEE SHEET **G0.00** FOR SYMBOLS & ABBREVIATIONS. 2. THESE ELEVATIONS SHOW OVERALL INFORMATION AND UNIT-TO-UNIT RELATIONSHIPS ONLY, SEE ENLARGED
- ELEVATIONS FOR INFORMATION NOT SHOWN. 3. ALL CONTROL JOINTS AND FINISH MATERIALS SHALL WRAP AROUND CORNERS AND CONTINUE ONTO ADJACENT WALLS WHETHER SHOWN OR NOT, UNLESS NOTED OTHERWISE. PER <u>ASTM C 1063</u> INSTALL CONTROL JOINTS WHERE AN EXPANSION JOINT OCCURS IN THE BASE EXTERIOR WALL. INSTALL CONTROL JOINTS WHERE CEILING FRAMING OR FURRING CHANGES DIRECTION.
- 4. PER ASTM C 1063, EXTERIOR PLASTER CONTROL JOINTS TO BE INSTALLED IN VERTICAL SURFACES EXCEEDING 144 SQUARE FEET IN AREA AND HORIZONTAL SURFACES EXCEEDING 100 SQUARE FEET IN AREA. DISTANCE BETWEEN CONTROL JOINTS SHALL NOT EXCEED 18 FEET IN EITHER DIRECTION OR A LENGTH-TO-WIDTH RATIO OF 2.5 TO
- 5. ALL WEEP SCREED LINES SHALL BE LEVEL AND STEP WITH ADJACENT GRADE. STEPPING OF WEEP SCREED TO OCCUR AT INSIDE CORNERS. BOTTOM EDGE OF WEEP SCREED SHALL BE INSTALLED NOT LESS THAN 1 INCH BELOW THE JOINT FORMED BY THE FOUNDATION AND FRAMING. NOSE OF SCREED SHALL BE PLACED 6 INCHES MINIMUM ABOVE GRADE OR 2 INCHES MINIMUM ABOVE PAVED SURFACE.
- 6. ALL WINDOW HEAD HEIGHTS TO BE X'-XX" FROM TOP OF SHEATHING AT WOOD STRUCTURE AND X'-XX" AT CONCRETE, TYPICAL, U.O.N. 7. ALL EXTERIOR WALL PENETRATIONS SHALL BE SEALED.
- 8. ALL GUTTERS SHALL BE LEVEL U.O.N. AND RAINWATER LEADERS SHALL VERTICALLY ALIGN WITH WALLS INCLUDING PRIVATE DECKS AND STAIRS OPENINGS 9. REFER TO WINDOW SCHEDULE FOR WINDOW STC RATINGS.
- 10. REFER TO MECHANICAL, PLUMBING, ELECTRICAL, AND STRUCTURAL DRAWINGS FOR ADDITIONAL INFORMATION. 11. FRAMING SUB-CONTRACTOR SHALL REVIEW AND COORDINATE EXTERIOR LIGHTING AND SIGNAGE LOCATIONS AND SHALL PROVIDE SOLID BLOCKING WHERE
- REQUIRED. 12. FAÇADE ACCESS PLAN SHALL BE PROVIDED BY OWNER TO COMPLY WITH OSHA REGULATIONS FOR BUILDING MAINTENANCE.
- 13. CONTRACTOR IS RESPONSIBLE FOR BRINGING ANY CONFLICTS AND/OR DISCREPANCIES TO THE ATTENTION OF THE ARCHITECT.
- 14. ALL LEVELS ARE TO TOP OF PLYWOOD SUBFLOOR OR TOP OF STRUCTURAL CONCRETE, U.O.N. 15. FOR DOOR AND WINDOW TYPES AND SIZES, SEE
- SCHEDULES AND LEGENDS ON A9.XX AND A9.XX. 16. SEE COLOR LEGEND ON SHEET **G0.XX** FOR PAINT SCHEDULE.

KEYNOTE LEGEND NUMBER KEYNOTE

[3] [4] [5] [6]

STAMP:

OAKLAND, CA 94612

www.pyatok.com

Suite 250

510.465.7010 p | 510.465.8575 f

MidPen H O U S I N G

MIDPEN HOUSING

303 Vintage Park Drive

Foster City, CA 94404

LINOMMO

1

REVISION SCHEDULE
 NO.
 ISSUE
 DATE

 1
 Planning Resubmittal
 03/25/19

 2
 Adjusted Heights
 07/10/20

 3
 Coastal Development Permit
 06/21/22


 4
 CDP Resubmittal
 12/01/23

JOB NUMBER: DRAWN BY: CHECKED BY SCALE:

ELEVATIONS - BUILDING TYPE A

© 2023 PYATOK ARCHITECTURE & URBAN DESIGN

(BUILDING 1)

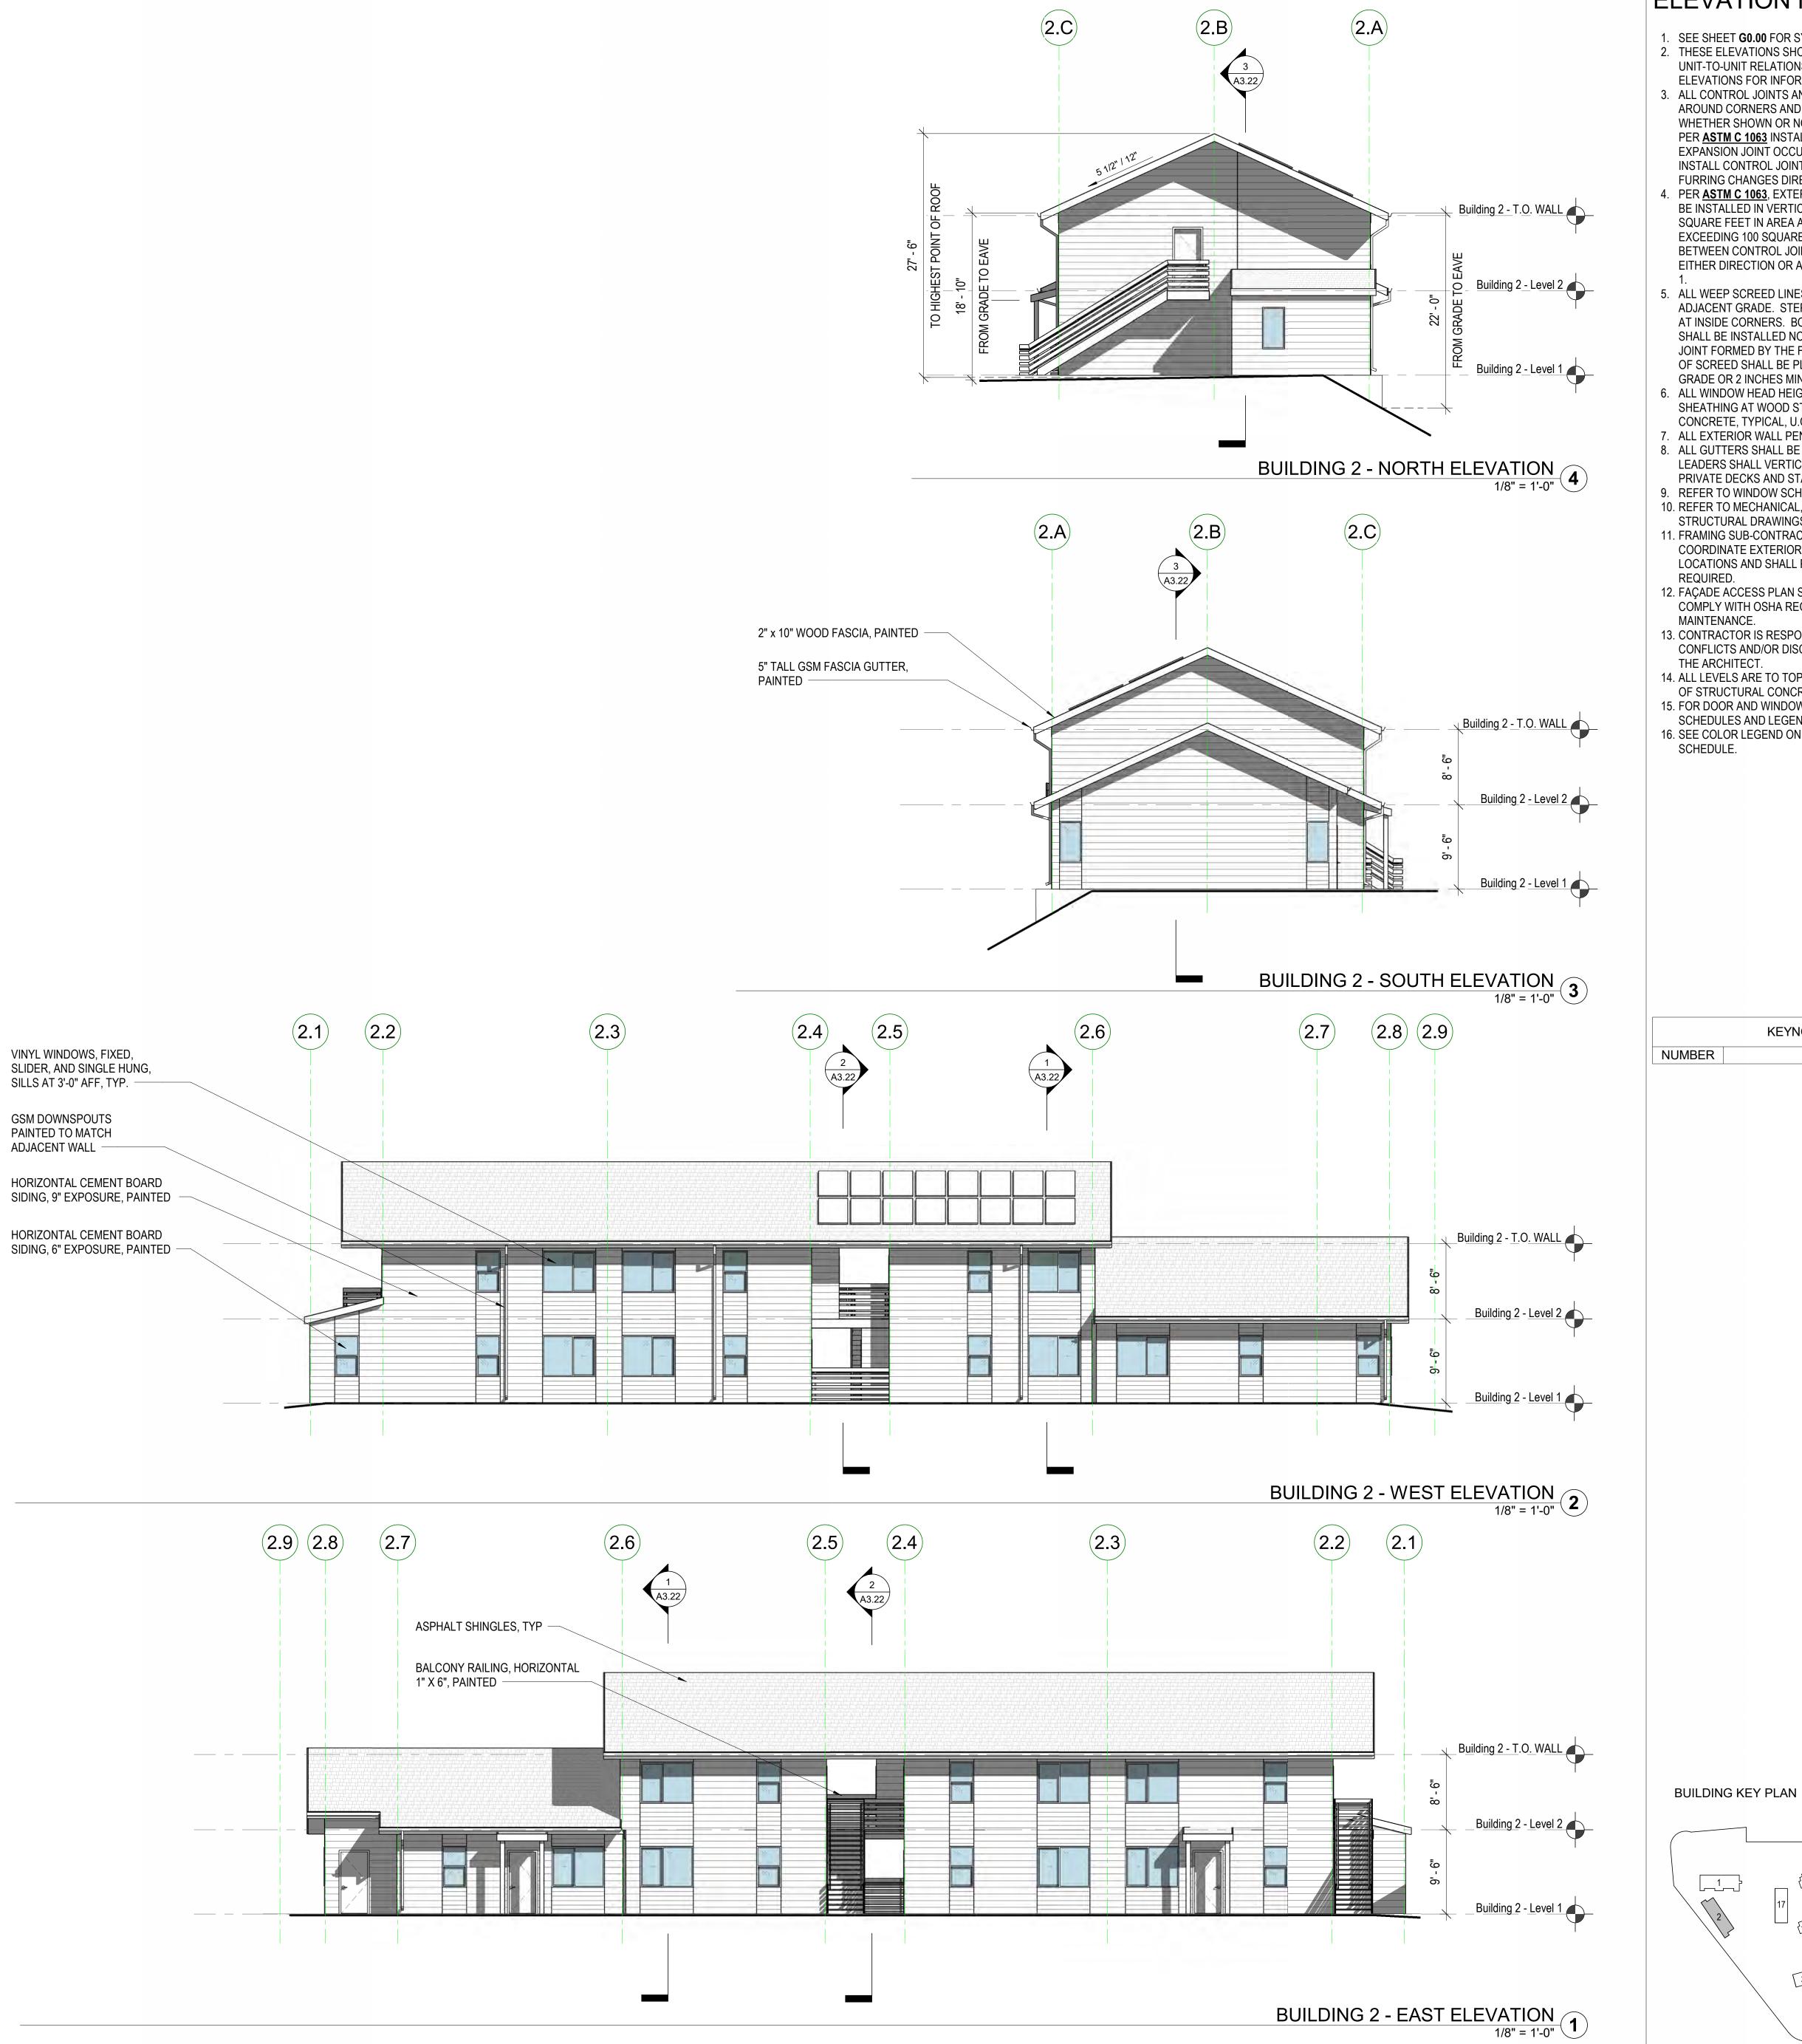

- 1. SEE SHEET **G0.00** FOR SYMBOLS & ABBREVIATIONS. 2. THESE ELEVATIONS SHOW OVERALL INFORMATION AND UNIT-TO-UNIT RELATIONSHIPS ONLY, SEE ENLARGED ELEVATIONS FOR INFORMATION NOT SHOWN.
- 3. ALL CONTROL JOINTS AND FINISH MATERIALS SHALL WRAP AROUND CORNERS AND CONTINUE ONTO ADJACENT WALLS WHETHER SHOWN OR NOT, UNLESS NOTED OTHERWISE. PER <u>ASTM C 1063</u> INSTALL CONTROL JOINTS WHERE AN EXPANSION JOINT OCCURS IN THE BASE EXTERIOR WALL. INSTALL CONTROL JOINTS WHERE CEILING FRAMING OR FURRING CHANGES DIRECTION.

OAKLAND, CA 94612

www.pyatok.com

Suite 250

510.465.7010 p | 510.465.8575 f

MidPen H O U S I N G

MIDPEN HOUSING

303 Vintage Park Drive

Foster City, CA 94404

LINOMMO

1

S

- 4. PER ASTM C 1063, EXTERIOR PLASTER CONTROL JOINTS TO BE INSTALLED IN VERTICAL SURFACES EXCEEDING 144 SQUARE FEET IN AREA AND HORIZONTAL SURFACES EXCEEDING 100 SQUARE FEET IN AREA. DISTANCE BETWEEN CONTROL JOINTS SHALL NOT EXCEED 18 FEET IN EITHER DIRECTION OR A LENGTH-TO-WIDTH RATIO OF 2.5 TO
- 5. ALL WEEP SCREED LINES SHALL BE LEVEL AND STEP WITH ADJACENT GRADE. STEPPING OF WEEP SCREED TO OCCUR AT INSIDE CORNERS. BOTTOM EDGE OF WEEP SCREED SHALL BE INSTALLED NOT LESS THAN 1 INCH BELOW THE JOINT FORMED BY THE FOUNDATION AND FRAMING. NOSE OF SCREED SHALL BE PLACED 6 INCHES MINIMUM ABOVE GRADE OR 2 INCHES MINIMUM ABOVE PAVED SURFACE.
- 6. ALL WINDOW HEAD HEIGHTS TO BE X'-XX" FROM TOP OF SHEATHING AT WOOD STRUCTURE AND X'-XX" AT CONCRETE, TYPICAL, U.O.N. 7. ALL EXTERIOR WALL PENETRATIONS SHALL BE SEALED.
- 8. ALL GUTTERS SHALL BE LEVEL U.O.N. AND RAINWATER LEADERS SHALL VERTICALLY ALIGN WITH WALLS INCLUDING PRIVATE DECKS AND STAIRS OPENINGS 9. REFER TO WINDOW SCHEDULE FOR WINDOW STC RATINGS.
- 10. REFER TO MECHANICAL, PLUMBING, ELECTRICAL, AND STRUCTURAL DRAWINGS FOR ADDITIONAL INFORMATION. 11. FRAMING SUB-CONTRACTOR SHALL REVIEW AND COORDINATE EXTERIOR LIGHTING AND SIGNAGE LOCATIONS AND SHALL PROVIDE SOLID BLOCKING WHERE
- REQUIRED. 12. FAÇADE ACCESS PLAN SHALL BE PROVIDED BY OWNER TO COMPLY WITH OSHA REGULATIONS FOR BUILDING
- MAINTENANCE. 13. CONTRACTOR IS RESPONSIBLE FOR BRINGING ANY CONFLICTS AND/OR DISCREPANCIES TO THE ATTENTION OF
- 14. ALL LEVELS ARE TO TOP OF PLYWOOD SUBFLOOR OR TOP OF STRUCTURAL CONCRETE, U.O.N. 15. FOR DOOR AND WINDOW TYPES AND SIZES, SEE
- SCHEDULES AND LEGENDS ON A9.XX AND A9.XX. 16. SEE COLOR LEGEND ON SHEET **G0.XX** FOR PAINT SCHEDULE.

KEYNOTE LEGEND NUMBER KEYNOTE

2

[3] [4] [5] [6]

REVISION SCHEDULE
 NO.
 ISSUE
 DATE

 1
 Planning Resubmittal
 03/25/19

 2
 Adjusted Heights
 07/10/20

 3
 Coastal Development Permit
 06/21/22

 4
 CDP Resubmittal
 12/01/23

STAMP:

JOB NUMBER: DRAWN BY: CHECKED BY SCALE:

ELEVATIONS - BUILDING TYPE B (BUILDING 2)

- 1. SEE SHEET **G0.00** FOR SYMBOLS & ABBREVIATIONS. 2. THESE ELEVATIONS SHOW OVERALL INFORMATION AND UNIT-TO-UNIT RELATIONSHIPS ONLY, SEE ENLARGED ELEVATIONS FOR INFORMATION NOT SHOWN.
- 3. ALL CONTROL JOINTS AND FINISH MATERIALS SHALL WRAP AROUND CORNERS AND CONTINUE ONTO ADJACENT WALLS WHETHER SHOWN OR NOT, UNLESS NOTED OTHERWISE. PER <u>ASTM C 1063</u> INSTALL CONTROL JOINTS WHERE AN EXPANSION JOINT OCCURS IN THE BASE EXTERIOR WALL. INSTALL CONTROL JOINTS WHERE CEILING FRAMING OR FURRING CHANGES DIRECTION.
- 4. PER ASTM C 1063, EXTERIOR PLASTER CONTROL JOINTS TO BE INSTALLED IN VERTICAL SURFACES EXCEEDING 144 SQUARE FEET IN AREA AND HORIZONTAL SURFACES EXCEEDING 100 SQUARE FEET IN AREA. DISTANCE BETWEEN CONTROL JOINTS SHALL NOT EXCEED 18 FEET IN EITHER DIRECTION OR A LENGTH-TO-WIDTH RATIO OF 2.5 TO
- 5. ALL WEEP SCREED LINES SHALL BE LEVEL AND STEP WITH ADJACENT GRADE. STEPPING OF WEEP SCREED TO OCCUR AT INSIDE CORNERS. BOTTOM EDGE OF WEEP SCREED SHALL BE INSTALLED NOT LESS THAN 1 INCH BELOW THE JOINT FORMED BY THE FOUNDATION AND FRAMING. NOSE OF SCREED SHALL BE PLACED 6 INCHES MINIMUM ABOVE GRADE OR 2 INCHES MINIMUM ABOVE PAVED SURFACE. 6. ALL WINDOW HEAD HEIGHTS TO BE X'-XX" FROM TOP OF
- SHEATHING AT WOOD STRUCTURE AND X'-XX" AT CONCRETE, TYPICAL, U.O.N. 7. ALL EXTERIOR WALL PENETRATIONS SHALL BE SEALED. 8. ALL GUTTERS SHALL BE LEVEL U.O.N. AND RAINWATER
- LEADERS SHALL VERTICALLY ALIGN WITH WALLS INCLUDING PRIVATE DECKS AND STAIRS OPENINGS 9. REFER TO WINDOW SCHEDULE FOR WINDOW STC RATINGS. 10. REFER TO MECHANICAL, PLUMBING, ELECTRICAL, AND
- STRUCTURAL DRAWINGS FOR ADDITIONAL INFORMATION. 11. FRAMING SUB-CONTRACTOR SHALL REVIEW AND COORDINATE EXTERIOR LIGHTING AND SIGNAGE LOCATIONS AND SHALL PROVIDE SOLID BLOCKING WHERE REQUIRED.
- 12. FAÇADE ACCESS PLAN SHALL BE PROVIDED BY OWNER TO COMPLY WITH OSHA REGULATIONS FOR BUILDING MAINTENANCE.
- CONFLICTS AND/OR DISCREPANCIES TO THE ATTENTION OF THE ARCHITECT. 14. ALL LEVELS ARE TO TOP OF PLYWOOD SUBFLOOR OR TOP

13. CONTRACTOR IS RESPONSIBLE FOR BRINGING ANY

- OF STRUCTURAL CONCRETE, U.O.N. 15. FOR DOOR AND WINDOW TYPES AND SIZES, SEE SCHEDULES AND LEGENDS ON A9.XX AND A9.XX.
- 16. SEE COLOR LEGEND ON SHEET **G0.XX** FOR PAINT SCHEDULE.

KEYNOTE LEGEND NUMBER KEYNOTE

3 4 5 6

STAMP:

REVISION SCHEDULE

JOB NUMBER: DRAWN BY: **BUILDING KEY PLAN** CHECKED BY: January 24, 2024 SCALE: As indicated (BUILDINGS 3-6)

© 2023 PYATOK ARCHITECTURE & URBAN DESIGN

INDMMO

1

S

S

OAKLAND, CA 94612

www.pyatok.com

Suite 250

510.465.7010 p | 510.465.8575 f

MidPen H O U S I N G

MIDPEN HOUSING

303 Vintage Park Drive

Foster City, CA 94404

ELEVATIONS - BUILDING TYPE C



- 1. SEE SHEET **G0.00** FOR SYMBOLS & ABBREVIATIONS. 2. THESE ELEVATIONS SHOW OVERALL INFORMATION AND UNIT-TO-UNIT RELATIONSHIPS ONLY, SEE ENLARGED ELEVATIONS FOR INFORMATION NOT SHOWN.
- 3. ALL CONTROL JOINTS AND FINISH MATERIALS SHALL WRAP AROUND CORNERS AND CONTINUE ONTO ADJACENT WALLS WHETHER SHOWN OR NOT, UNLESS NOTED OTHERWISE. PER <u>ASTM C 1063</u> INSTALL CONTROL JOINTS WHERE AN EXPANSION JOINT OCCURS IN THE BASE EXTERIOR WALL. INSTALL CONTROL JOINTS WHERE CEILING FRAMING OR FURRING CHANGES DIRECTION.

OAKLAND, CA 94612

www.pyatok.com

Suite 250

510.465.7010 p | 510.465.8575 f

MidPen H O U S I N G

MIDPEN HOUSING

303 Vintage Park Drive

Foster City, CA 94404

INDMMO

Щ

POINT

S

- 4. PER ASTM C 1063, EXTERIOR PLASTER CONTROL JOINTS TO BE INSTALLED IN VERTICAL SURFACES EXCEEDING 144 SQUARE FEET IN AREA AND HORIZONTAL SURFACES EXCEEDING 100 SQUARE FEET IN AREA. DISTANCE BETWEEN CONTROL JOINTS SHALL NOT EXCEED 18 FEET IN EITHER DIRECTION OR A LENGTH-TO-WIDTH RATIO OF 2.5 TO
- 5. ALL WEEP SCREED LINES SHALL BE LEVEL AND STEP WITH ADJACENT GRADE. STEPPING OF WEEP SCREED TO OCCUR AT INSIDE CORNERS. BOTTOM EDGE OF WEEP SCREED SHALL BE INSTALLED NOT LESS THAN 1 INCH BELOW THE JOINT FORMED BY THE FOUNDATION AND FRAMING. NOSE OF SCREED SHALL BE PLACED 6 INCHES MINIMUM ABOVE GRADE OR 2 INCHES MINIMUM ABOVE PAVED SURFACE.
- 6. ALL WINDOW HEAD HEIGHTS TO BE X'-XX" FROM TOP OF SHEATHING AT WOOD STRUCTURE AND X'-XX" AT CONCRETE, TYPICAL, U.O.N. 7. ALL EXTERIOR WALL PENETRATIONS SHALL BE SEALED.
- 8. ALL GUTTERS SHALL BE LEVEL U.O.N. AND RAINWATER LEADERS SHALL VERTICALLY ALIGN WITH WALLS INCLUDING PRIVATE DECKS AND STAIRS OPENINGS 9. REFER TO WINDOW SCHEDULE FOR WINDOW STC RATINGS.
- 10. REFER TO MECHANICAL, PLUMBING, ELECTRICAL, AND STRUCTURAL DRAWINGS FOR ADDITIONAL INFORMATION. 11. FRAMING SUB-CONTRACTOR SHALL REVIEW AND COORDINATE EXTERIOR LIGHTING AND SIGNAGE LOCATIONS AND SHALL PROVIDE SOLID BLOCKING WHERE
- REQUIRED. 12. FAÇADE ACCESS PLAN SHALL BE PROVIDED BY OWNER TO COMPLY WITH OSHA REGULATIONS FOR BUILDING MAINTENANCE.
- 13. CONTRACTOR IS RESPONSIBLE FOR BRINGING ANY CONFLICTS AND/OR DISCREPANCIES TO THE ATTENTION OF THE ARCHITECT. 14. ALL LEVELS ARE TO TOP OF PLYWOOD SUBFLOOR OR TOP
- OF STRUCTURAL CONCRETE, U.O.N. 15. FOR DOOR AND WINDOW TYPES AND SIZES, SEE
- SCHEDULES AND LEGENDS ON A9.XX AND A9.XX. 16. SEE COLOR LEGEND ON SHEET **G0.XX** FOR PAINT SCHEDULE.

KEYNOTE LEGEND KEYNOTE NUMBER

BUILDING KEY PLAN

BUILDING 7 - EAST ELEVATION

1/8" = 1'-0"

[3] [4] [5] [6]

REVISION SCHEDULE

STAMP:

JOB NUMBER: DRAWN BY: CHECKED BY: DATE: SCALE: As indicated ELEVATIONS - BUILDING TYPE D

(BUILDING 7)

- 1. SEE SHEET **G0.00** FOR SYMBOLS & ABBREVIATIONS. 2. THESE ELEVATIONS SHOW OVERALL INFORMATION AND UNIT-TO-UNIT RELATIONSHIPS ONLY, SEE ENLARGED ELEVATIONS FOR INFORMATION NOT SHOWN.
- 3. ALL CONTROL JOINTS AND FINISH MATERIALS SHALL WRAP AROUND CORNERS AND CONTINUE ONTO ADJACENT WALLS WHETHER SHOWN OR NOT, UNLESS NOTED OTHERWISE. PER <u>ASTM C 1063</u> INSTALL CONTROL JOINTS WHERE AN EXPANSION JOINT OCCURS IN THE BASE EXTERIOR WALL. INSTALL CONTROL JOINTS WHERE CEILING FRAMING OR FURRING CHANGES DIRECTION.
- 4. PER ASTM C 1063, EXTERIOR PLASTER CONTROL JOINTS TO BE INSTALLED IN VERTICAL SURFACES EXCEEDING 144 SQUARE FEET IN AREA AND HORIZONTAL SURFACES EXCEEDING 100 SQUARE FEET IN AREA. DISTANCE BETWEEN CONTROL JOINTS SHALL NOT EXCEED 18 FEET IN EITHER DIRECTION OR A LENGTH-TO-WIDTH RATIO OF 2.5 TO

OAKLAND, CA 94612

www.pyatok.com

Suite 250

510.465.7010 p | 510.465.8575 f

MidPen H O U S I N G

MIDPEN HOUSING

303 Vintage Park Drive

Foster City, CA 94404

INDWWO

POINT

S

S

STAMP:

REVISION SCHEDULE

- 5. ALL WEEP SCREED LINES SHALL BE LEVEL AND STEP WITH ADJACENT GRADE. STEPPING OF WEEP SCREED TO OCCUR AT INSIDE CORNERS. BOTTOM EDGE OF WEEP SCREED SHALL BE INSTALLED NOT LESS THAN 1 INCH BELOW THE JOINT FORMED BY THE FOUNDATION AND FRAMING. NOSE OF SCREED SHALL BE PLACED 6 INCHES MINIMUM ABOVE GRADE OR 2 INCHES MINIMUM ABOVE PAVED SURFACE. 6. ALL WINDOW HEAD HEIGHTS TO BE X'-XX" FROM TOP OF
- SHEATHING AT WOOD STRUCTURE AND X'-XX" AT CONCRETE, TYPICAL, U.O.N. 7. ALL EXTERIOR WALL PENETRATIONS SHALL BE SEALED. 8. ALL GUTTERS SHALL BE LEVEL U.O.N. AND RAINWATER
- LEADERS SHALL VERTICALLY ALIGN WITH WALLS INCLUDING PRIVATE DECKS AND STAIRS OPENINGS 9. REFER TO WINDOW SCHEDULE FOR WINDOW STC RATINGS.
- 10. REFER TO MECHANICAL, PLUMBING, ELECTRICAL, AND STRUCTURAL DRAWINGS FOR ADDITIONAL INFORMATION. 11. FRAMING SUB-CONTRACTOR SHALL REVIEW AND COORDINATE EXTERIOR LIGHTING AND SIGNAGE LOCATIONS AND SHALL PROVIDE SOLID BLOCKING WHERE
- REQUIRED. 12. FAÇADE ACCESS PLAN SHALL BE PROVIDED BY OWNER TO COMPLY WITH OSHA REGULATIONS FOR BUILDING MAINTENANCE.
- 13. CONTRACTOR IS RESPONSIBLE FOR BRINGING ANY CONFLICTS AND/OR DISCREPANCIES TO THE ATTENTION OF THE ARCHITECT.
- 14. ALL LEVELS ARE TO TOP OF PLYWOOD SUBFLOOR OR TOP OF STRUCTURAL CONCRETE, U.O.N. 15. FOR DOOR AND WINDOW TYPES AND SIZES, SEE
- SCHEDULES AND LEGENDS ON A9.XX AND A9.XX. 16. SEE COLOR LEGEND ON SHEET **G0.XX** FOR PAINT SCHEDULE.

KEYNOTE LEGEND NUMBER KEYNOTE

[3] [4] [5] [6]

JOB NUMBER:

As indicated

ELEVATIONS - BUILDING TYPE E (BUILDING 8)

© 2023 PYATOK ARCHITECTURE & URBAN DESIGN

DRAWN BY: CHECKED BY: SCALE:

- 1. SEE SHEET **G0.00** FOR SYMBOLS & ABBREVIATIONS. 2. THESE ELEVATIONS SHOW OVERALL INFORMATION AND UNIT-TO-UNIT RELATIONSHIPS ONLY, SEE ENLARGED ELEVATIONS FOR INFORMATION NOT SHOWN.
- 3. ALL CONTROL JOINTS AND FINISH MATERIALS SHALL WRAP AROUND CORNERS AND CONTINUE ONTO ADJACENT WALLS WHETHER SHOWN OR NOT, UNLESS NOTED OTHERWISE. PER <u>ASTM C 1063</u> INSTALL CONTROL JOINTS WHERE AN EXPANSION JOINT OCCURS IN THE BASE EXTERIOR WALL. INSTALL CONTROL JOINTS WHERE CEILING FRAMING OR FURRING CHANGES DIRECTION.
- 4. PER ASTM C 1063, EXTERIOR PLASTER CONTROL JOINTS TO BE INSTALLED IN VERTICAL SURFACES EXCEEDING 144 SQUARE FEET IN AREA AND HORIZONTAL SURFACES EXCEEDING 100 SQUARE FEET IN AREA. DISTANCE BETWEEN CONTROL JOINTS SHALL NOT EXCEED 18 FEET IN EITHER DIRECTION OR A LENGTH-TO-WIDTH RATIO OF 2.5 TO
- 5. ALL WEEP SCREED LINES SHALL BE LEVEL AND STEP WITH ADJACENT GRADE. STEPPING OF WEEP SCREED TO OCCUR AT INSIDE CORNERS. BOTTOM EDGE OF WEEP SCREED SHALL BE INSTALLED NOT LESS THAN 1 INCH BELOW THE JOINT FORMED BY THE FOUNDATION AND FRAMING. NOSE OF SCREED SHALL BE PLACED 6 INCHES MINIMUM ABOVE GRADE OR 2 INCHES MINIMUM ABOVE PAVED SURFACE. 6. ALL WINDOW HEAD HEIGHTS TO BE X'-XX" FROM TOP OF
- SHEATHING AT WOOD STRUCTURE AND X'-XX" AT CONCRETE, TYPICAL, U.O.N. 7. ALL EXTERIOR WALL PENETRATIONS SHALL BE SEALED.
- 8. ALL GUTTERS SHALL BE LEVEL U.O.N. AND RAINWATER LEADERS SHALL VERTICALLY ALIGN WITH WALLS INCLUDING PRIVATE DECKS AND STAIRS OPENINGS 9. REFER TO WINDOW SCHEDULE FOR WINDOW STC RATINGS.
- 10. REFER TO MECHANICAL, PLUMBING, ELECTRICAL, AND STRUCTURAL DRAWINGS FOR ADDITIONAL INFORMATION. 11. FRAMING SUB-CONTRACTOR SHALL REVIEW AND COORDINATE EXTERIOR LIGHTING AND SIGNAGE LOCATIONS AND SHALL PROVIDE SOLID BLOCKING WHERE
- REQUIRED. 12. FAÇADE ACCESS PLAN SHALL BE PROVIDED BY OWNER TO
- COMPLY WITH OSHA REGULATIONS FOR BUILDING MAINTENANCE. 13. CONTRACTOR IS RESPONSIBLE FOR BRINGING ANY CONFLICTS AND/OR DISCREPANCIES TO THE ATTENTION OF
- THE ARCHITECT. 14. ALL LEVELS ARE TO TOP OF PLYWOOD SUBFLOOR OR TOP OF STRUCTURAL CONCRETE, U.O.N.
- 15. FOR DOOR AND WINDOW TYPES AND SIZES, SEE SCHEDULES AND LEGENDS ON A9.XX AND A9.XX. 16. SEE COLOR LEGEND ON SHEET **G0.XX** FOR PAINT

SCHEDULE.

KEYNOTE LEGEND NUMBER KEYNOTE

BUILDING KEY PLAN

[3] [4] [5] [6]

REVISION SCHEDULE NO. ISSUE DATE
4 CDP Resubmittal 12/01/23

STAMP:

OAKLAND, CA 94612

www.pyatok.com

Suite 250

510.465.7010 p | 510.465.8575 f

MidPen H O U S I N G

MIDPEN HOUSING

303 Vintage Park Drive

Foster City, CA 94404

NOWWO O

L


1

S

S

JOB NUMBER: DRAWN BY: CHECKED BY SCALE:

ELEVATIONS - BUILDING TYPE F (BUILDINGS 9-16)

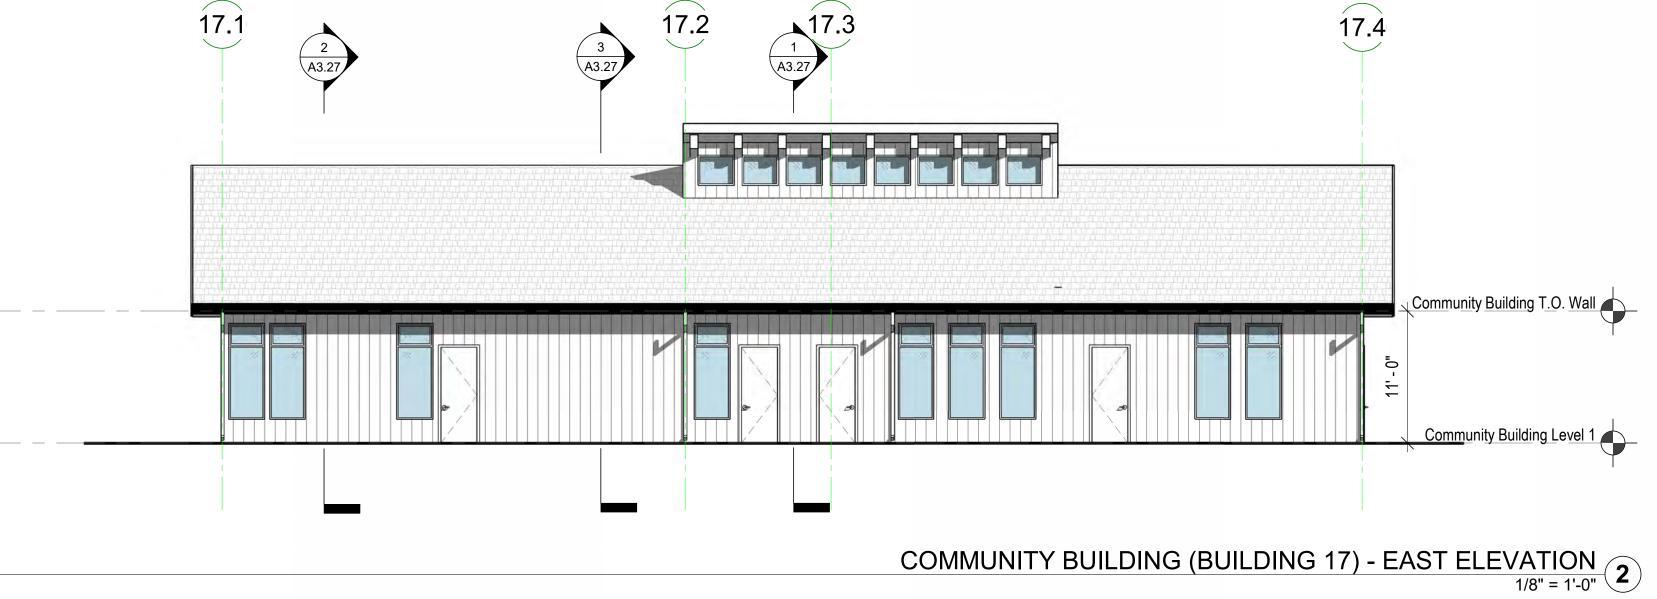



- 1. SEE SHEET **G0.00** FOR SYMBOLS & ABBREVIATIONS. 2. THESE ELEVATIONS SHOW OVERALL INFORMATION AND UNIT-TO-UNIT RELATIONSHIPS ONLY, SEE ENLARGED
- ELEVATIONS FOR INFORMATION NOT SHOWN. 3. ALL CONTROL JOINTS AND FINISH MATERIALS SHALL WRAP AROUND CORNERS AND CONTINUE ONTO ADJACENT WALLS WHETHER SHOWN OR NOT, UNLESS NOTED OTHERWISE. PER <u>ASTM C 1063</u> INSTALL CONTROL JOINTS WHERE AN EXPANSION JOINT OCCURS IN THE BASE EXTERIOR WALL. INSTALL CONTROL JOINTS WHERE CEILING FRAMING OR FURRING CHANGES DIRECTION.

OAKLAND, CA 94612

www.pyatok.com

Suite 250

510.465.7010 p | 510.465.8575 f

MIDPEN HOUSING

303 Vintage Park Drive

Foster City, CA 94404

INDMMO

POINT

S

YPRES

STAMP:

- 4. PER ASTM C 1063, EXTERIOR PLASTER CONTROL JOINTS TO BE INSTALLED IN VERTICAL SURFACES EXCEEDING 144 SQUARE FEET IN AREA AND HORIZONTAL SURFACES EXCEEDING 100 SQUARE FEET IN AREA. DISTANCE BETWEEN CONTROL JOINTS SHALL NOT EXCEED 18 FEET IN EITHER DIRECTION OR A LENGTH-TO-WIDTH RATIO OF 2.5 TO
- 5. ALL WEEP SCREED LINES SHALL BE LEVEL AND STEP WITH ADJACENT GRADE. STEPPING OF WEEP SCREED TO OCCUR AT INSIDE CORNERS. BOTTOM EDGE OF WEEP SCREED SHALL BE INSTALLED NOT LESS THAN 1 INCH BELOW THE JOINT FORMED BY THE FOUNDATION AND FRAMING. NOSE OF SCREED SHALL BE PLACED 6 INCHES MINIMUM ABOVE GRADE OR 2 INCHES MINIMUM ABOVE PAVED SURFACE.
- 6. ALL WINDOW HEAD HEIGHTS TO BE X'-XX" FROM TOP OF SHEATHING AT WOOD STRUCTURE AND X'-XX" AT CONCRETE, TYPICAL, U.O.N. 7. ALL EXTERIOR WALL PENETRATIONS SHALL BE SEALED.
- 8. ALL GUTTERS SHALL BE LEVEL U.O.N. AND RAINWATER LEADERS SHALL VERTICALLY ALIGN WITH WALLS INCLUDING PRIVATE DECKS AND STAIRS OPENINGS 9. REFER TO WINDOW SCHEDULE FOR WINDOW STC RATINGS.
- 10. REFER TO MECHANICAL, PLUMBING, ELECTRICAL, AND STRUCTURAL DRAWINGS FOR ADDITIONAL INFORMATION. 11. FRAMING SUB-CONTRACTOR SHALL REVIEW AND COORDINATE EXTERIOR LIGHTING AND SIGNAGE LOCATIONS AND SHALL PROVIDE SOLID BLOCKING WHERE
- REQUIRED. 12. FAÇADE ACCESS PLAN SHALL BE PROVIDED BY OWNER TO COMPLY WITH OSHA REGULATIONS FOR BUILDING
- MAINTENANCE. 13. CONTRACTOR IS RESPONSIBLE FOR BRINGING ANY CONFLICTS AND/OR DISCREPANCIES TO THE ATTENTION OF
- THE ARCHITECT. 14. ALL LEVELS ARE TO TOP OF PLYWOOD SUBFLOOR OR TOP OF STRUCTURAL CONCRETE, U.O.N.
- 15. FOR DOOR AND WINDOW TYPES AND SIZES, SEE SCHEDULES AND LEGENDS ON A9.XX AND A9.XX. 16. SEE COLOR LEGEND ON SHEET **G0.XX** FOR PAINT SCHEDULE.


KEYNOTE LEGEND NUMBER KEYNOTE

[3] [4] [5] [6]

REVISION SCHEDULE

JOB NUMBER: DRAWN BY: CHECKED BY: SCALE: As indicated

ELEVATIONS - COMMUNITY BUILDING (BUILDING 17)

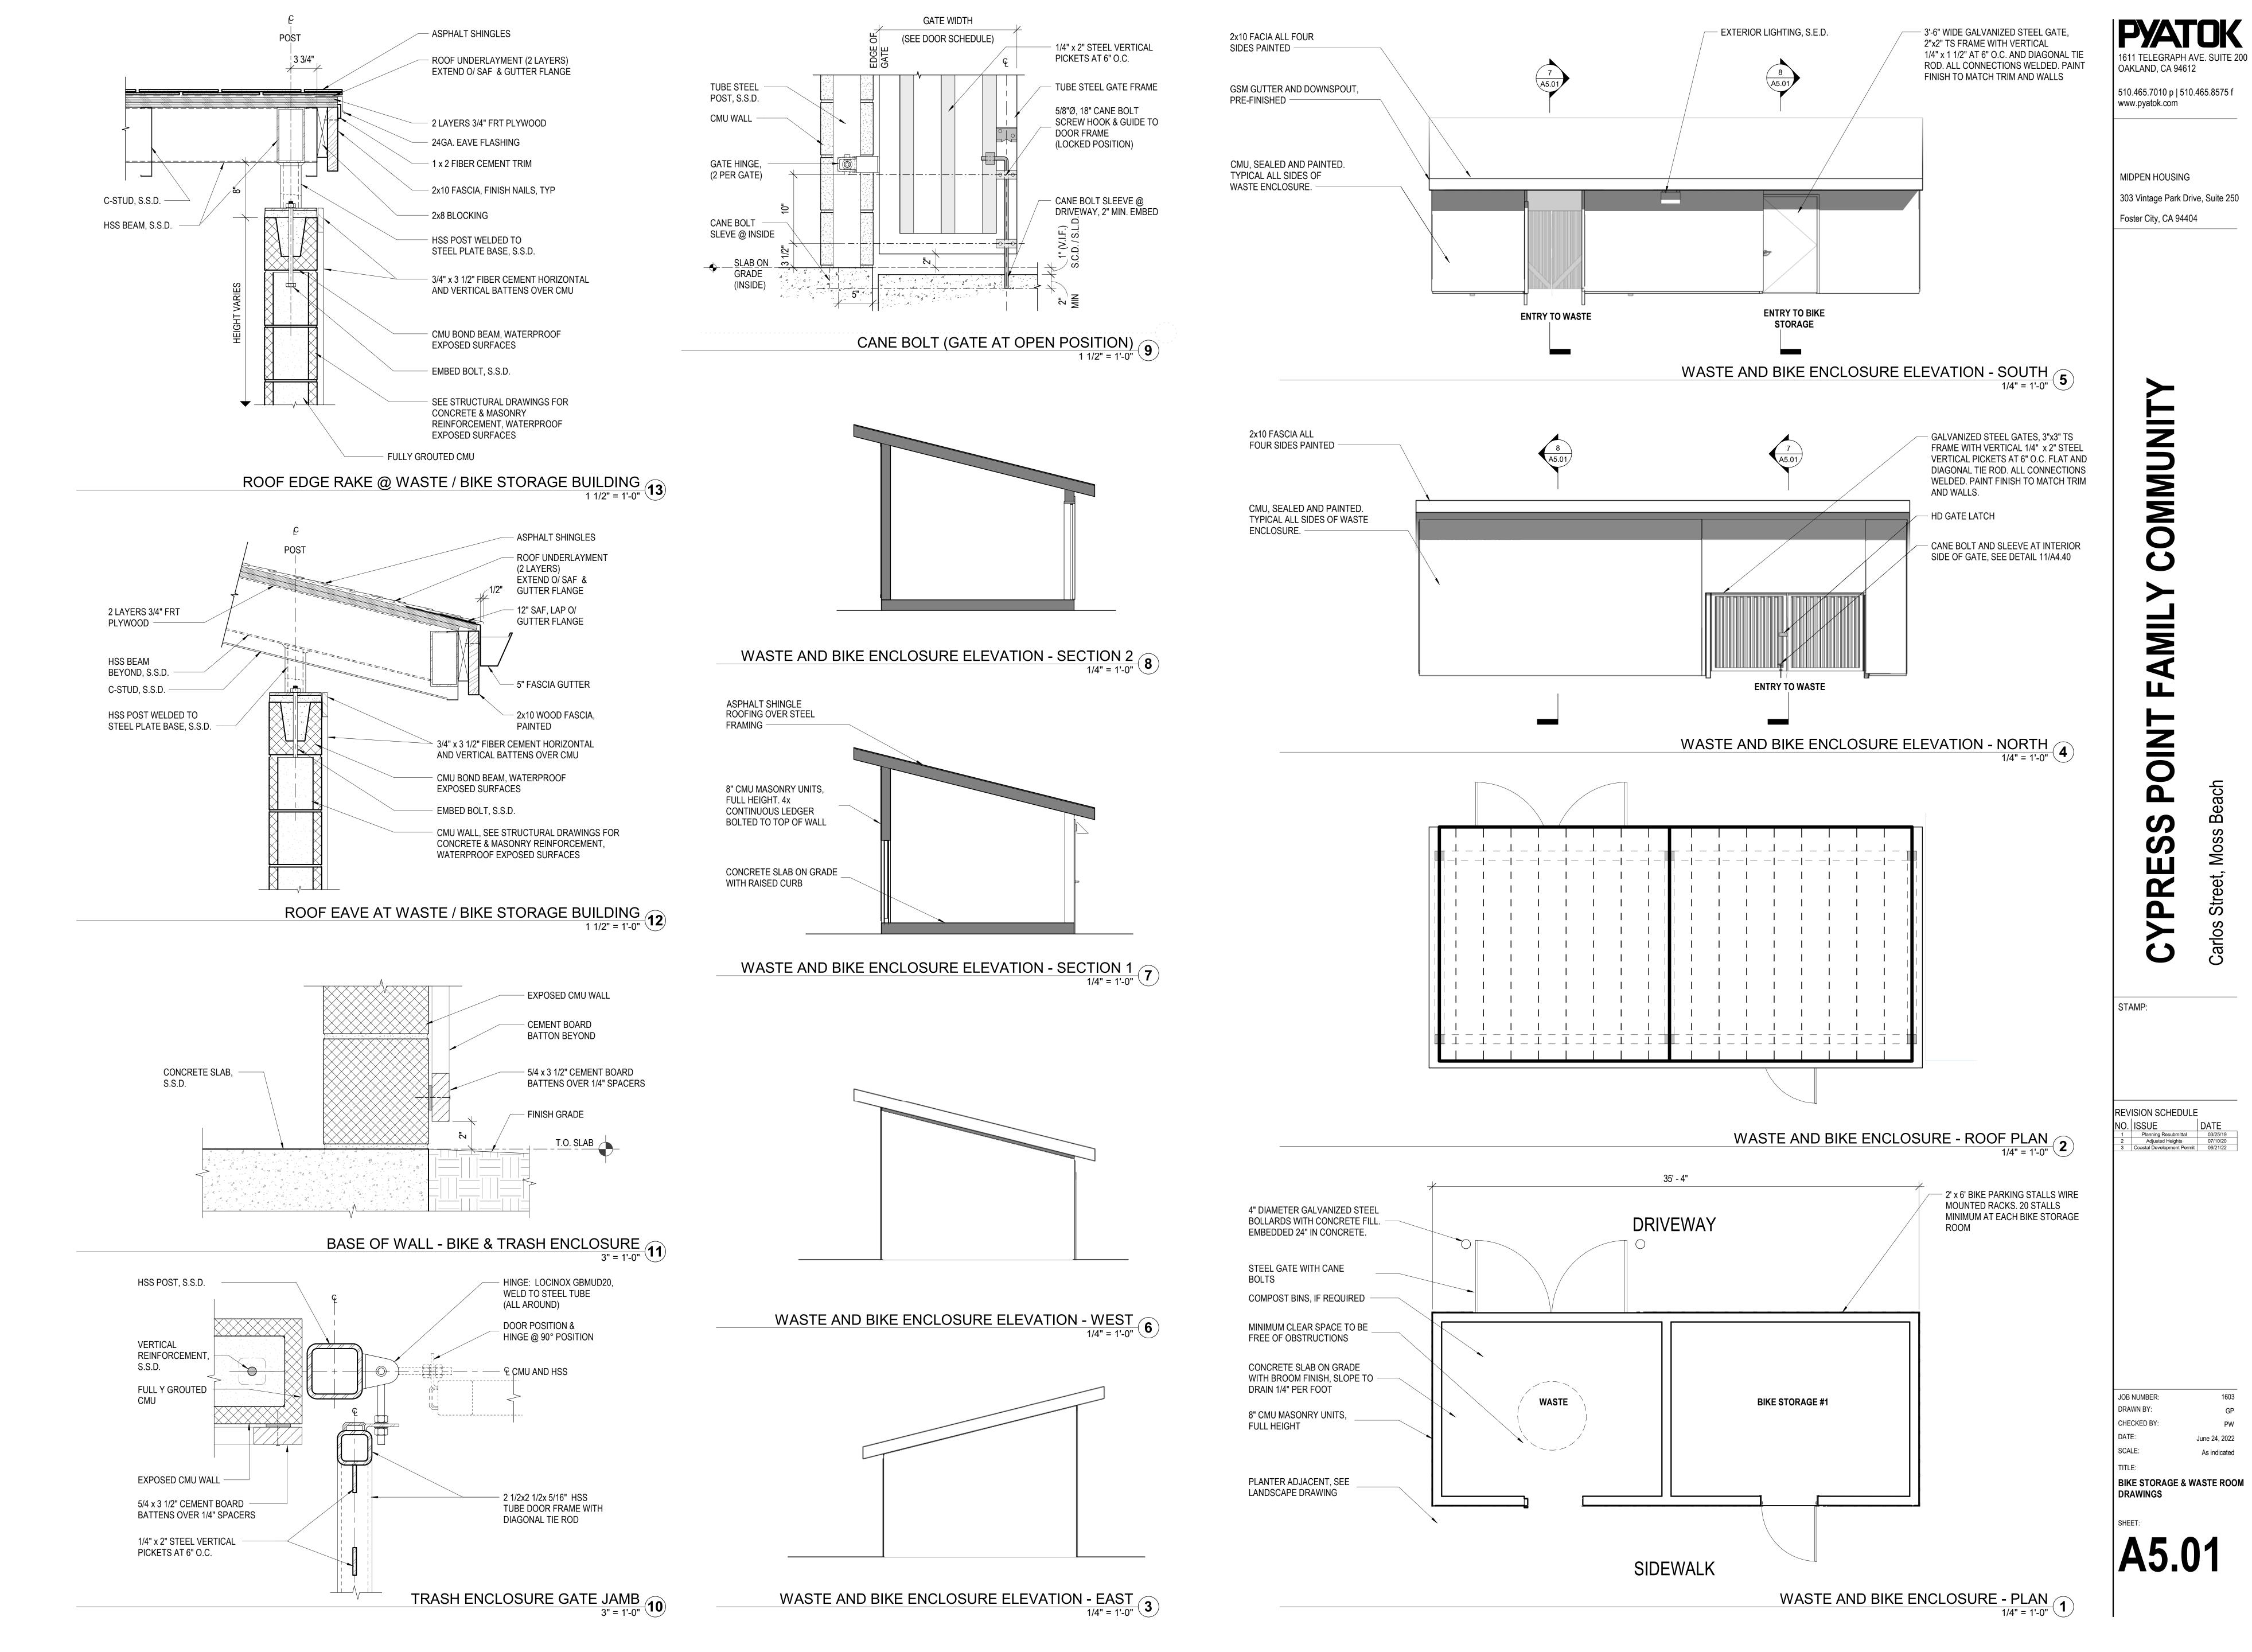

As indicated